# RENOVATION AND REPAIR OF GEORGE A. AYOTTE AND JOSEPH M. DOWNES PARKING FACILITIES

11 POST OFFICE SQUARE (AYOTTE) AND 75 JOHN ST (DOWNES) LOWELL, MA 01852

PREPARED FOR
CITY OF LOWELL
CITY HALL
375 MERRIMACK STREET, 3RD FLOOR
LOWELL, MA 01852

S001

S101

S102

S103

S104

S105

STRUCTURAL NOTES


JOSEPH M. DOWNES GARAGE LOWER LEVEL PLAN

JOSEPH M. DOWNES GARAGE FIRST LEVEL PLAN

JOSEPH M. DOWNES GARAGE SECOND LEVEL PLAN

JOSEPH M. DOWNES GARAGE UNDERSIDE OF FIRST LEVEL PLAN


JOSEPH M. DOWNES GARAGE UNDERSIDE OF SECOND LEVEL PLAN

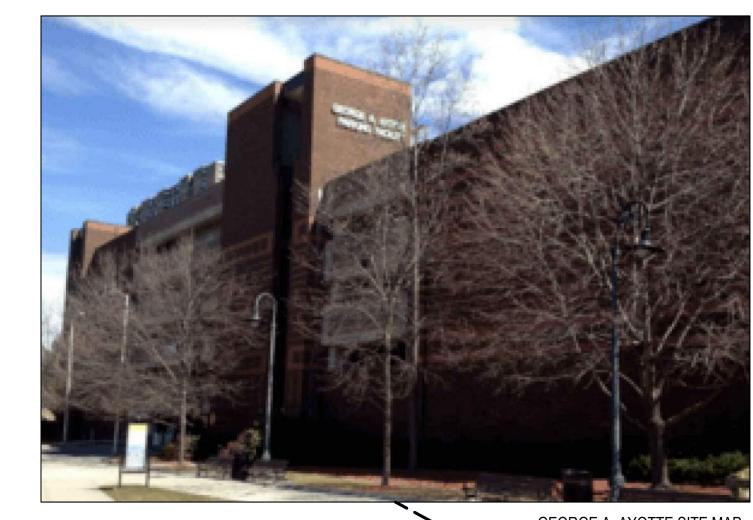

**ELECTRICAL LEGEND & GENERAL NOTES** 

DOWNES GARAGE - LEVEL 1 - ELECTRICAL PLAN

AYOTTE GARAGE - LEVEL 2 - ELECTRICAL PLAN

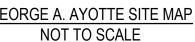




JOSEPH M. DOWNES SITE NOT TO SCALE

DRAWING NO	TITLE	DRAWING NO	TITLE
G100	COVER SHEET	S106	JOSEPH M. DOWNES GARAGE UNDERSIDE OF THIRD LEVEL PLAN
A101	PENTHOUSE ROOF AREA PLANS	S107	JOSEPH M. DOWNES GARAGE THIRD LEVEL PLAN
A201	JOSEPH M. DOWNES GARAGE ELEVATIONS	S108	JOSEPH M. DOWNES GARAGE GARAGE UNDERSIDE OF FOURTH LEVEL F
A202	JOSEPH M. DOWNES GARAGE ELEVATIONS	S109	JOSEPH M. DOWNES GARAGE FOURTH LEVEL PLAN
A203	JOSEPH M. DOWNES GARAGE ELEVATIONS	S110	JOSEPH M. DOWNES GARAGE UNDERSIDE OF FIFTH LEVEL PLAN
A204	JOSEPH M. DOWNES GARAGE ELEVATIONS	S111	JOSEPH M. DOWNES GARAGE FIFTH LEVEL PLAN
A205	JOSEPH M. DOWNES GARAGE ELEVATIONS	S112	JOSEPH M. DOWNES GARAGE UNDERSIDE OF ROOF LEVEL PLAN
A206	JOSEPH M. DOWNES GARAGE PENTHOUSE & HIDDEN ELEVATIONS	S113	JOSEPH M. DOWNES GARAGE SIXTH LEVEL PLAN
A207	JOSEPH M. DOWNES GARAGE ELEVATIONS	S114	GEORGE A. AYOTTE GARAGE GROUND FLOOR PLAN
A208	GEORGE A. AYOTTE GARAGE ELEVATIONS	S115	GEORGE A. AYOTTE GARAGE UNDERSIDE OF SECOND FLOOR PLAN
A209	GEORGE A. AYOTTE GARAGE ELEVATIONS	S116	GEORGE A. AYOTTE GARAGE SECOND FLOOR PLAN
A210	GEORGE A. AYOTTE GARAGE ELEVATIONS	S117	GEORGE A. AYOTTE GARAGE UNDERSIDE OF THIRD FLOOR PLAN
A211	GEORGE A. AYOTTE GARAGE PENTHOUSE ELEVATIONS	S118	GEORGE A. AYOTTE GARAGE THIRD FLOOR PLAN
A212	GEORGE A. AYOTTE GARAGE PENTHOUSE ELEVATIONS	S119	GEORGE A. AYOTTE GARAGE UNDERSIDE OF FOURTH FLOOR PLAN
A213	GEORGE A. AYOTTE GARAGE PENTHOUSE ELEVATIONS	S120	GEORGE A. AYOTTE GARAGE FOURTH FLOOR PLAN
A214	GEORGE A. AYOTTE GARAGE PENTHOUSE ELEVATIONS	S121	GEORGE A. AYOTTE GARAGE UNDERSIDE OF FIFTH FLOOR PLAN
A215	JOSEPH M. DOWNES GARAGE STOREFRONT ELEVATIONS	S122	GEORGE A. AYOTTE GARAGE FIFTH FLOOR PLAN
A501	ROOF DETAILS	S123	GEORGE A. AYOTTE GARAGE UNDERSIDE OF SIXTH FLOOR PLAN
A502	ROOF DETAILS	S124	GEORGE A. AYOTTE GARAGE SIXTH FLOOR PLAN
A503	ROOF DETAILS	S501	STRUCTURAL DETAILS
A701	MASONRY DETAILS	S502	STRUCTURAL DETAILS
A801	STOREFRONT DETAILS	S503	STRUCTURAL DETAILS
A802	STOREFRONT DETAILS	S504	JOSEPH M. DOWNES GARAGE TEMPORARY SHORING DETAIL

E000

E101

E102

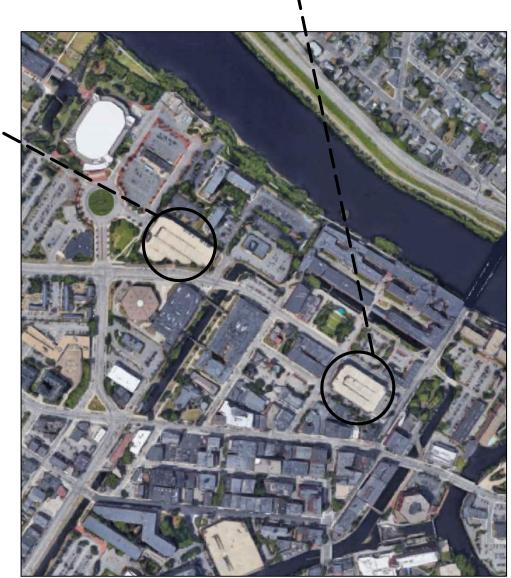

LOCATION MAP NOT TO SCALE

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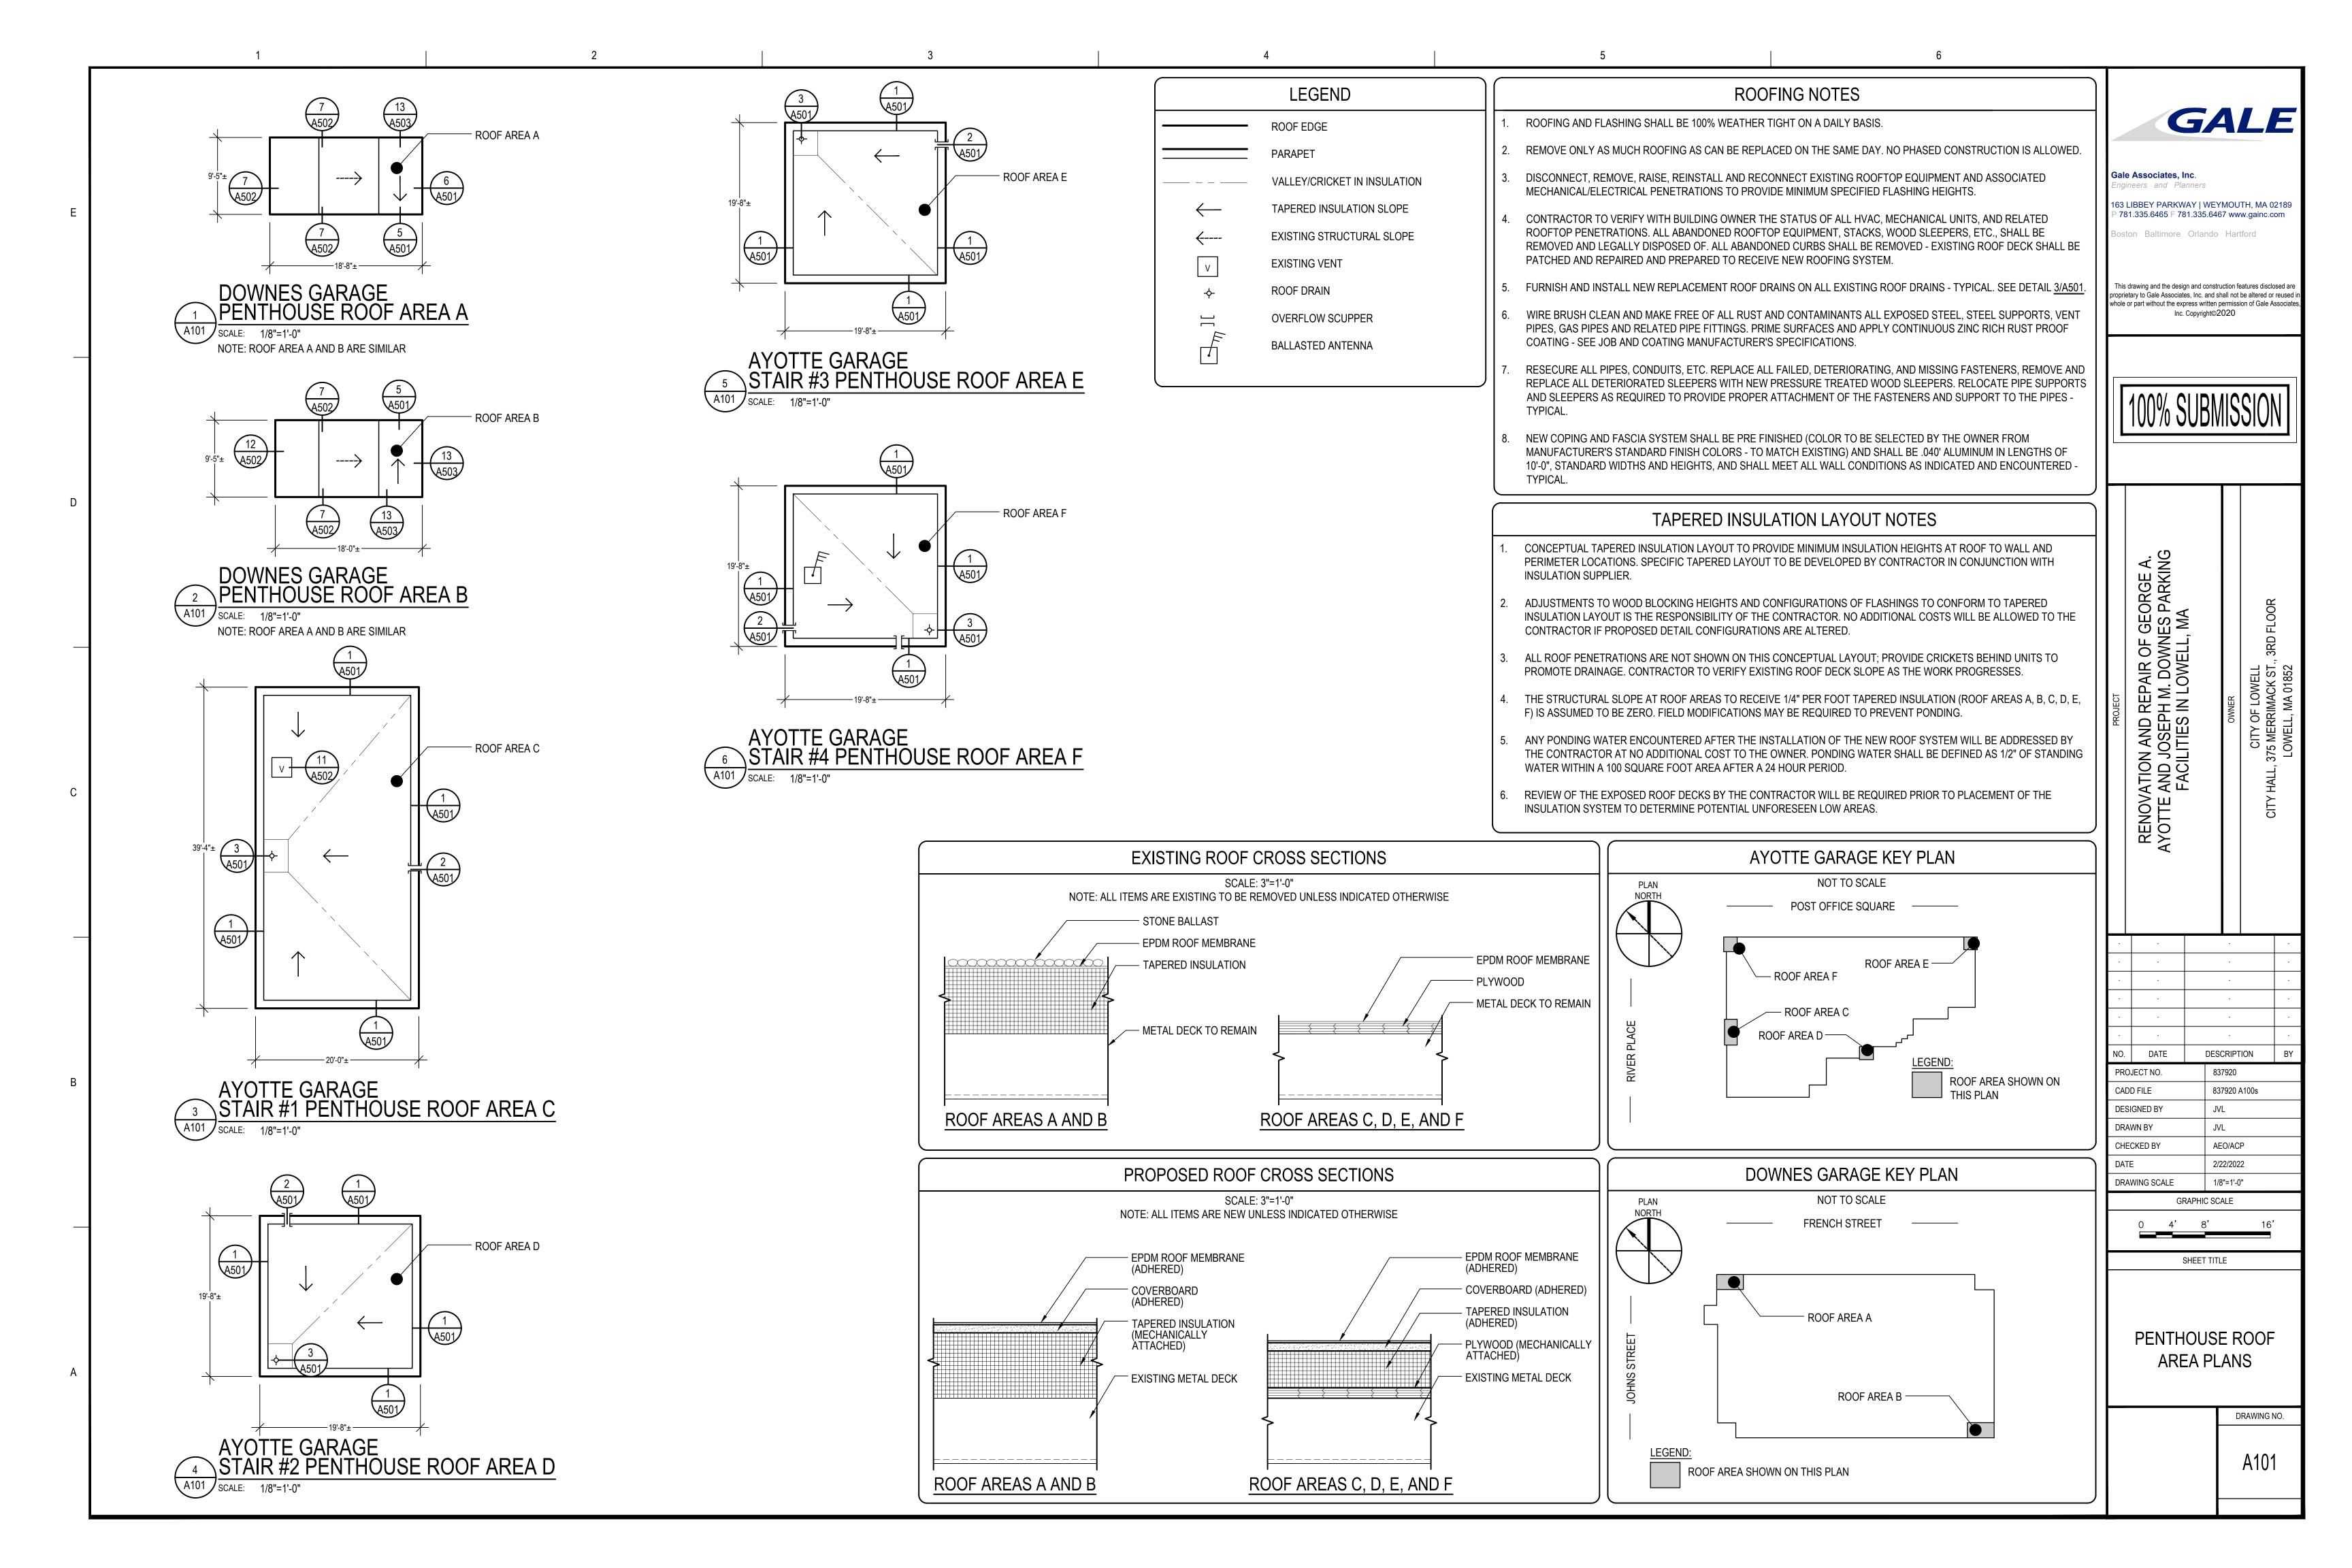
RENOVATION AND REPAIR OF GEORGE A. AYOTTE AND JOSEPH M. DOWNES PARKING FACILITIES IN LOWELL, MA
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10.	DATE	DESCRIPTION		BY
PRO.	JECT NO.		837920	
CADD FILE		837920 G100		
DESIGNED BY		KMC/JVL		
DRAWN BY		KMC/JVL		
CHECKED BY		AEO/ACP		
DATE		2/22/2022		
DRAWING SCALE		NOT TO SCALE		
07.17.110.00.11.7				

SHEET TITLE

**COVER SHEET** 

G100



METAL ELEMENTS AT **ELEVATOR TOWER TO BE** SCRAPED, PRIMED, AND PAINTED

JOSEPH M. DOWNES WEST ELEVATION A201 SCALE: NOT TO SCALE

**ELEVATION NOTES** 

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## REPAIR LEGEND

## **MASONRY**

EFFLORESCENCE TO BE CLEANED;

# INDICATES SQUARE FEET

# INDICATES SQUARE FEET

AG ALGAE GROWTH TO BE CLEANED;

RS RUST STAINING TO BE CLEANED;

# INDICATES SQUARE FEET

ATMOSPHERIC STAINING TO BE

CLEANED; # INDICATES SQUARE FEET

EXISTING ANCHOR/METAL STUB TO BE

REMOVED AND VOID IN BRICK OR

BRICK MASONRY TO BE REBUILT;

**SEALANTS** 

REPAIRED, REFER TO DETAIL 7/S501;

FAILED SEALANT TO BE REPAIRED,

PS FAILED PERIMETER SEALANT TO BE

# INDICATES LINEAR FEET

REFER TO DETAIL 7/S501;

# INDICATES LINEAR FEET

SHEET NOTES

MORTAR TO BE PATCHED

BRICK MASONRY TO BE REBU # INDICATES SQUARE FEET

# INDICATES SQUARE FEET

VG VEGETATIVE GROWTH TO BE CLEANED;

- CB CRACKED BRICK TO BE REPLACED; # INDICATES UNITS
- SB SPALLED BRICK TO BE REPLACED; # / # INDICATES UNITS
- DETERIORATED MORTAR JOINT TO BE REPOINTED, REFER TO DETAIL 1/A701; # INDICATES SQUARE FEET

DETERIORATED MORTAR JOINT TO BE REPOINTED, REFER TO DETAIL 1/A701;

STEP CRACK TO BE REPAIRED (APPROXIMATE SCALE); # INDICATES LINEAR FEET

# INDICATES LINEAR FEET

# CONCRETE

- CRACKED CONCRETE, REFER TO DETAIL 4/S501;
- # INDICATES LINEAR FEET DELAMINATING CONCRETE, REFER TO

DETAIL 1/S501;

- # INDICATES SQUARE FEET SPALLED CONCRETE, REFER TO DETAIL 1/S501; # INDICATES SQUARE FEET D = DEEP SPALL, REFER TO DETAIL
  - **PAINT**
- CLASS 3 PAINT DEFECT(PEELING PAINT);
  - DEFECT NOTE;
    REFER TO REPAIR NOTES SUBSTRATE TO BE SCRAPED, PRIMED,


## NOTE: NOT ALL DEFECTS SHOWN IN THE LEGEND MAY BE PRESENT ON THIS SHEET

## REPAIR NOTES

- REMOVE AND REPLACE EXISTING STOREFRONT; REFER TO A800s
- CONCRETE AND BRICK MASONRY STAIRS AT GARAGE ENTRANCE TO BE REBUILT
- SHIFTED STONE TO BE REMOVED AND RESET IN PLACE
- BRICK MASONRY TYPICALLY SPALLED; REBUILD BOTTOM THREE (3) COURSES; 4 APPROXIMATELY 1,000 SF
- DISPLACED/MISSING GASKET TO BE REPLACED; APPROXIMATELY 10 LF
- 6 INSTALL NEW THROUGHWALL FLASHING AT SOUTHWEST CORNER ABOVE METAL ROOF;
  APPROXIMATELY 8 LE REFER TO DETAIL 5/4701 APPROXIMATELY 8 LF. REFER TO DETAIL 5/A701
- REMOVE AND REPLACE EXISTING PENTHOUSE METAL WALL PANELS; REFER TO A500s

NOTE: REMOVE, TAG, STORE, AND REINSTALL EXISTING CONCRETE PARAPET CAPS WITH EPOXY COATED DOWELS INTO EXISTING MASONRY WALL AT THE JOSEPH M. DOWNES GARAGE. REPLACE DETERIORATED CAPSTONES TO MATCH EXISTING. REFER TO DETAIL 3/A701.

NOTE: MASONRY ELEVATIONS TO BE CLEANED 100%. SPECIFIC STAINING DEFECTS HAVE BEEN NOTED ON PLANS. THE REMAINING FACADE IS TO BE CLEANED TO REMOVE DIRT AND DEBRIS TO MATCH THE NEWLY CLEANED AREAS OF THE FACADE.

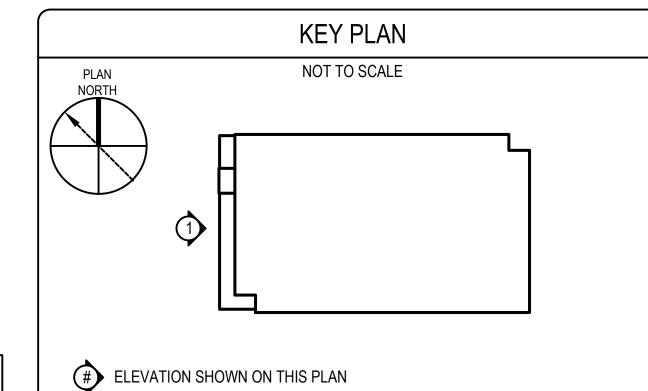

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IOVATION AND REPAIR OF GEORGE A. TE AND JOSEPH M. DOWNES PARKING FACILITIES IN LOWELL, MA REN AYOT

NO. DATE DESCRIPTION


PROJECT NO. 837920 CADD FILE 837920 A200s **DESIGNED BY** DRAWN BY ERS CHECKED BY AEO/ACP DATE 2/22/2022 DRAWING SCALE NOT TO SCALE GRAPHIC SCALE

SHEET TITLE

JOSEPH M. **DOWNES GARAGE ELEVATIONS** 

DRAWING NO.

JOSEPH M. DOWNES PARTIAL NORTH ELEVATION A202 SCALE: NOT TO SCALE

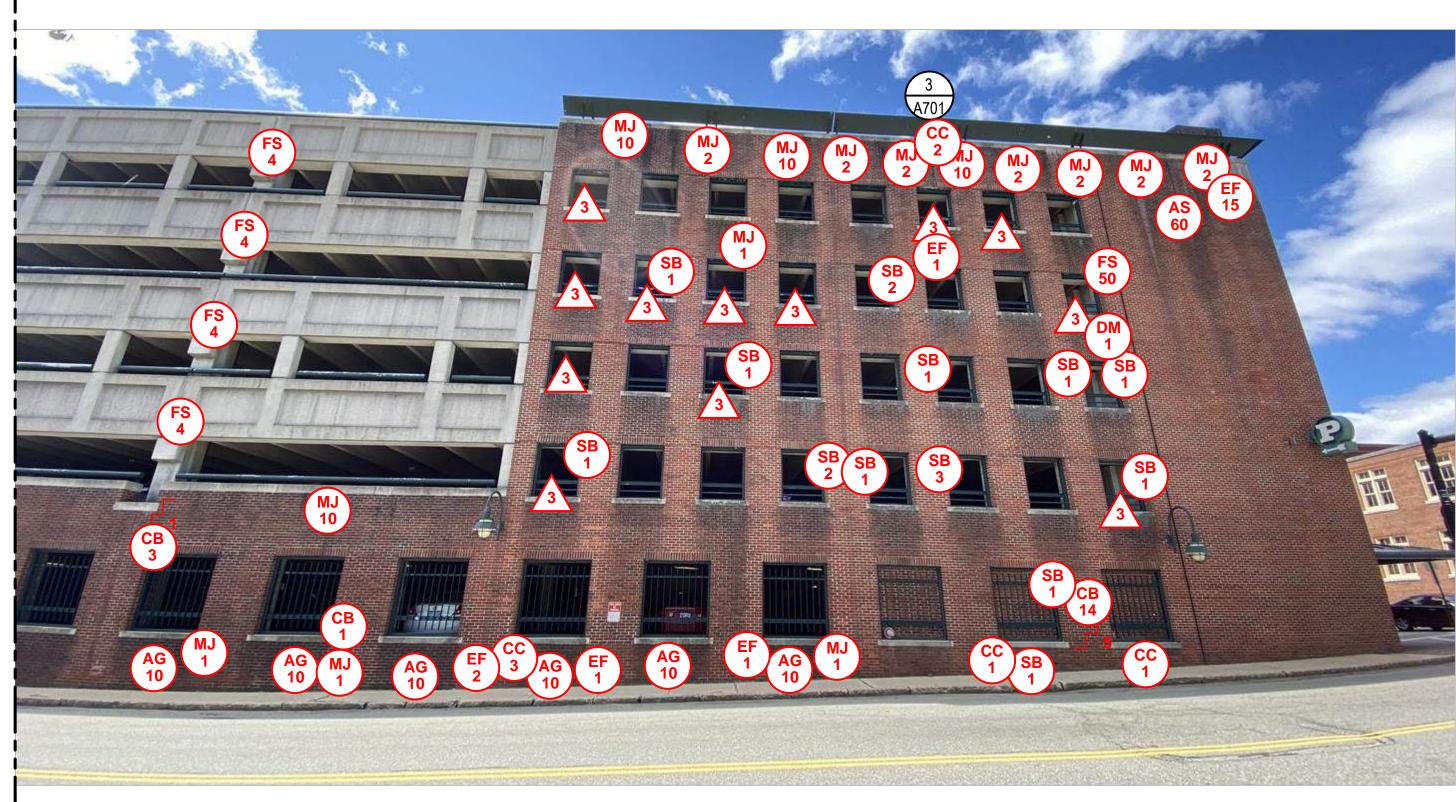

3 JOSEPH M. DOWNES PARTIAL NORTH ELEVATION A202 SCALE: NOT TO SCALE

**ELEVATION NOTES** 

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### REPAIR LEGEND

## **MASONRY**

FFLORESCENCE TO BE CLEANED;

VEGETATIVE GROWTH TO BE CLEANED;

# INDICATES SQUARE FEET

# INDICATES SQUARE FEET

AG ALGAE GROWTH TO BE CLEANED;

RS RUST STAINING TO BE CLEANED; # INDICATES SQUARE FEET

# INDICATES SQUARE FEET

ATMOSPHERIC STAINING TO BE

CLEANED; # INDICATES SQUARE FEET

EXISTING ANCHOR/METAL STUB TO BE

REMOVED AND VOID IN BRICK OR

BRICK MASONRY TO BE REBUILT;

**SEALANTS** 

REPAIRED, REFER TO DETAIL 7/S501;

FAILED SEALANT TO BE REPAIRED,

PS FAILED PERIMETER SEALANT TO BE

# INDICATES LINEAR FEET

REFER TO DETAIL 7/S501;

# INDICATES LINEAR FEET

SHEET NOTES

MORTAR TO BE PATCHED

BRICK MASONRY TO BE KEBU # INDICATES SQUARE FEET

- CB CRACKED BRICK TO BE REPLACED; # INDICATES UNITS
- SB SPALLED BRICK TO BE REPLACED; # / # INDICATES UNITS
- DETERIORATED MORTAR JOINT TO BE REPOINTED, REFER TO DETAIL 1/A701; # INDICATES SQUARE FEET
- DETERIORATED MORTAR JOINT TO BE REPOINTED, REFER TO DETAIL 1/A701; # INDICATES LINEAR FEET
- STEP CRACK TO BE REPAIRED (APPROXIMATE SCALE); # INDICATES LINEAR FEET

#### CONCRETE

- CRACKED CONCRETE, REFER TO DETAIL 4/S501; # INDICATES LINEAR FEET
- DELAMINATING CONCRETE, REFER TO DETAIL 1/S501; # INDICATES SQUARE FEET
- SPALLED CONCRETE, REFER TO DETAIL 1/S501; # INDICATES SQUARE FEET D = DEEP SPALL, REFER TO DETAIL
  - **PAINT**
- CLASS 3 PAINT DEFECT(PEELING PAINT); SUBSTRATE TO BE SCRAPED, PRIMED,
  - DEFECT NOTE;
    REFER TO REPAIR NOTES


AND PAINTED NOTE: NOT ALL DEFECTS SHOWN IN THE LEGEND MAY BE PRESENT ON THIS SHEET

## REPAIR NOTES

- REMOVE AND REPLACE EXISTING STOREFRONT; REFER TO A800s
- CONCRETE AND BRICK MASONRY STAIRS AT GARAGE ENTRANCE TO BE REBUILT
- SHIFTED STONE TO BE REMOVED AND RESET IN PLACE
- BRICK MASONRY TYPICALLY SPALLED; REBUILD BOTTOM THREE (3) COURSES; 4 APPROXIMATELY 1,000 SF
- DISPLACED/MISSING GASKET TO BE REPLACED; APPROXIMATELY 10 LF
- INSTALL NEW THROUGHWALL FLASHING AT SOUTHWEST CORNER ABOVE METAL ROOF; APPROXIMATELY 8 LF. REFER TO DETAIL 5/A701
- REMOVE AND REPLACE EXISTING PENTHOUSE METAL WALL PANELS; REFER TO A500s

NOTE: REMOVE, TAG, STORE, AND REINSTALL EXISTING CONCRETE PARAPET CAPS WITH EPOXY COATED DOWELS INTO EXISTING MASONRY WALL AT THE JOSEPH M. DOWNES GARAGE. REPLACE DETERIORATED CAPSTONES TO MATCH EXISTING. REFER TO DETAIL 3/A701.

NOTE: MASONRY ELEVATIONS TO BE CLEANED 100%. SPECIFIC STAINING DEFECTS HAVE BEEN NOTED ON PLANS. THE REMAINING FACADE IS TO BE CLEANED TO REMOVE DIRT AND DEBRIS TO MATCH THE NEWLY CLEANED AREAS OF THE FACADE.

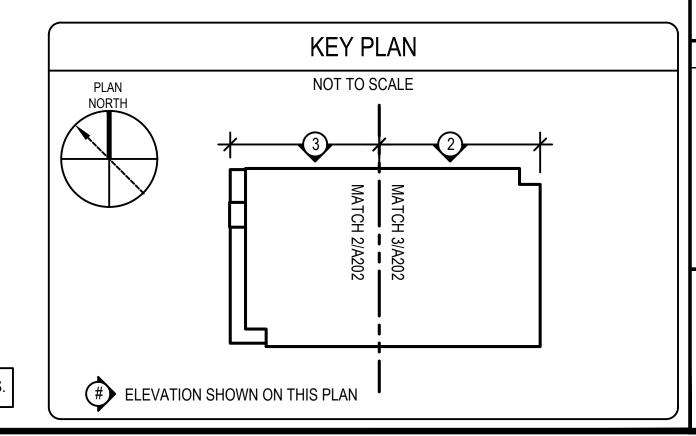

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IOVATION AND REPAIR OF GEORGE A. TE AND JOSEPH M. DOWNES PARKING FACILITIES IN LOWELL, MA

REN

DESCRIPTION PROJECT NO. 837920


CADD FILE 837920 A200s **DESIGNED BY** DRAWN BY ERS CHECKED BY AEO/ACP 2/22/2022 DRAWING SCALE NOT TO SCALE GRAPHIC SCALE

SHEET TITLE

JOSEPH M. DOWNES GARAGE **ELEVATIONS** 

DRAWING NO.

JOSEPH M. DOWNES PARTIAL EAST ELEVATION A203 SCALE: NOT TO SCALE

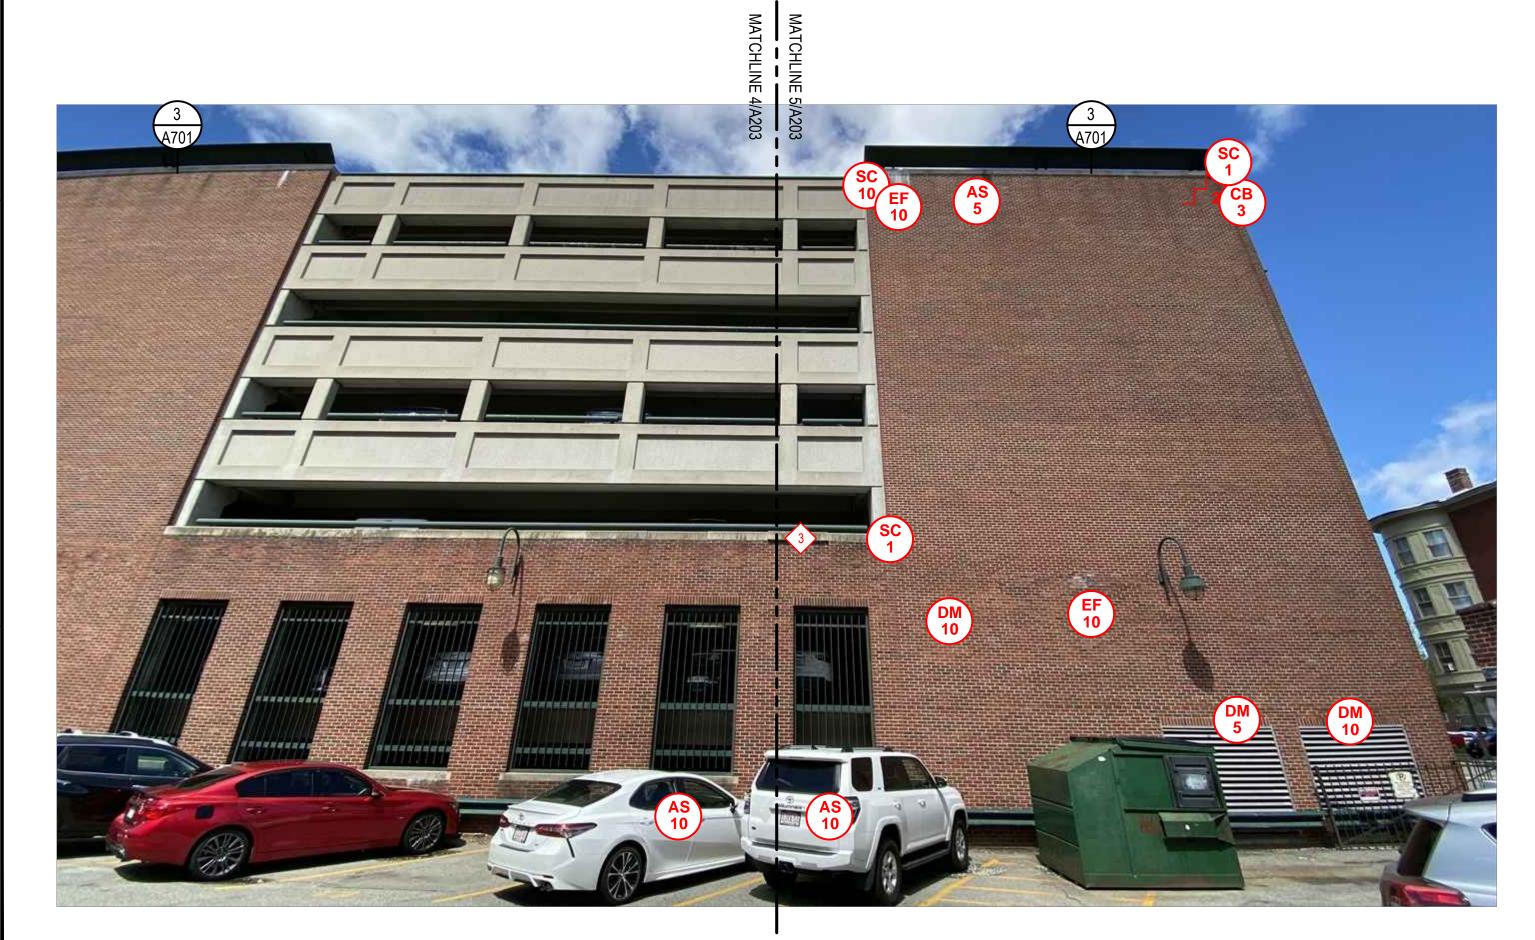

JOSEPH M. DOWNES PARTIAL EAST ELEVATION A203 SCALE: NOT TO SCALE

**ELEVATION NOTES** 

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# REPAIR LEGEND

\ EFFLORESCENCE TO BE CLEANED;

VEGETATIVE GROWTH TO BE CLEANED;

# INDICATES SQUARE FEET

# INDICATES SQUARE FEET

AG ALGAE GROWTH TO BE CLEANED;

RS RUST STAINING TO BE CLEANED; # INDICATES SQUARE FEET

# INDICATES SQUARE FEET

ATMOSPHERIC STAINING TO BE CLEANED; # INDICATES SQUARE FEET

EXISTING ANCHOR/METAL STUB TO BE

REMOVED AND VOID IN BRICK OR

BRICK MASONRY TO BE REBUILT;

**SEALANTS** 

 $^\prime$  REPAIRED, REFER TO DETAIL 7/S501;

FAILED SEALANT TO BE REPAIRED,

PS FAILED PERIMETER SEALANT TO BE

# INDICATES LINEAR FEET

REFER TO DETAIL 7/S501;

# INDICATES LINEAR FEET

SHEET NOTES


MORTAR TO BE PATCHED

BRICK MASONRY TO BE KEBU # INDICATES SQUARE FEET

## **MASONRY**

- CB CRACKED BRICK TO BE REPLACED; # INDICATES UNITS
- SB SPALLED BRICK TO BE REPLACED; # / # INDICATES UNITS
- DETERIORATED MORTAR JOINT TO BE REPOINTED, REFER TO DETAIL 1/A701; # INDICATES SQUARE FEET
- REPOINTED, REFER TO DETAIL 1/A701; # INDICATES LINEAR FEET

DETERIORATED MORTAR JOINT TO BE

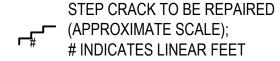

#### CONCRETE

- CRACKED CONCRETE, REFER TO DETAIL 4/S501; # INDICATES LINEAR FEET
- DELAMINATING CONCRETE, REFER TO DETAIL 1/S501; # INDICATES SQUARE FEET
- SPALLED CONCRETE, REFER TO DETAIL 1/S501; # INDICATES SQUARE FEET D = DEEP SPALL, REFER TO DETAIL
- **PAINT**
- CLASS 3 PAINT DEFECT(PEELING PAINT); SUBSTRATE TO BE SCRAPED, PRIMED, AND PAINTED


DEFECT NOTE;
REFER TO REPAIR NOTES NOTE: NOT ALL DEFECTS SHOWN IN THE LEGEND MAY BE PRESENT ON THIS SHEET

## REPAIR NOTES

- REMOVE AND REPLACE EXISTING STOREFRONT; REFER TO A800s
- CONCRETE AND BRICK MASONRY STAIRS AT GARAGE ENTRANCE TO BE REBUILT
- SHIFTED STONE TO BE REMOVED AND RESET IN PLACE
- BRICK MASONRY TYPICALLY SPALLED; REBUILD BOTTOM THREE (3) COURSES; 4 APPROXIMATELY 1,000 SF
- DISPLACED/MISSING GASKET TO BE REPLACED; APPROXIMATELY 10 LF
- 6 INSTALL NEW THROUGHWALL FLASHING AT SOUTHWEST CORNER ABOVE METAL ROOF; APPROXIMATELY 8 LF. REFER TO DETAIL 5/A701
- REMOVE AND REPLACE EXISTING PENTHOUSE METAL WALL PANELS; REFER TO A500s

NOTE: REMOVE, TAG, STORE, AND REINSTALL EXISTING CONCRETE PARAPET CAPS WITH EPOXY COATED DOWELS INTO EXISTING MASONRY WALL AT THE JOSEPH M. DOWNES GARAGE. REPLACE DETERIORATED CAPSTONES TO MATCH EXISTING. REFER TO DETAIL 3/A701.

NOTE: MASONRY ELEVATIONS TO BE CLEANED 100%. SPECIFIC STAINING DEFECTS HAVE BEEN NOTED ON PLANS. THE REMAINING FACADE IS TO BE CLEANED TO REMOVE DIRT AND DEBRIS TO MATCH THE NEWLY CLEANED AREAS OF THE FACADE.

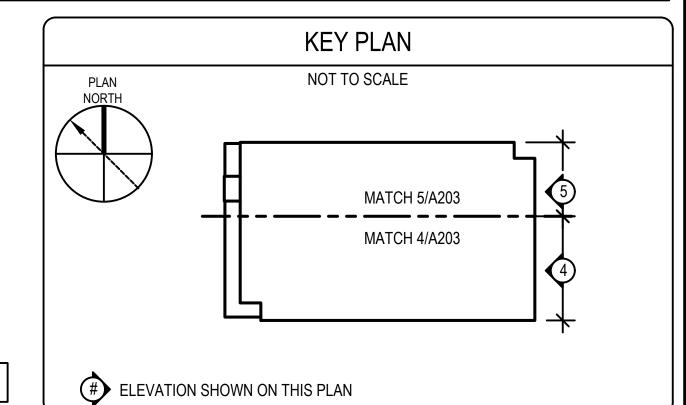

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IOVATION AND REPAIR OF GEORGE A. TE AND JOSEPH M. DOWNES PARKING FACILITIES IN LOWELL, MA

REN

NO. DATE DESCRIPTION

PROJECT NO. 837920 CADD FILE 837920 A200s **DESIGNED BY** DRAWN BY CHECKED BY AEO/ACP 2/22/2022 DRAWING SCALE NOT TO SCALE GRAPHIC SCALE

SHEET TITLE

JOSEPH M. DOWNES GARAGE

**ELEVATIONS** 

DRAWING NO.

\JOSEPH M. DOWNES PARTIAL SOUTH ELEVATION A204 SCALE: NOT TO SCALE

JOSEPH M. DOWNES PARTIAL SOUTH ELEVATION A204 SCALE: NOT TO SCALE

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### REPAIR LEGEND

## **MASONRY**

EFF EFFLORESCENCE TO BE CLEANED;

# INDICATES SQUARE FEET

# INDICATES SQUARE FEET

AG ALGAE GROWTH TO BE CLEANED;

RS RUST STAINING TO BE CLEANED: # INDICATES SQUARE FEET

# INDICATES SQUARE FEET

ATMOSPHERIC STAINING TO BE

CLEANED; # INDICATES SQUARE FEET

EXISTING ANCHOR/METAL STUB TO BE

REMOVED AND VOID IN BRICK OR

BRICK MASONRY TO BE REBUILT;

**SEALANTS** 

REPAIRED, REFER TO DETAIL 7/S501;

FAILED SEALANT TO BE REPAIRED,

PS FAILED PERIMETER SEALANT TO BE

# INDICATES LINEAR FEET

REFER TO DETAIL 7/S501;

# INDICATES LINEAR FEET

MORTAR TO BE PATCHED

BRICK MASONRY TO BE KEBU # INDICATES SQUARE FEET

VEGETATIVE GROWTH TO BE CLEANED;

CB CRACKED BRICK TO BE REPLACED; # INDICATES UNITS

SB \ SPALLED BRICK TO BE REPLACED; # / # INDICATES UNITS

REPOINTED, REFER TO DETAIL 1/A701; # INDICATES SQUARE FEET DETERIORATED MORTAR JOINT TO BE REPOINTED, REFER TO DETAIL 1/A701;

DETERIORATED MORTAR JOINT TO BE

STEP CRACK TO BE REPAIRED (APPROXIMATE SCALE); # INDICATES LINEAR FEET

# INDICATES LINEAR FEET

## CONCRETE

CRACKED CONCRETE, REFER TO DETAIL 4/S501; # INDICATES LINEAR FEET

DELAMINATING CONCRETE, REFER TO DETAIL 1/S501; # INDICATES SQUARE FEET

SPALLED CONCRETE, REFER TO DETAIL 1/S501; # INDICATES SQUARE FEET D = DEEP SPALL, REFER TO DETAIL

**PAINT** CLASS 3 PAINT DEFECT(PEELING PAINT); SUBSTRATE TO BE SCRAPED, PRIMED,

SHEET NOTES

DEFECT NOTE;
REFER TO REPAIR NOTES

REPAIR NOTES

NOTE: NOT ALL DEFECTS SHOWN IN THE LEGEND MAY BE PRESENT ON THIS SHEET

REMOVE AND REPLACE EXISTING STOREFRONT; REFER TO A800s

CONCRETE AND BRICK MASONRY STAIRS AT GARAGE ENTRANCE TO BE REBUILT

SHIFTED STONE TO BE REMOVED AND RESET IN PLACE

BRICK MASONRY TYPICALLY SPALLED; REBUILD BOTTOM THREE (3) COURSES; 4 APPROXIMATELY 1,000 SF


DISPLACED/MISSING GASKET TO BE REPLACED; APPROXIMATELY 10 LF

6 INSTALL NEW THROUGHWALL FLASHING AT SOUTHWEST CORNER ABOVE METAL ROOF; APPROXIMATELY 8 LF. REFER TO DETAIL 5/A701

REMOVE AND REPLACE EXISTING PENTHOUSE METAL WALL PANELS; REFER TO A500s

NOTE: REMOVE, TAG, STORE, AND REINSTALL EXISTING CONCRETE PARAPET CAPS WITH EPOXY COATED DOWELS INTO EXISTING MASONRY WALL AT THE JOSEPH M. DOWNES GARAGE. REPLACE DETERIORATED CAPSTONES TO MATCH EXISTING. REFER TO DETAIL 3/A701.

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OVATION AND REPAIR OF GEORGE A. TE AND JOSEPH M. DOWNES PARKING FACILITIES IN LOWELL, MA

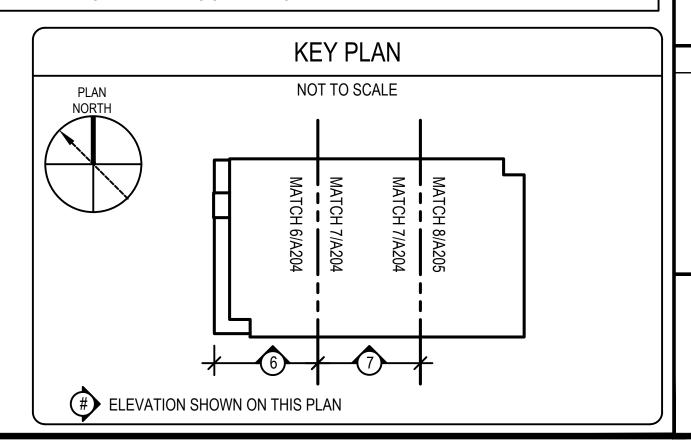REN AYOT

DESCRIPTION

PROJECT NO. 837920 CADD FILE 837920 A200s **DESIGNED BY** DRAWN BY CHECKED BY AEO/ACP 2/22/2022 DRAWING SCALE NOT TO SCALE

GRAPHIC SCALE


JOSEPH M.

**DOWNES GARAGE** 

**ELEVATIONS** 


SHEET TITLE

DRAWING NO.

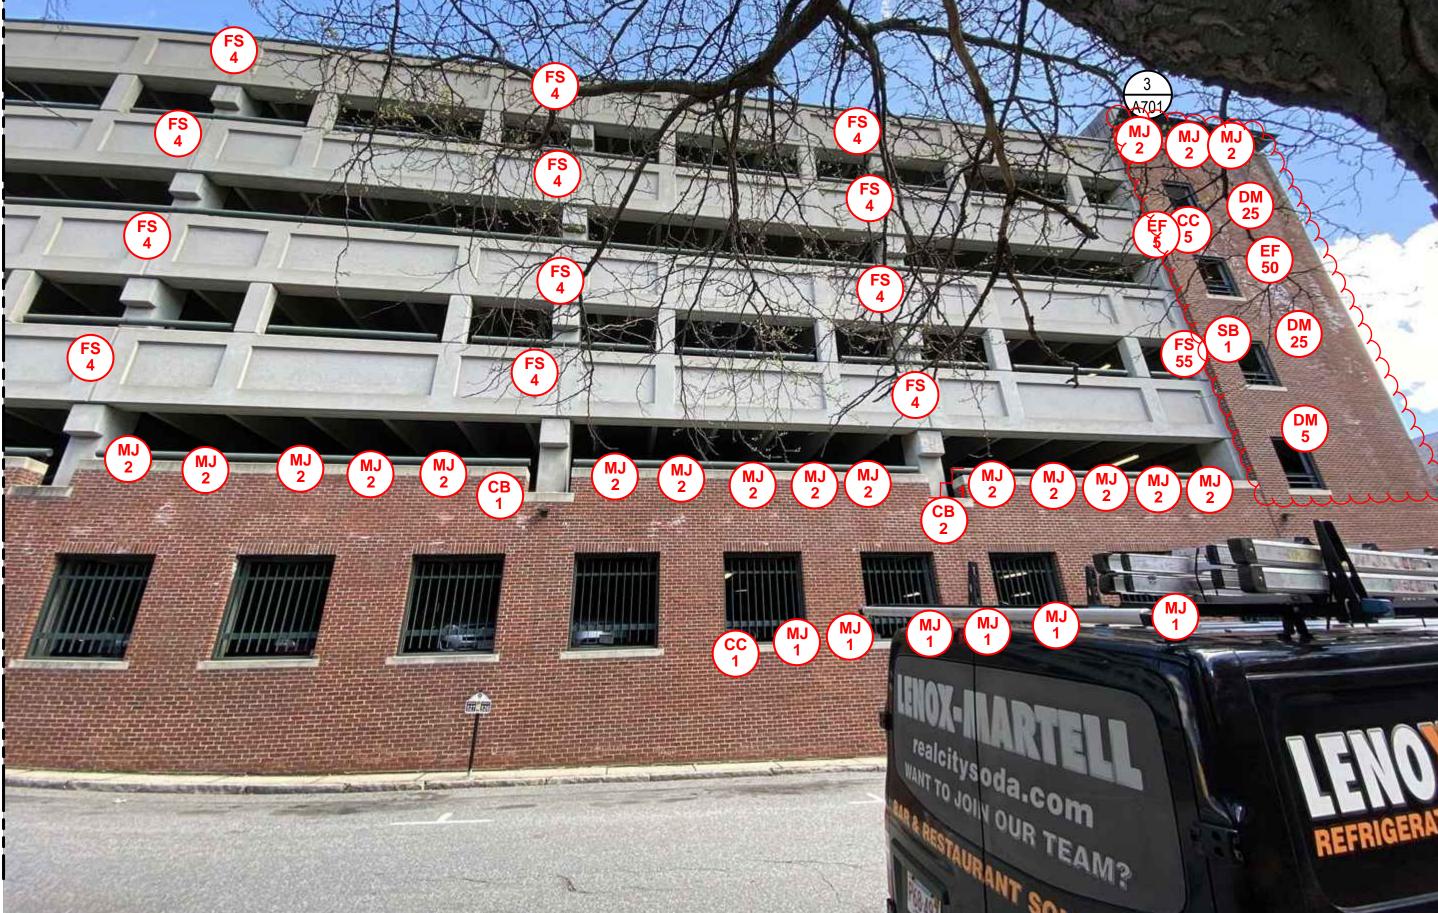

SECTION OF DISPLACED BRICK MASONRY WALL. INSTALL HELICAL TIES TO RESECURE DISPLACED MASONRY VENEER. APPROXIMATELY 500 SF. REFER TO DETAIL 4/A701

8 JOSEPH M. DOWNES PARTIAL SOUTH ELEVATION A205 SCALE: NOT TO SCALE

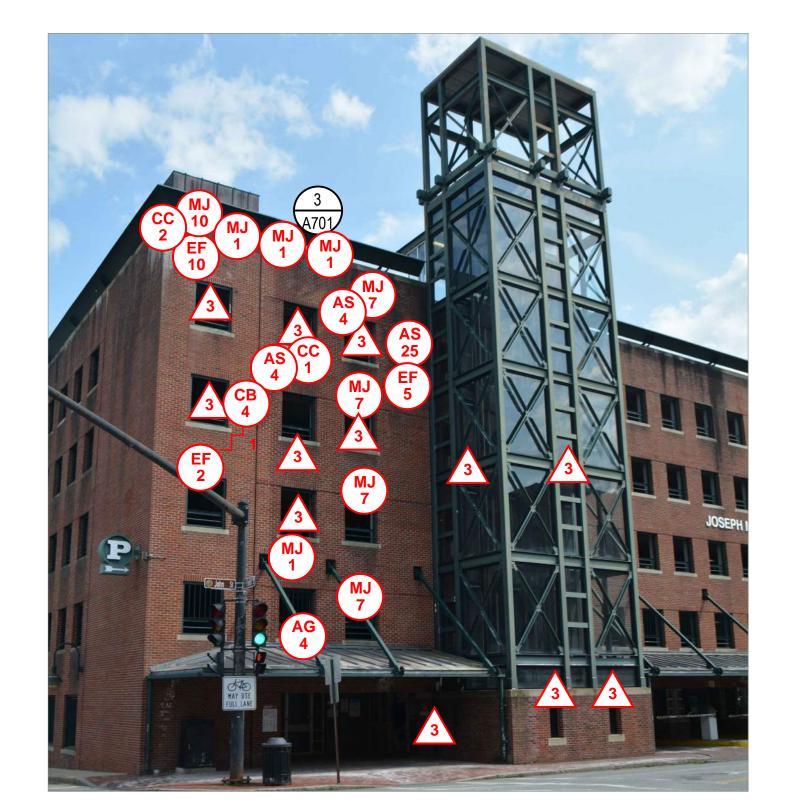

JOSEPH M. DOWNES PARTIAL WEST ELEVATION A205 SCALE: NOT TO SCALE



JOSEPH M. DOWNES HIDDEN ELEVATION A205 SCALE: NOT TO SCALE

**ELEVATION NOTES** 

THE INFORMATION SHOWN ON THIS DRAWING HAS BEEN COMPILED FROM VARIOUS SOURCES, AND MAY NOT REFLECT THE ACTUAL CONDITIONS AT THE TIME OF CONSTRUCTION.

DISCREPANCIES NOTED BY THE CONTRACTOR IN THE DRAWINGS OR SPECIFICATIONS MUST BE BROUGHT TO THE OWNER'S ATTENTION PRIOR TO BID SUBMISSION.

THE DEFECTS NOTED INDICATE APPROXIMATE LOCATIONS. THEY ARE NOT INTENDED TO DEFINE LIMITS OF WORK.

# REPAIR LEGEND

# MASONRY

EFFLORESCENCE TO BE CLEANED;

# INDICATES SQUARE FEET

AG ALGAE GROWTH TO BE CLEANED;

RS RUST STAINING TO BE CLEANED; # INDICATES SQUARE FEET

MORTAR TO BE PATCHED

BRICK MASONRY TO BE REBU # INDICATES SQUARE FEET

# INDICATES SQUARE FEET

ATMOSPHERIC STAINING TO BE CLEANED; # INDICATES SQUARE FEET

EXISTING ANCHOR/METAL STUB TO BE REMOVED AND VOID IN BRICK OR

BRICK MASONRY TO BE REBUILT;

REPAIRED, REFER TO DETAIL 7/S501;

FAILED SEALANT TO BE REPAIRED,

SHEET NOTES

**SEALANTS** 

PS FAILED PERIMETER SEALANT TO BE

# INDICATES LINEAR FEET

REFER TO DETAIL 7/S501;

# INDICATES LINEAR FEET

DEFECT NOTE;
REFER TO REPAIR NOTES

# INDICATES SQUARE FEET

VG VEGETATIVE GROWTH TO BE CLEANED;

- CB CRACKED BRICK TO BE REPLACED; # INDICATES UNITS
- SB SPALLED BRICK TO BE REPLACED; # / # INDICATES UNITS
- DETERIORATED MORTAR JOINT TO BE REPOINTED, REFER TO DETAIL 1/A701; # INDICATES SQUARE FEET
- DETERIORATED MORTAR JOINT TO BE REPOINTED, REFER TO DETAIL 1/A701; # INDICATES LINEAR FEET
- STEP CRACK TO BE REPAIRED (APPROXIMATE SCALE);
  # INDICATES LINEAD EEE # INDICATES LINEAR FEET

#### CONCRETE


- CRACKED CONCRETE, REFER TO DETAIL 4/S501; # INDICATES LINEAR FEET
- DELAMINATING CONCRETE, REFER TO DETAIL 1/S501; # INDICATES SQUARE FEET
- SPALLED CONCRETE, REFER TO DETAIL 1/S501; # INDICATES SQUARE FEET D = DEEP SPALL, REFER TO DETAIL
  - **PAINT**
- CLASS 3 PAINT DEFECT(PEELING PAINT);
- SUBSTRATE TO BE SCRAPED, PRIMED,
- NOTE: NOT ALL DEFECTS SHOWN IN THE LEGEND MAY BE PRESENT ON THIS SHEET

## REPAIR NOTES

- REMOVE AND REPLACE EXISTING STOREFRONT; REFER TO A800s
- CONCRETE AND BRICK MASONRY STAIRS AT GARAGE ENTRANCE TO BE REBUILT
- 3 SHIFTED STONE TO BE REMOVED AND RESET IN PLACE
- BRICK MASONRY TYPICALLY SPALLED; REBUILD BOTTOM THREE (3) COURSES; 4 APPROXIMATELY 1,000 SF
- DISPLACED/MISSING GASKET TO BE REPLACED; APPROXIMATELY 10 LF
- 6 INSTALL NEW THROUGHWALL FLASHING AT SOUTHWEST CORNER ABOVE METAL ROOF; APPROXIMATELY 8 LF. REFER TO DETAIL 5/A701
- REMOVE AND REPLACE EXISTING PENTHOUSE METAL WALL PANELS; REFER TO A500s

NOTE: REMOVE, TAG, STORE, AND REINSTALL EXISTING CONCRETE PARAPET CAPS WITH EPOXY COATED DOWELS INTO EXISTING MASONRY WALL AT THE JOSEPH M. DOWNES GARAGE. REPLACE DETERIORATED CAPSTONES TO MATCH EXISTING. REFER TO DETAIL 3/A701.

NOTE: MASONRY ELEVATIONS TO BE CLEANED 100%. SPECIFIC STAINING DEFECTS HAVE BEEN NOTED ON PLANS. THE REMAINING FACADE IS TO BE CLEANED TO REMOVE DIRT AND DEBRIS TO MATCH THE NEWLY CLEANED AREAS OF THE FACADE.

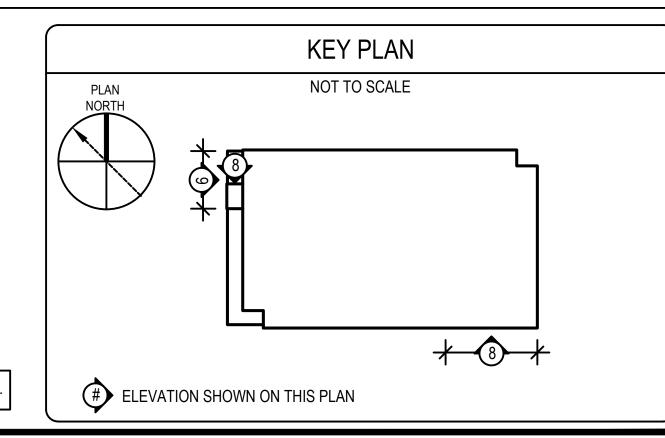

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OVATION AND REPAIR OF GEORGE A. TE AND JOSEPH M. DOWNES PARKING FACILITIES IN LOWELL, MA REN AYOT

DESCRIPTION

PROJECT NO. 837920 CADD FILE 837920 A200s **DESIGNED BY** DRAWN BY CHECKED BY AEO/ACP DRAWING SCALE NOT TO SCALE


GRAPHIC SCALE

SHEET TITLE

JOSEPH M. DOWNES GARAGE **ELEVATIONS** 


DRAWING NO.



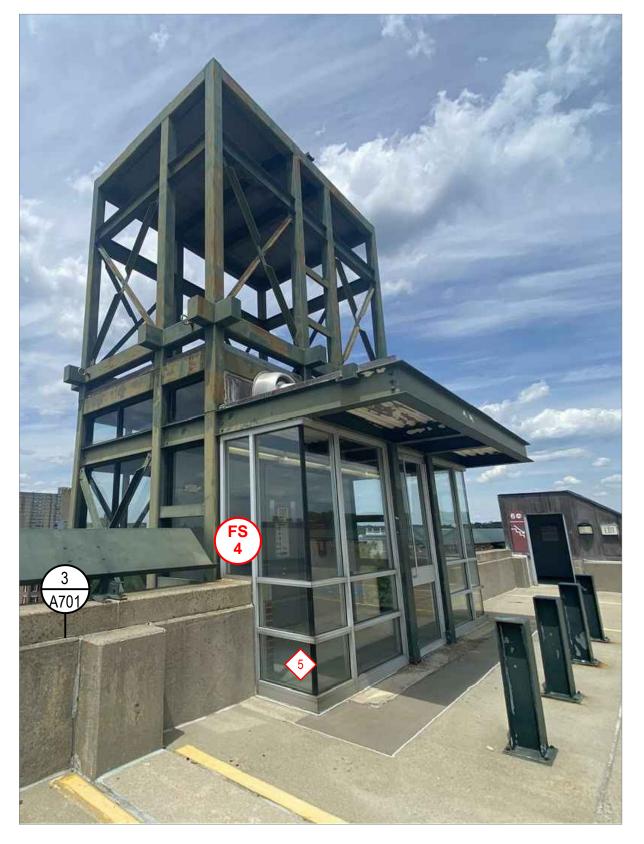


JOSEPH M. DOWNES

PENTHOUSE PARTIAL SOUTH ELEVATION A206 SCALE: NOT TO SCALE

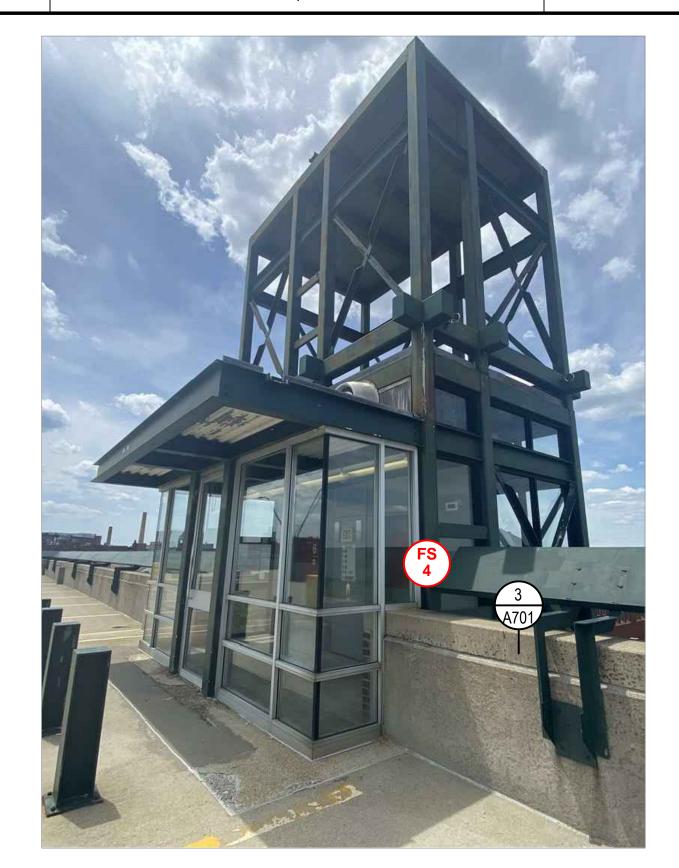


JOSEPH M. DOWNES

13 PENTHOUSE PARTIAL NORTH ELEVATION A206 SCALE: NOT TO SCALE

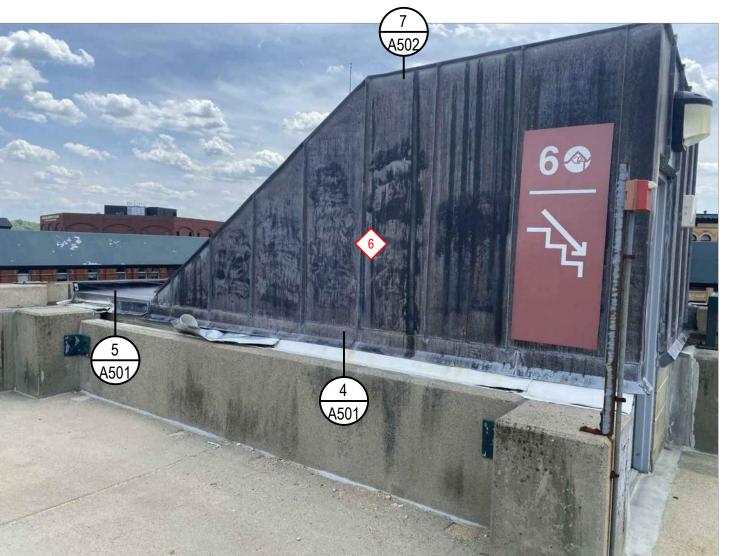


CONTRACTOR TO REMOVE AND REPLACE DETERIORATED INTERIOR FINISHES AT THE UNDERSIDE OF PENTHOUSE ROOF

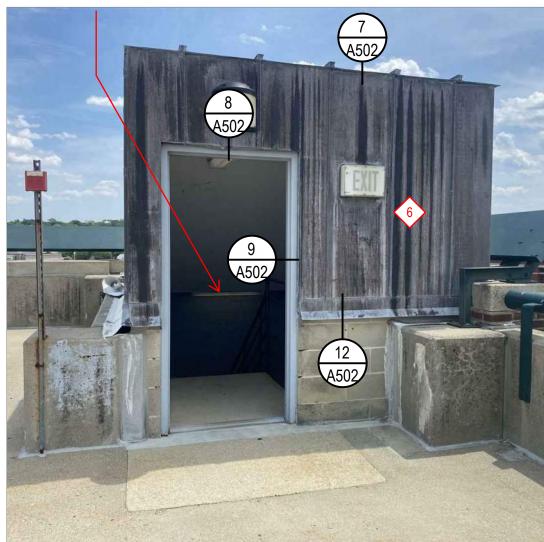

JOSEPH M. DOWNES

15 PENTHOUSE PARTIAL SOUTH ELEVATION

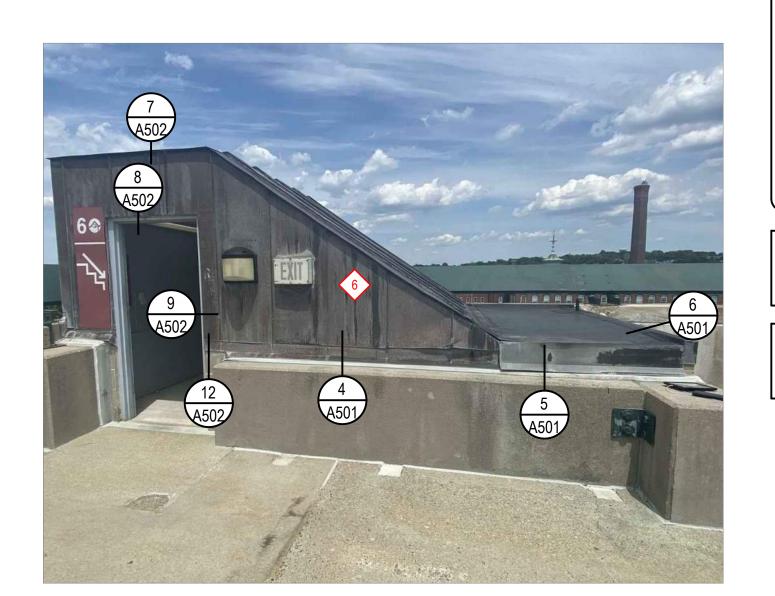

JOSEPH M. DOWNES

16 PENTHOUSE PARTIAL NORTH ELEVATION A206 SCALE: NOT TO SCALE

#### **ELEVATION NOTES**

- THE INFORMATION SHOWN ON THIS DRAWING HAS BEEN COMPILED FROM VARIOUS SOURCES, AND MAY NOT REFLECT THE ACTUAL CONDITIONS AT THE TIME OF CONSTRUCTION
- DISCREPANCIES NOTED BY THE CONTRACTOR IN THE DRAWINGS OR SPECIFICATIONS MUST BE BROUGHT TO THE OWNER'S ATTENTION PRIOR TO BID SUBMISSION.
- THE DEFECTS NOTED INDICATE APPROXIMATE LOCATIONS. THEY ARE NOT INTENDED TO DEFINE LIMITS OF WORK.

#### REPAIR LEGEND

#### **MASONRY**

- CRACKED BRICK TO BE REPLACED; # INDICATES UNITS
- SB SPALLED BRICK TO BE REPLACED; # INDICATES UNITS
- DETERIORATED MORTAR JOINT TO BE REPOINTED, REFER TO DETAIL 1/A701; # INDICATES SQUARE FEET
- DETERIORATED MORTAR JOINT TO BE REPOINTED, REFER TO DETAIL 1/A701; # INDICATES LINEAR FEET
- STEP CRACK TO BE REPAIRED (APPROXIMATE SCALE); # INDICATES LINEAR FEET

#### CONCRETE

- CRACKED CONCRETE, REFER TO DETAIL 4/S501; # INDICATES LINEAR FEET
- DELAMINATING CONCRETE, REFER TO **DETAIL 1/S501**; # INDICATES SQUARE FEET
- SPALLED CONCRETE, REFER TO DETAIL 1/S501; # INDICATES SQUARE FEET D = DEEP SPALL, REFER TO DETAIL
  - SHEET NOTES **PAINT**
- CLASS 3 PAINT DEFECT(PEELING PAINT); SUBSTRATE TO BE SCRAPED, PRIMED, AND PAINTED
  - DEFECT NOTE;
    REFER TO REPAIR NOTES

EFFLORESCENCE TO BE CLEANED;

VEGETATIVE GROWTH TO BE CLEANED;

# INDICATES SQUARE FEET

# INDICATES SQUARE FEET

# INDICATES SQUARE FEET

ATMOSPHERIC STAINING TO BE

MORTAR TO BE PATCHED

BRICK MASONRY TO BE REBUILT;
# INDICATES SQUARE FEET

# INDICATES LINEAR FEET

REFER TO DETAIL 7/S501;

# INDICATES LINEAR FEET

**SEALANTS** 

FAILED PERIMETER SEALANT TO BE

REPAIRED, REFER TO DETAIL 7/S501;

FAILED SEALANT TO BE REPAIRED,

CLEANED; # INDICATES SQUARE FEET

EXISTING ANCHOR/METAL STUB TO BE REMOVED AND VOID IN BRICK OR

AG ALGAE GROWTH TO BE CLEANED;

RS RUST STAINING TO BE CLEANED; # INDICATES SQUARE FEET

NOTE: NOT ALL DEFECTS SHOWN IN THE LEGEND MAY BE PRESENT ON THIS SHEET

#### REPAIR NOTES

- REMOVE AND REPLACE EXISTING STOREFRONT; REFER TO A800s
- CONCRETE AND BRICK MASONRY STAIRS AT GARAGE ENTRANCE TO BE REBUILT
- SHIFTED STONE TO BE REMOVED AND RESET IN PLACE
- BRICK MASONRY TYPICALLY SPALLED; REBUILD BOTTOM THREE (3) COURSES; APPROXIMATELY 1,000 SF
- DISPLACED/MISSING GASKET TO BE REPLACED; APPROXIMATELY 10 LF
- INSTALL NEW THROUGHWALL FLASHING AT SOUTHWEST CORNER ABOVE METAL ROOF; APPROXIMATELY 8 LF. REFER TO DETAIL 5/A701
- REMOVE AND REPLACE EXISTING PENTHOUSE METAL WALL PANELS; REFER TO A500s

NOTE: REMOVE, TAG, STORE, AND REINSTALL EXISTING CONCRETE PARAPET CAPS WITH EPOXY COATED DOWELS INTO EXISTING MASONRY WALL AT THE JOSEPH M. DOWNES GARAGE. REPLACE DETERIORATED CAPSTONES TO MATCH EXISTING. REFER TO DETAIL 3/A701

NOTE: MASONRY ELEVATIONS TO BE CLEANED 100%. SPECIFIC STAINING DEFECTS HAVE BEEN NOTED ON PLANS. THE REMAINING FACADE IS TO BE CLEANED TO REMOVE DIRT AND DEBRIS TO MATCH THE NEWLY CLEANED AREAS OF THE FACADE



NOT TO SCALE

# ELEVATION SHOWN ON THIS PLAN

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OVATION AND REPAIR OF GEORGE A. TE AND JOSEPH M. DOWNES PARKING FACILITIES IN LOWELL, MA REN AYOT

DESCRIPTION PROJECT NO. 837920

837920 A200s CADD FILE **DESIGNED BY** DRAWN BY CHECKED BY AEO/ACP 2/22/2022 NOT TO SCALE DRAWING SCALE

GRAPHIC SCALE

SHEET TITLE


JOSEPH M. DOWNES GARAGE PENTHOUSE AND HIDDEN ELEVATIONS

DRAWING NO.


JOSEPH M. DOWNES

14 PENTHOUSE EAST ELEVATION A206 SCALE: NOT TO SCALE

JOSEPH M. DOWNES PARTIAL SOUTH ELEVATION
SCALE: NOT TO SCALE

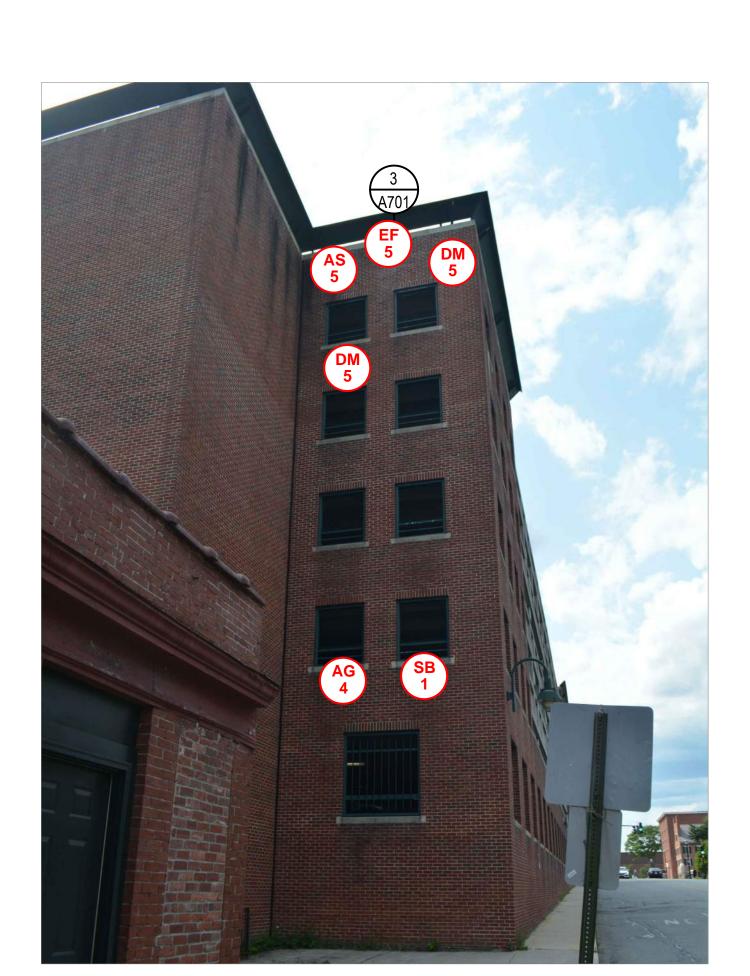


JOSEPH M. DOWNES PARTIAL NORTH ELEVATION
SCALE: NOT TO SCALE

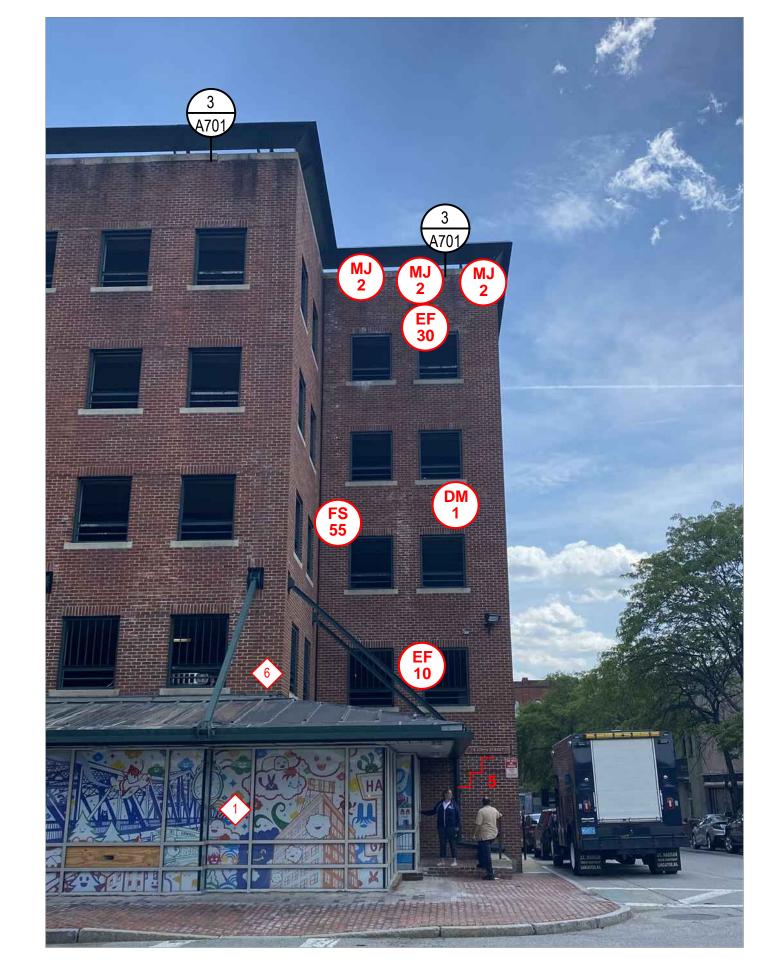

JOSEPH M. DOWNES PARTIAL WEST ELEVATION

SCALE: NOT TO SCALE

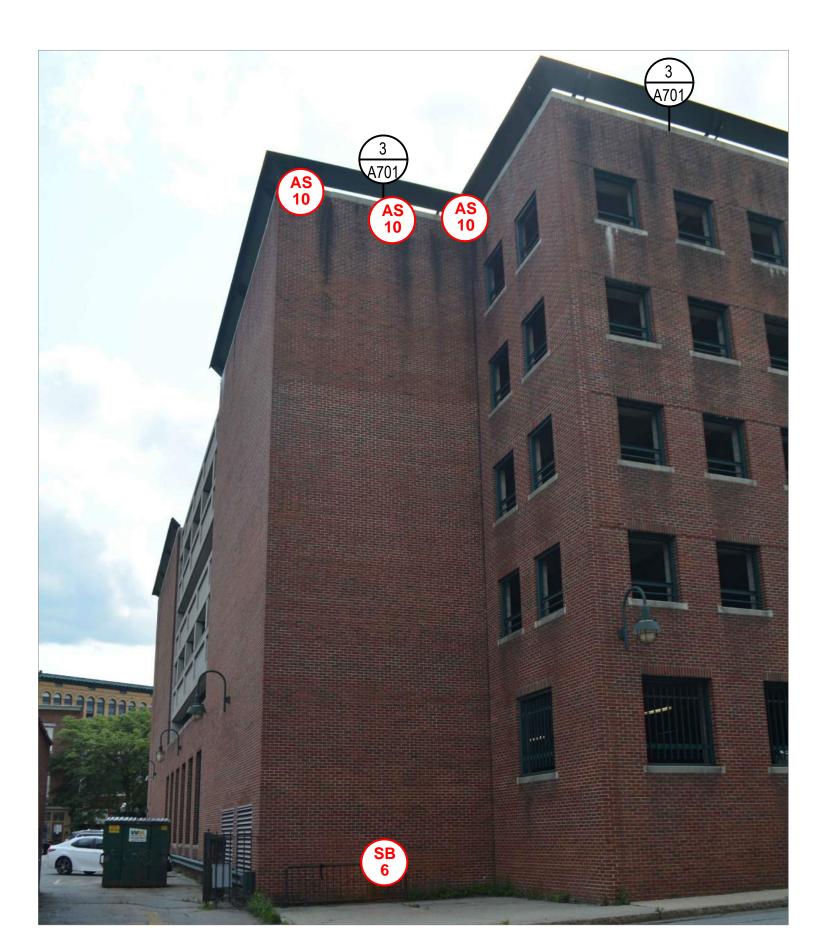

JOSEPH M. DOWNES PARTIAL EAST ELEVATION
SCALE: NOT TO SCALE

**ELEVATION NOTES** 

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2. DISCREPANCIES NOTED BY THE CONTRACTOR IN THE DRAWINGS OR SPECIFICATIONS MUST BE BROUGHT TO THE OWNER'S ATTENTION PRIOR TO BID SUBMISSION.

3. THE DEFECTS NOTED INDICATE APPROXIMATE LOCATIONS. THEY ARE NOT INTENDED TO DEFINE LIMITS OF WORK.

REPAIR LEGEND

MASONRY

EFFLORESCENCE TO BE CLEANED;

VG VEGETATIVE GROWTH TO BE CLEANED;

# INDICATES SQUARE FEET

# INDICATES SQUARE FEET

AG ALGAE GROWTH TO BE CLEANED;

RS RUST STAINING TO BE CLEANED; # INDICATES SQUARE FEET

# INDICATES SQUARE FEET

ATMOSPHERIC STAINING TO BE CLEANED; # INDICATES SQUARE FEET

EXISTING ANCHOR/METAL STUB TO BE

REMOVED AND VOID IN BRICK OR

MORTAR TO BE PATCHED

BRICK MASONRY TO BE REBUILT;
# INDICATES SQUARE FEET

# INDICATES LINEAR FEET

REFER TO DETAIL 7/S501;

# INDICATES LINEAR FEET

**SEALANTS** 

FAILED PERIMETER SEALANT TO BE

REPAIRED, REFER TO DETAIL 7/S501;

FAILED SEALANT TO BE REPAIRED,

SHEET NOTES

CB CRACKED BRICK TO BE REPLACED; # INDICATES UNITS

SB SPALLED BRICK TO BE REPLACED; # INDICATES UNITS

REPOINTED, REFER TO DETAIL 1/A701;
# INDICATES SQUARE FEET

DETERIORATED MORTAR JOINT TO BE

DETERIORATED MORTAR JOINT TO BE

REPOINTED, REFER TO DETAIL 1/A701;

STEP CRACK TO BE REPAIRED
(APPROXIMATE SCALE);
# INDICATES LINEAR FEET

# INDICATES LINEAR FEET

CONCRETE

CC CRACKED CONCRETE, REFER TO DETAIL 4/S501;
# INDICATES LINEAR FEET

DELAMINATING CONCRETE, REFER TO DETAIL 1/S501;
# INDICATES SQUARE FEET

SPALLED CONCRETE, REFER TO DETAIL
1/S501; # INDICATES SQUARE FEET
D = DEEP SPALL, REFER TO DETAIL
2/S501

PAINT

CLASS 3 PAINT DEFECT(PEELING PAINT);

CLASS 3 PAINT DEFECT(PEELING PAINT); SUBSTRATE TO BE SCRAPED, PRIMED, AND PAINTED

T); DEFECT NOTE;
REFER TO REPAIR NOTES

AND PAINTED

NOTE: NOT ALL DEFECTS SHOWN IN THE LEGEND MAY BE PRESENT ON THIS SHEET

REPAIR NOTES

REMOVE AND REPLACE EXISTING STOREFRONT; REFER TO A800s

CONCRETE AND BRICK MASONRY STAIRS AT GARAGE ENTRANCE TO BE REBUILT

SHIFTED STONE TO BE REMOVED AND RESET IN PLACE

BRICK MASONRY TYPICALLY SPALLED; REBUILD BOTTOM THREE (3) COURSES; APPROXIMATELY 1,000 SF


DISPLACED/MISSING GASKET TO BE REPLACED; APPROXIMATELY 10 LF

INSTALL NEW THROUGHWALL FLASHING AT SOUTHWEST CORNER ABOVE METAL ROOF;
APPROXIMATELY 8 LF. REFER TO DETAIL 5/A701

REMOVE AND REPLACE EXISTING PENTHOUSE METAL WALL PANELS; REFER TO A500s

NOTE: REMOVE, TAG, STORE, AND REINSTALL EXISTING CONCRETE PARAPET CAPS WITH EPOXY COATED DOWELS INTO EXISTING MASONRY WALL AT THE JOSEPH M. DOWNES GARAGE. REPLACE DETERIORATED CAPSTONES TO MATCH EXISTING. REFER TO DETAIL 3/A701.

NOTE: MASONRY ELEVATIONS TO BE CLEANED 100%. SPECIFIC STAINING DEFECTS HAVE BEEN NOTED ON PLANS. THE REMAINING FACADE IS TO BE CLEANED TO REMOVE DIRT AND DEBRIS TO MATCH THE NEWLY CLEANED AREAS OF THE FACADE.

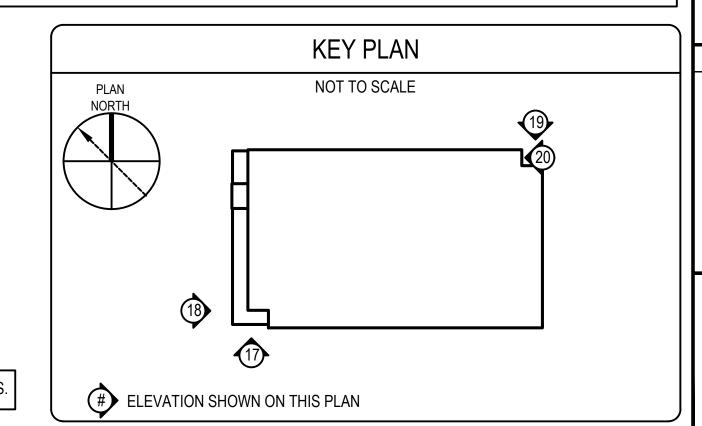

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100% SUBMISSION

RENOVATION AND REPAIR OF GEORGE A.
AYOTTE AND JOSEPH M. DOWNES PARKING
FACILITIES IN LOWELL, MA

PROJECT NO. 837920

CADD FILE 837920 A200s

DESIGNED BY JVL

DRAWN BY ERS

CHECKED BY AEO/ACP

DATE 2/22/2022

DRAWING SCALE NOT TO SCALE


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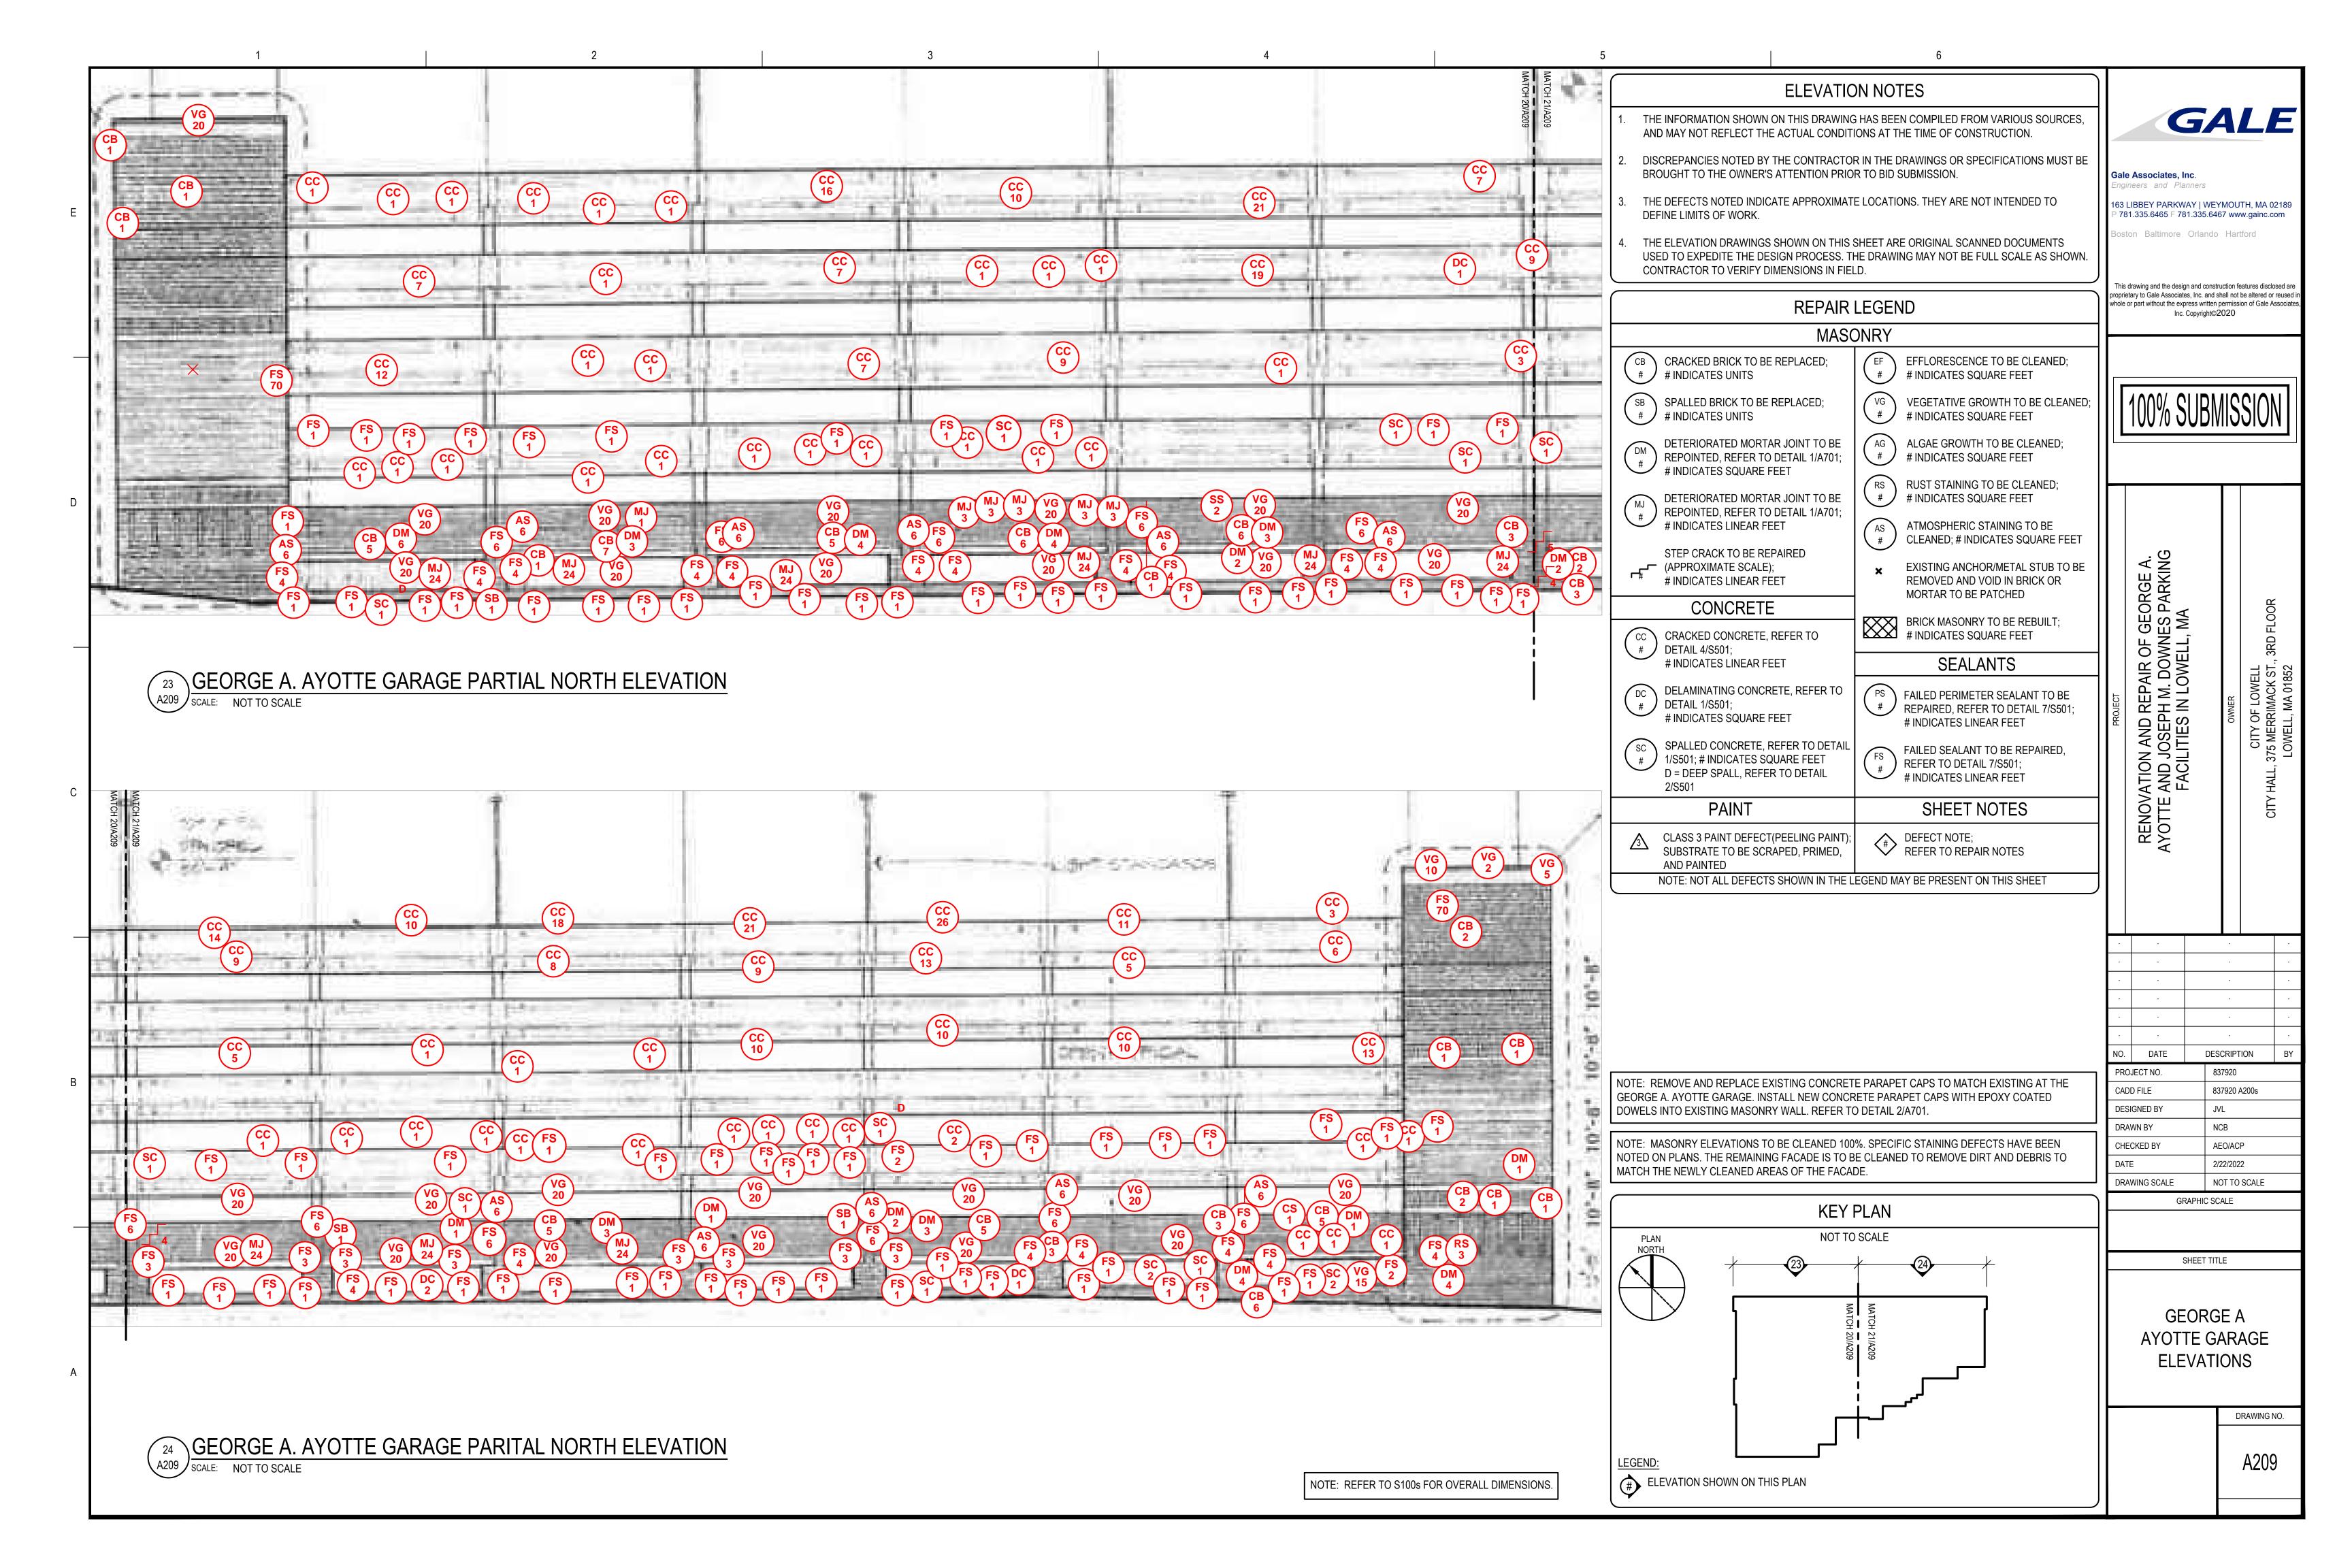
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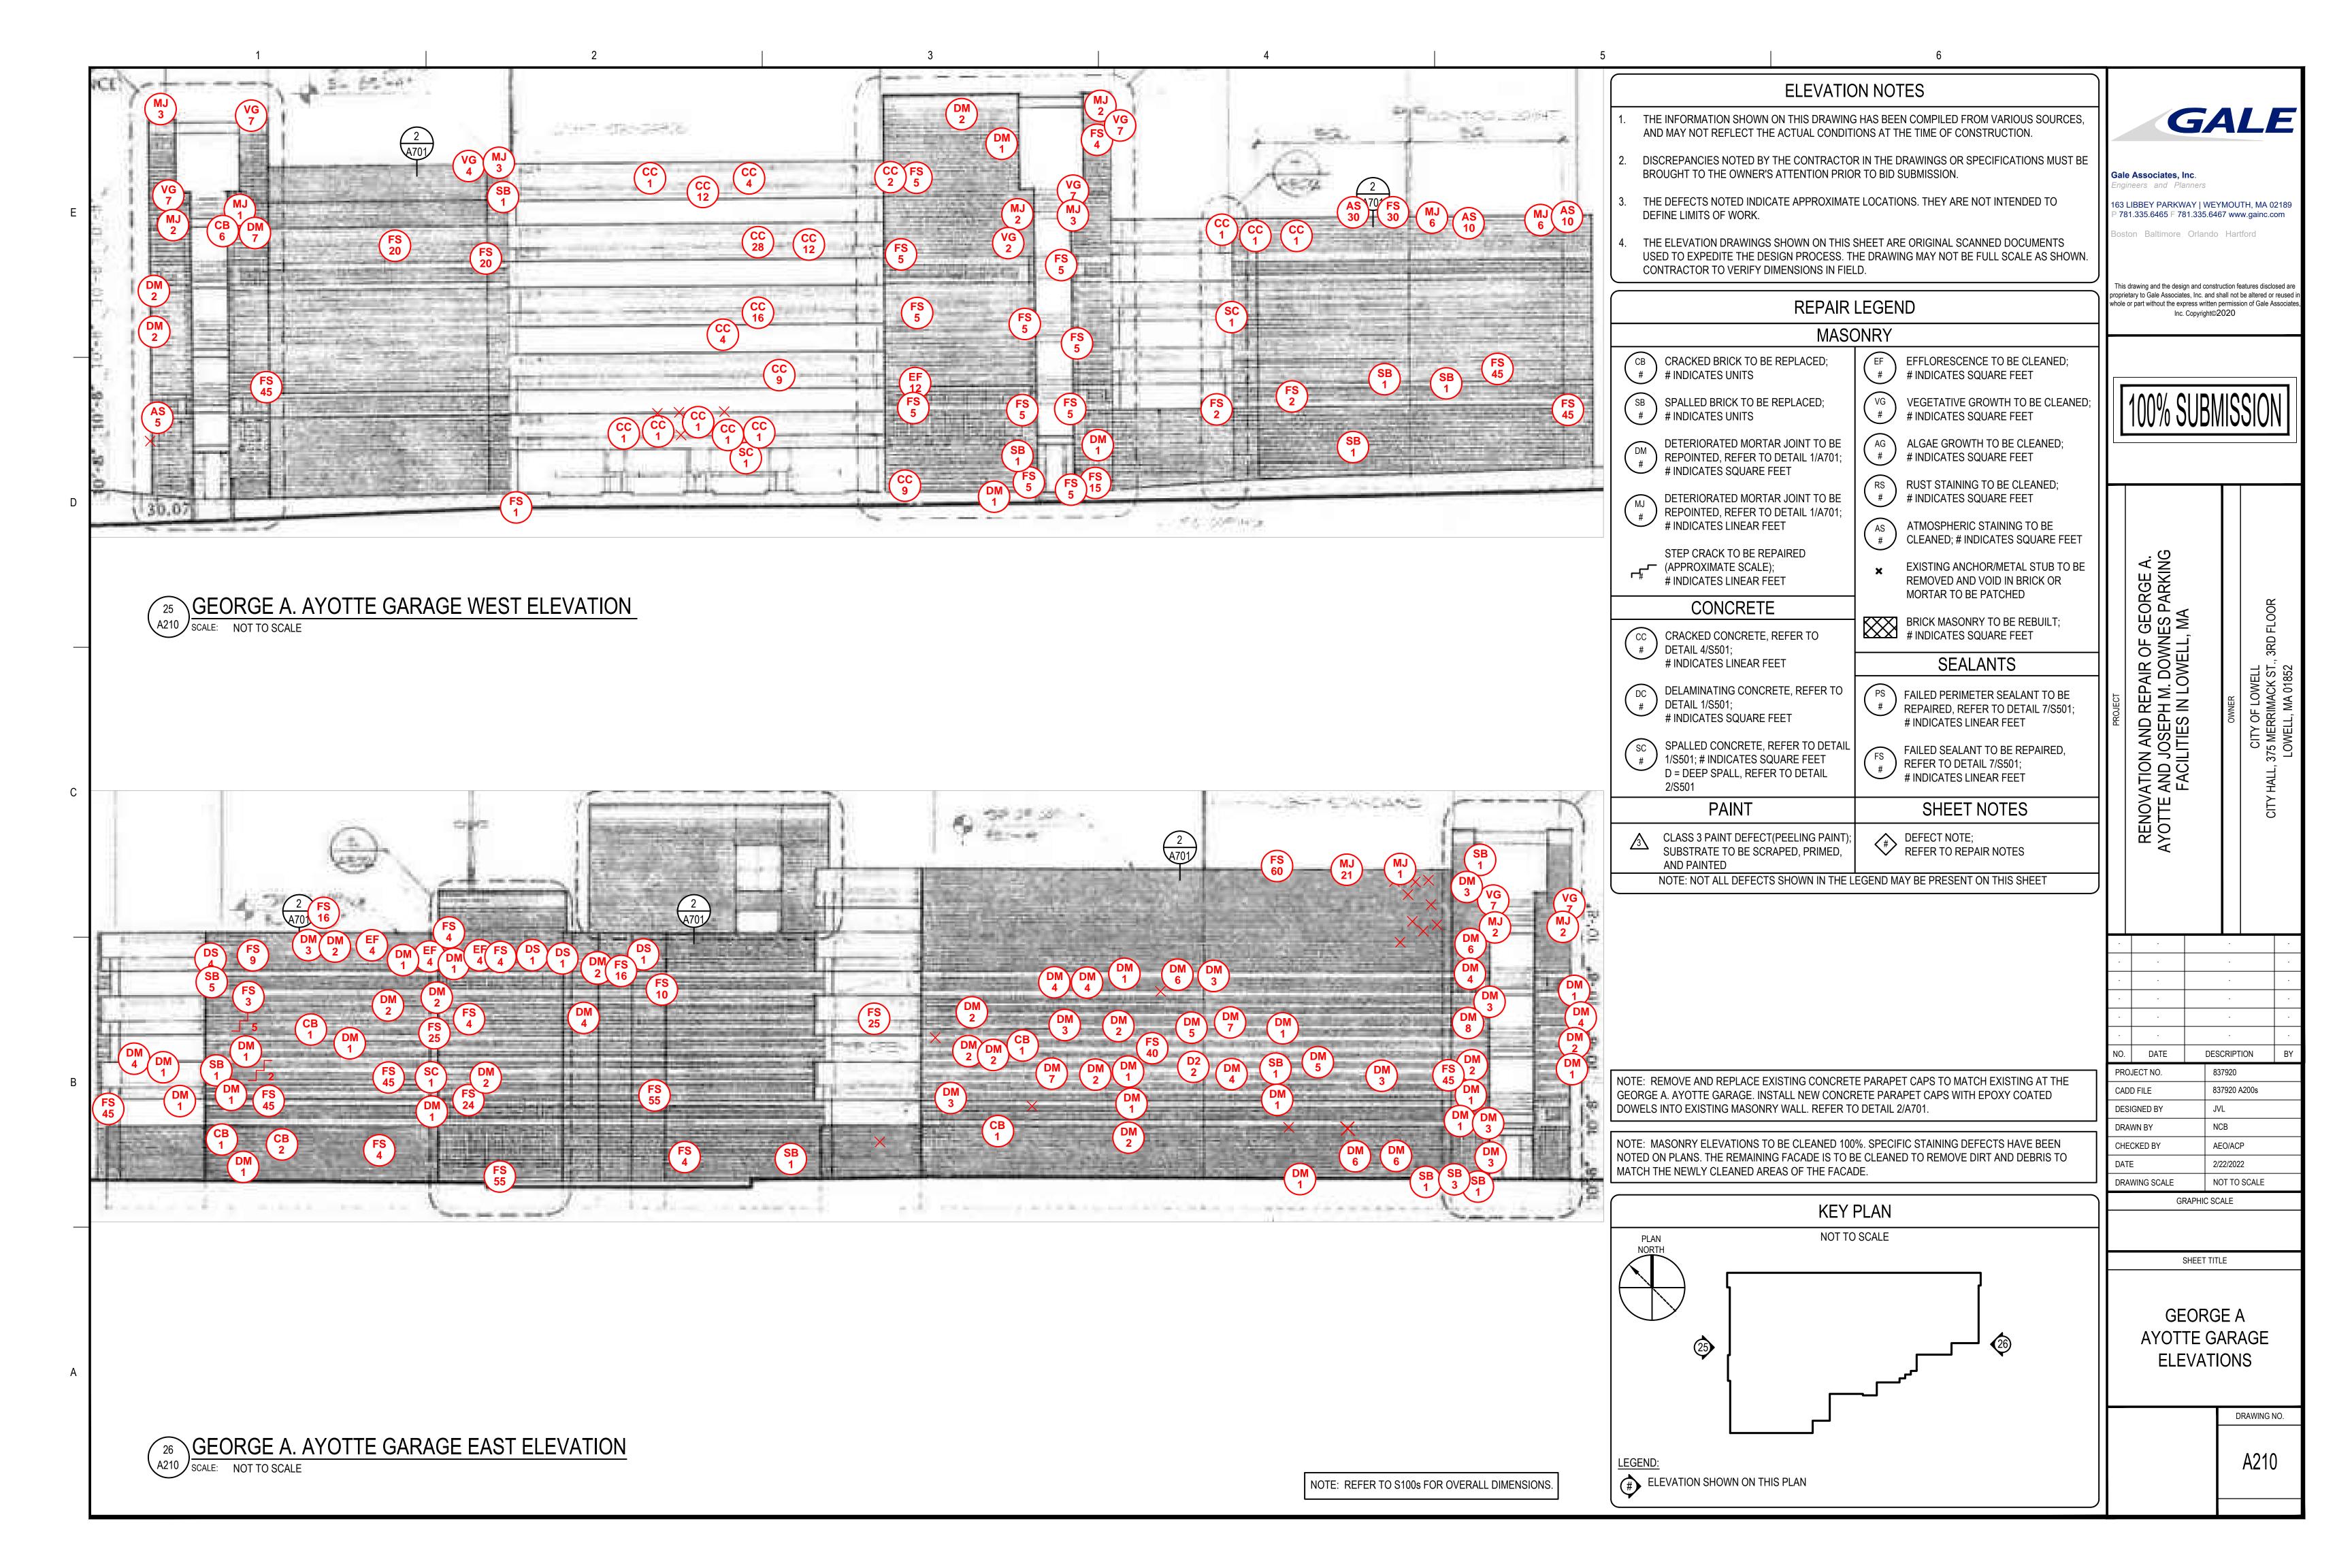
JOSEPH M.
DOWNES GARAGE
ELEVATIONS

A207


DRAWING NO.





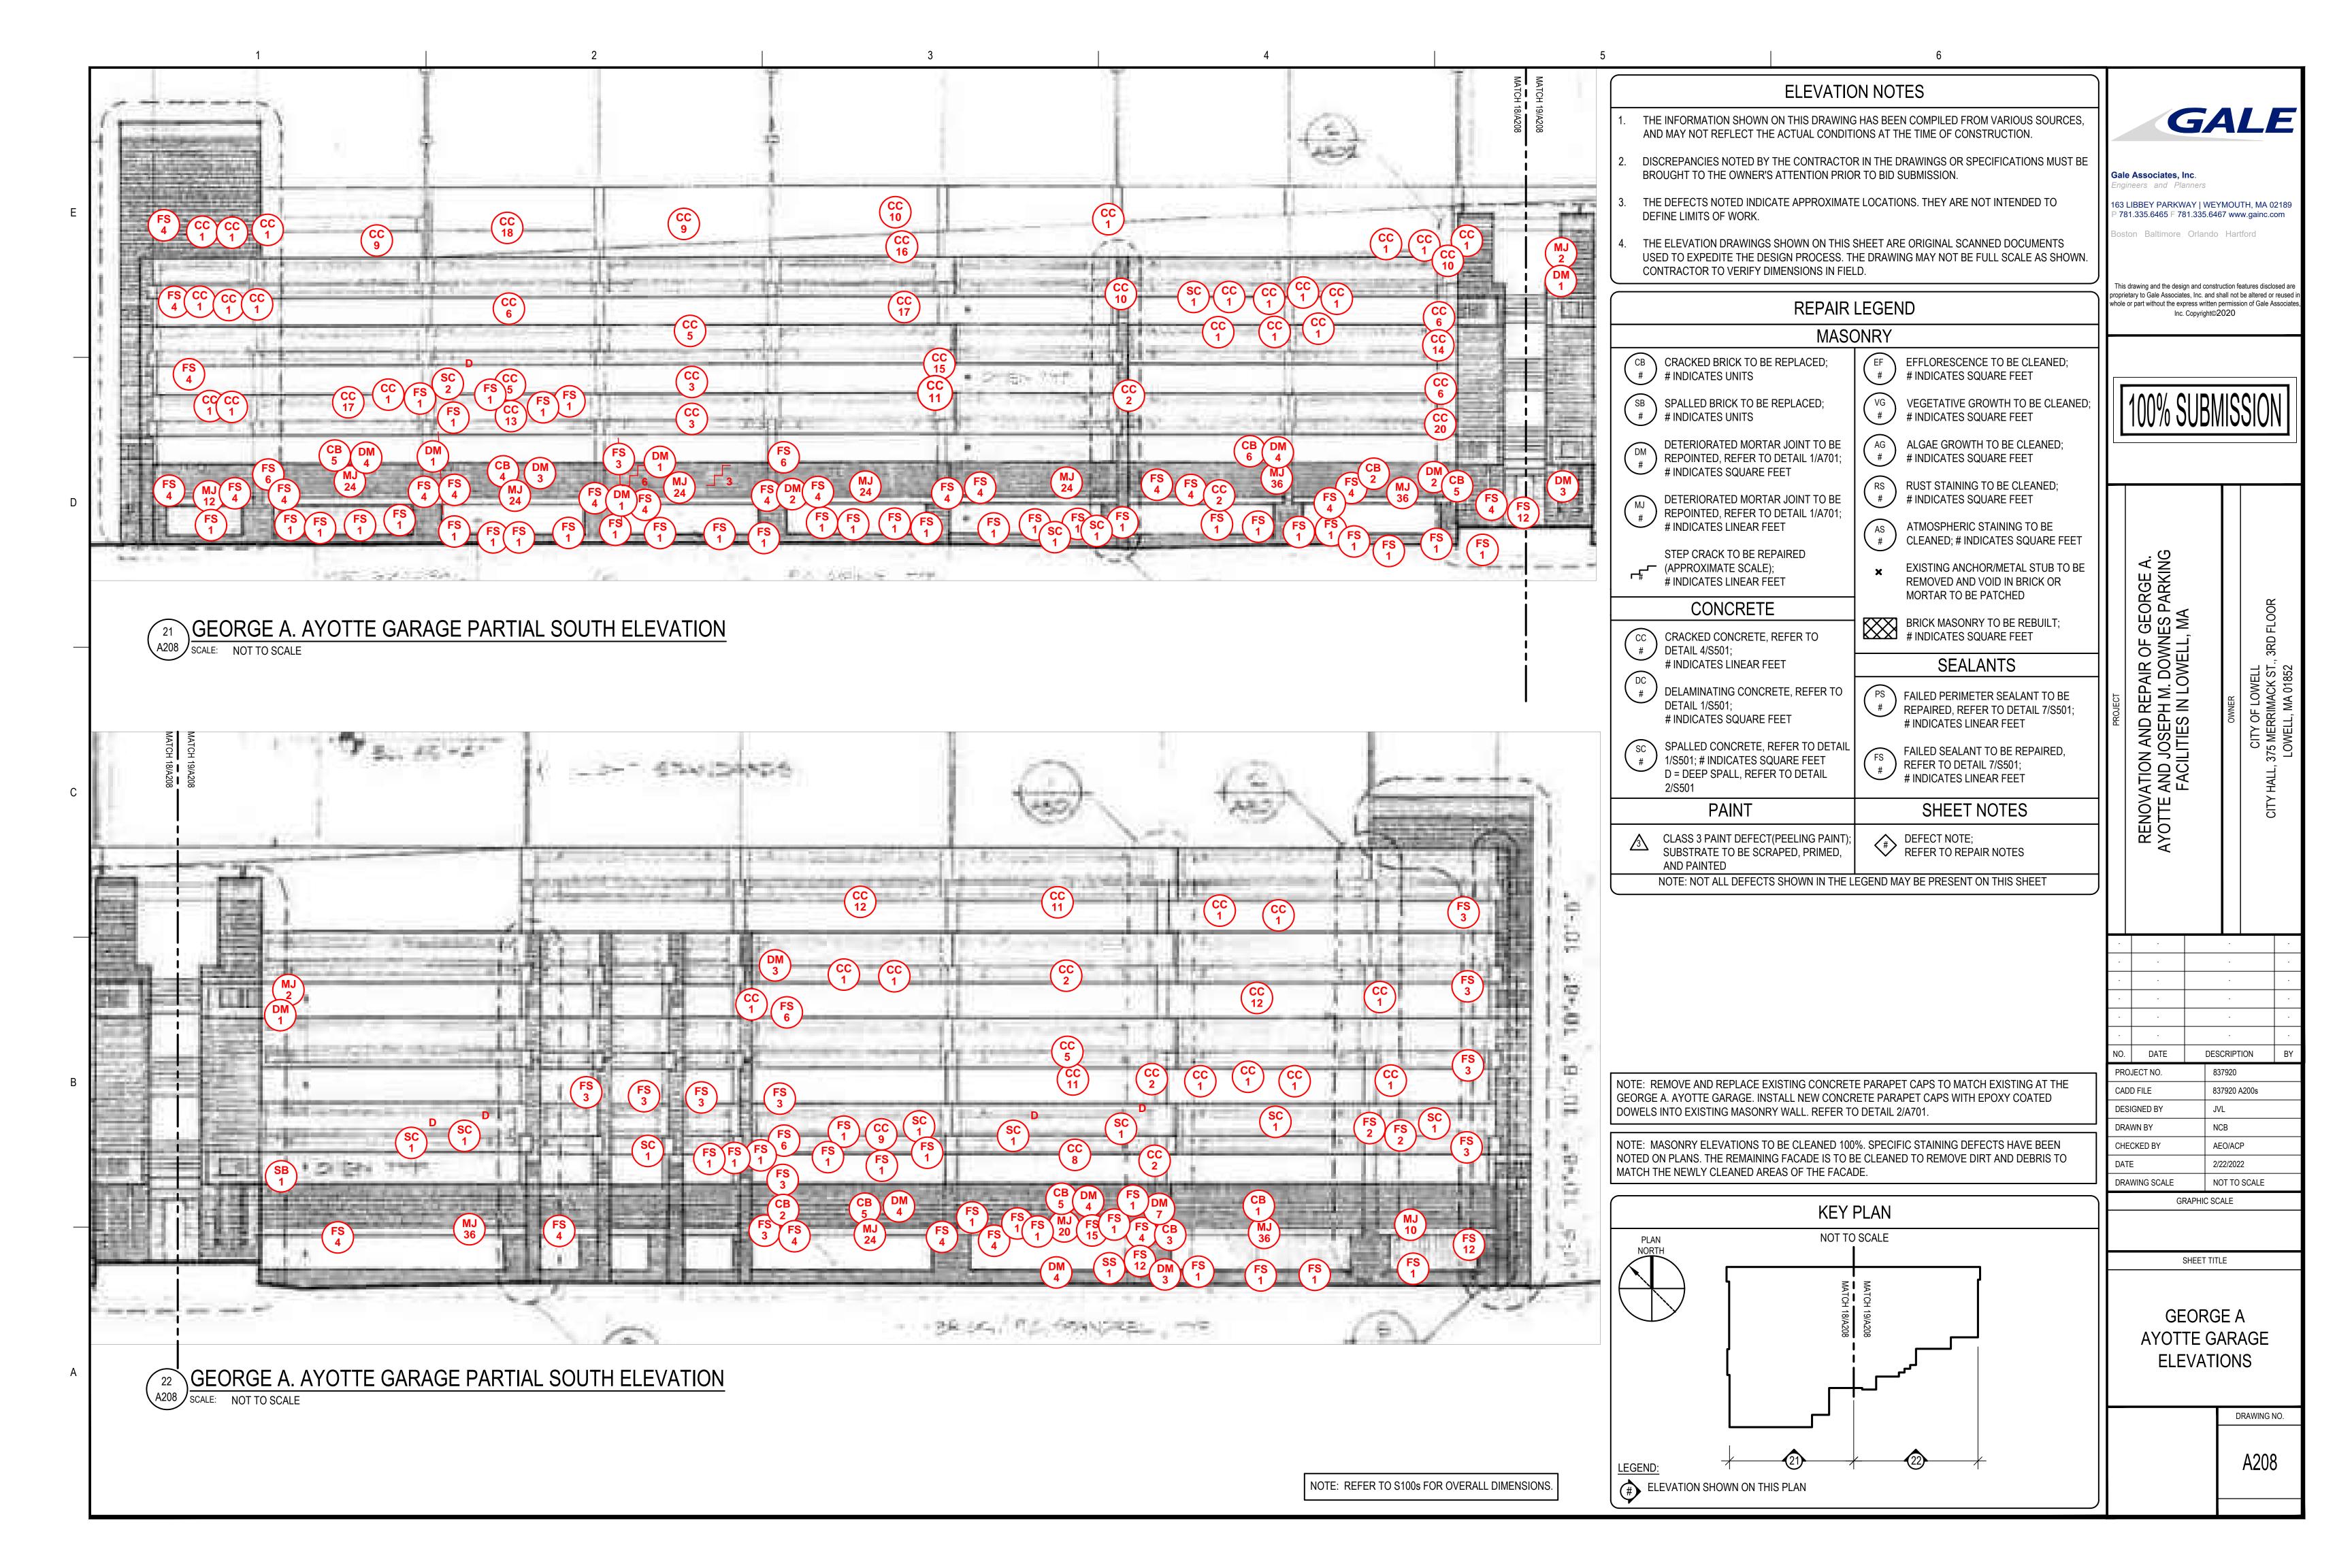

GEORGE A. AYOTTE GARAGE PENTHOUSE NORTH ELEVATION
SCALE: NOT TO SCALE

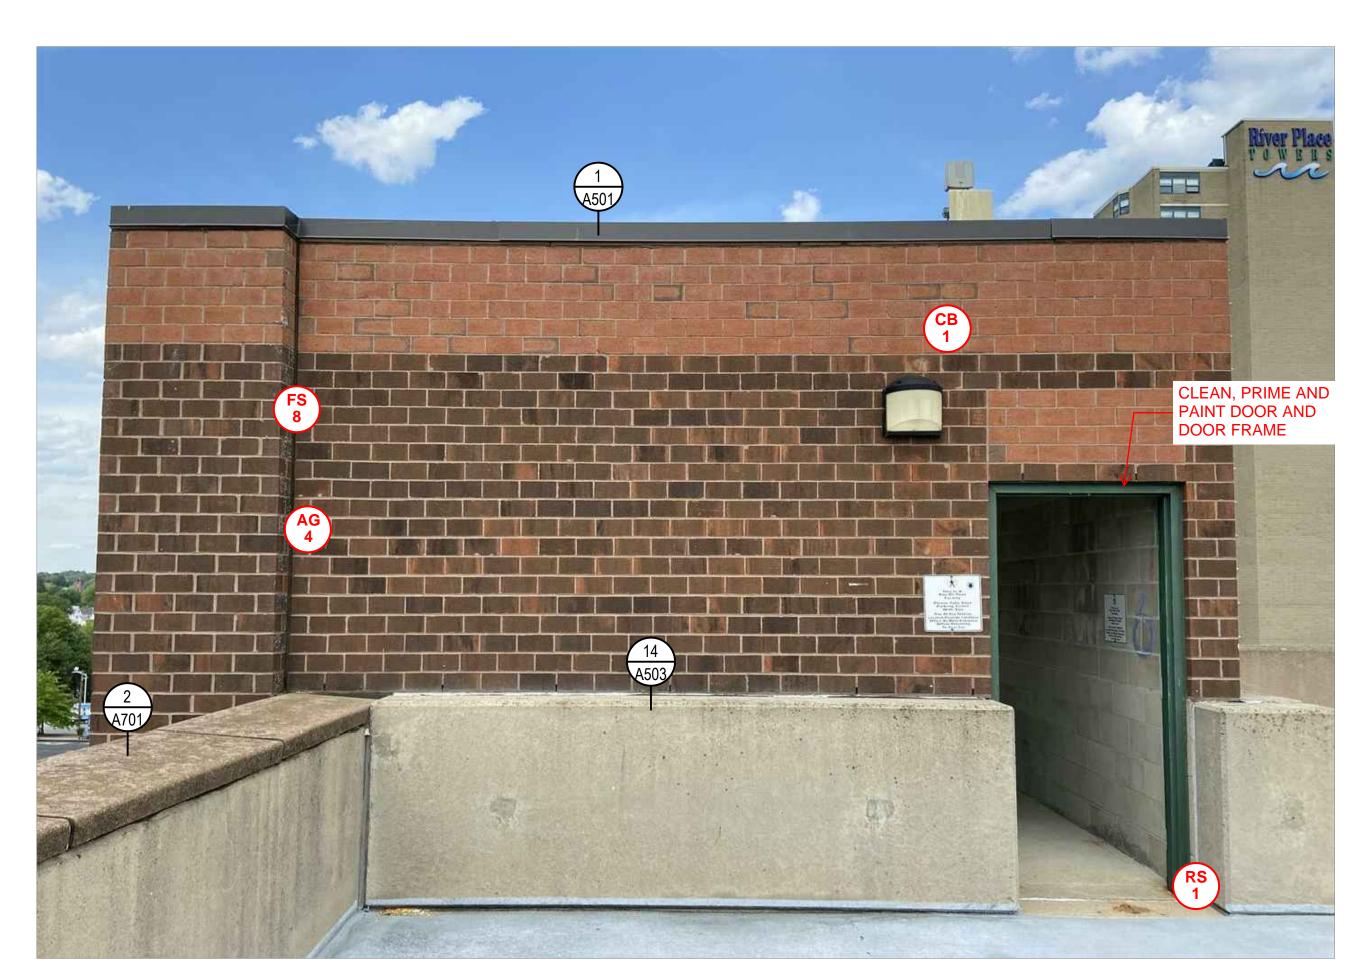

GEORGE A. AYOTTE GARAGE PENTHOUSE SOUTH ELEVATION
SCALE: NOT TO SCALE

**ELEVATION NOTES** 

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3. THE DEFECTS NOTED INDICATE APPROXIMATE LOCATIONS. THEY ARE NOT INTENDED TO DEFINE LIMITS OF WORK.

4. THE ELEVATION DRAWINGS SHOWN ON THIS SHEET ARE ORIGINAL SCANNED DOCUMENTS USED TO EXPEDITE THE DESIGN PROCESS. THE DRAWING MAY NOT BE FULL SCALE AS SHOWN. CONTRACTOR TO VERIFY DIMENSIONS IN FIELD.

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Boston Baltimore Orlando Hartford

OVATION AND REPAIR OF GEORGE A. TE AND JOSEPH M. DOWNES PARKING FACILITIES IN LOWELL, MA


REN AYOT

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REPAIR LEGEND **MASONRY** CB CRACKED BRICK TO BE REPLACED; EFFLORESCENCE TO BE CLEANED; # # INDICATES UNITS # INDICATES SQUARE FEET VG VEGETATIVE GROWTH TO BE CLEANED; SPALLED BRICK TO BE REPLACED; # / # INDICATES UNITS # INDICATES SQUARE FEET AG ALGAE GROWTH TO BE CLEANED; DETERIORATED MORTAR JOINT TO BE REPOINTED, REFER TO DETAIL 1/A701; # INDICATES SQUARE FEET # INDICATES SQUARE FEET RS RUST STAINING TO BE CLEANED; DETERIORATED MORTAR JOINT TO BE # / # INDICATES SQUARE FEET REPOINTED, REFER TO DETAIL 1/A701; # INDICATES LINEAR FEET AS ATMOSPHERIC STAINING TO BE CLEANED; # INDICATES SQUARE FEET STEP CRACK TO BE REPAIRED (APPROXIMATE SCALE); **★** EXISTING ANCHOR/METAL STUB TO BE # INDICATES LINEAR FEET REMOVED AND VOID IN BRICK OR MORTAR TO BE PATCHED CONCRETE BRICK MASONRY TO BE REBUILT;
# INDICATES SQUARE FEET CC CRACKED CONCRETE, REFER TO # DETAIL 4/S501; SEALANTS # INDICATES LINEAR FEET DELAMINATING CONCRETE, REFER TO PS FAILED PERIMETER SEALANT TO BE # DETAIL 1/S501; REPAIRED, REFER TO DETAIL 7/S501; # INDICATES SQUARE FEET # INDICATES LINEAR FEET SPALLED CONCRETE, REFER TO DETAIL FAILED SEALANT TO BE REPAIRED, 1/S501; # INDICATES SQUARE FEET REFER TO DETAIL 7/S501; D = DEEP SPALL, REFER TO DETAIL # INDICATES LINEAR FEET SHEET NOTES DEFECT NOTE;
REFER TO REPAIR NOTES CLASS 3 PAINT DEFECT(PEELING PAINT); SUBSTRATE TO BE SCRAPED, PRIMED, AND PAINTED NOTE: NOT ALL DEFECTS SHOWN IN THE LEGEND MAY BE PRESENT ON THIS SHEET

NOTE: MASONRY ELEVATIONS TO BE CLEANED 100%. SPECIFIC STAINING DEFECTS HAVE BEEN NOTED ON PLANS. THE REMAINING FACADE IS TO BE CLEANED TO REMOVE DIRT AND DEBRIS TO MATCH THE NEWLY CLEANED AREAS OF THE FACADE.

DOWELS INTO EXISTING MASONRY WALL. REFER TO DETAIL 2/A701.

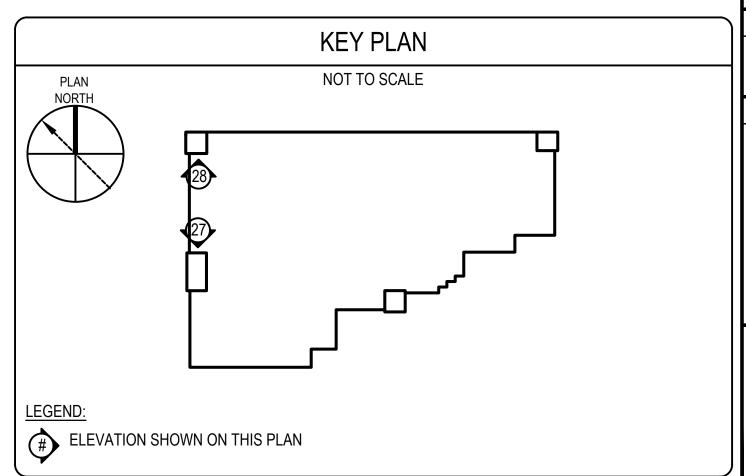

PROJECT NO. 837920

CADD FILE 837920 A200s

DESIGNED BY JVL

DRAWN BY NCB

CHECKED BY AEO/ACP

DATE 2/22/2022

DRAWING SCALE NOT TO SCALE


GRAPHIC SCALE

SHEET TITLE

GEORGE A AYOTTE GARAGE PENTHOUSE ELEVATIONS

A211

GEORGE A. AYOTTE GARAGE PENTHOUSE EAST ELEVATION A212 SCALE: NOT TO SCALE

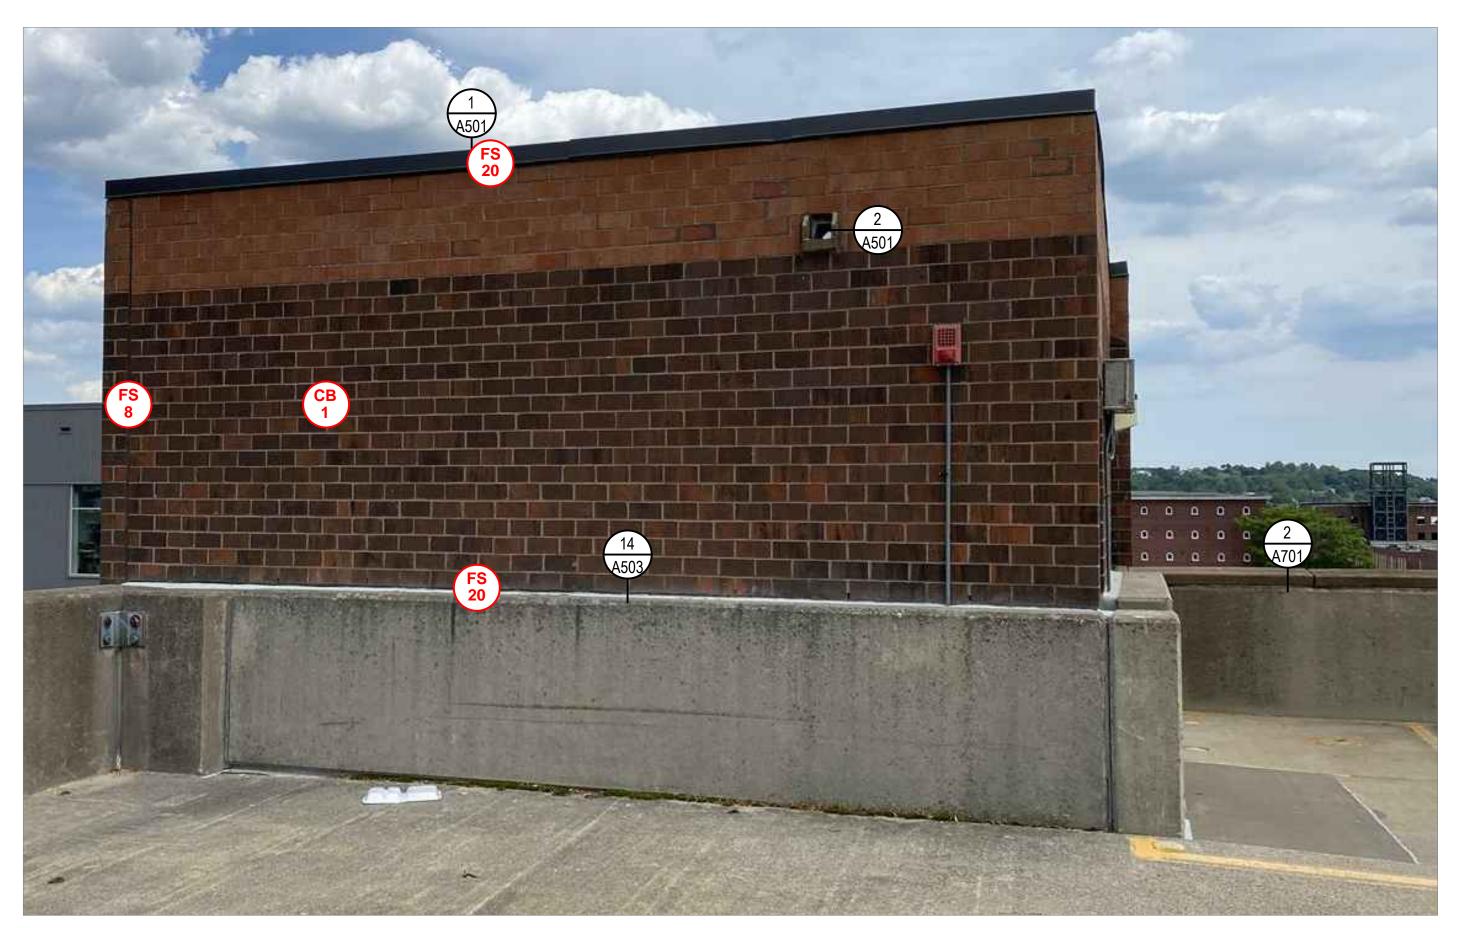

30 GEORGE A. AYOTTE GARAGE PENTHOUSE WEST ELEVATION A212 SCALE: NOT TO SCALE

**ELEVATION NOTES** 

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- THE ELEVATION DRAWINGS SHOWN ON THIS SHEET ARE ORIGINAL SCANNED DOCUMENTS USED TO EXPEDITE THE DESIGN PROCESS. THE DRAWING MAY NOT BE FULL SCALE AS SHOWN. CONTRACTOR TO VERIFY DIMENSIONS IN FIELD.

REPAIR LEGEND **MASONRY** 

↓ # J # INDICATES UNITS SB SPALLED BRICK TO BE REPLACED;

CB CRACKED BRICK TO BE REPLACED;

- # # INDICATES UNITS DETERIORATED MORTAR JOINT TO BE REPOINTED, REFER TO DETAIL 1/A701;
- DETERIORATED MORTAR JOINT TO BE REPOINTED, REFER TO DETAIL 1/A701; # INDICATES LINEAR FEET

# INDICATES SQUARE FEET

STEP CRACK TO BE REPAIRED (APPROXIMATE SCALE); # INDICATES LINEAR FEET

CONCRETE

- CC CRACKED CONCRETE, REFER TO ( # ) DETAIL 4/S501; # INDICATES LINEAR FEET
- DELAMINATING CONCRETE, REFER TO DETAIL 1/S501; # INDICATES SQUARE FEET
- SC SPALLED CONCRETE, REFER TO DETAIL 1/S501; # INDICATES SQUARE FEET D = DEEP SPALL, REFER TO DETAIL

PAINT

CLASS 3 PAINT DEFECT(PEELING PAINT) SUBSTRATE TO BE SCRAPED, PRIMED, AND PAINTED

DEFECT NOTE;
REFER TO REPAIR NOTES

EFFLORESCENCE TO BE CLEANED;

VG VEGETATIVE GROWTH TO BE CLEANED;

# INDICATES SQUARE FEET

# INDICATES SQUARE FEET

AG ALGAE GROWTH TO BE CLEANED;

# INDICATES SQUARE FEET

ATMOSPHERIC STAINING TO BE

CLEANED; # INDICATES SQUARE FEET

EXISTING ANCHOR/METAL STUB TO BE

REMOVED AND VOID IN BRICK OR

MORTAR TO BE PATCHED

BRICK MASONRY TO BE REBUILT;
# INDICATES SQUARE FEET

# INDICATES LINEAR FEET

REFER TO DETAIL 7/S501;

# INDICATES LINEAR FEET

SEALANTS

FAILED PERIMETER SEALANT TO BE

REPAIRED, REFER TO DETAIL 7/S501;

FAILED SEALANT TO BE REPAIRED,


SHEET NOTES

RS RUST STAINING TO BE CLEANED; # INDICATES SQUARE FEET

NOTE: NOT ALL DEFECTS SHOWN IN THE LEGEND MAY BE PRESENT ON THIS SHEET

NOTE: REMOVE AND REPLACE EXISTING CONCRETE PARAPET CAPS TO MATCH EXISTING AT THE GEORGE A. AYOTTE GARAGE. INSTALL NEW CONCRETE PARAPET CAPS WITH EPOXY COATED DOWELS INTO EXISTING MASONRY WALL. REFER TO DETAIL 2/A701.

NOTE: MASONRY ELEVATIONS TO BE CLEANED 100%. SPECIFIC STAINING DEFECTS HAVE BEEN NOTED ON PLANS. THE REMAINING FACADE IS TO BE CLEANED TO REMOVE DIRT AND DEBRIS TO MATCH THE NEWLY CLEANED AREAS OF THE FACADE.

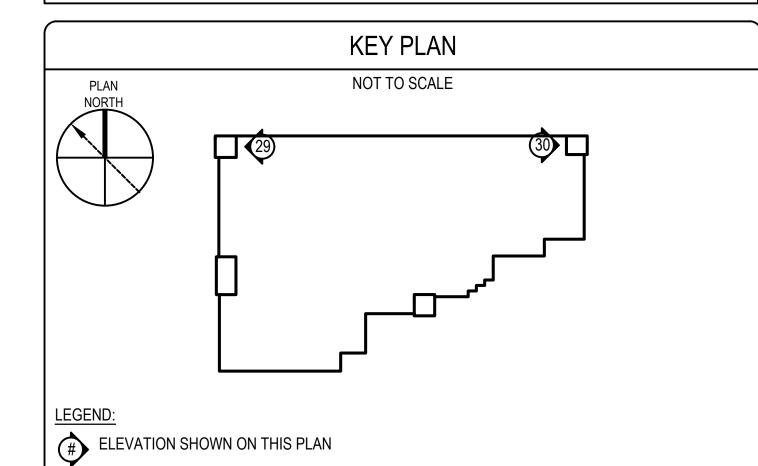

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IOVATION AND REPAIR OF GEORGE A. TE AND JOSEPH M. DOWNES PARKING FACILITIES IN LOWELL, MA

REN AYOT

DESCRIPTION PROJECT NO.

CADD FILE 837920 A200s DESIGNED BY DRAWN BY CHECKED BY AEO/ACP DATE 2/22/2022 DRAWING SCALE NOT TO SCALE

GRAPHIC SCALE


SHEET TITLE

GEORGE A AYOTTE GARAGE PENTHOUSE **ELEVATIONS** 

DRAWING NO.

CLEAN, PRIME AND PAINT DOOR AND DOOR FRAME

GEORGE A. AYOTTE GARAGE PENTHOUSE SOUTH ELEVATION A213 SCALE: NOT TO SCALE

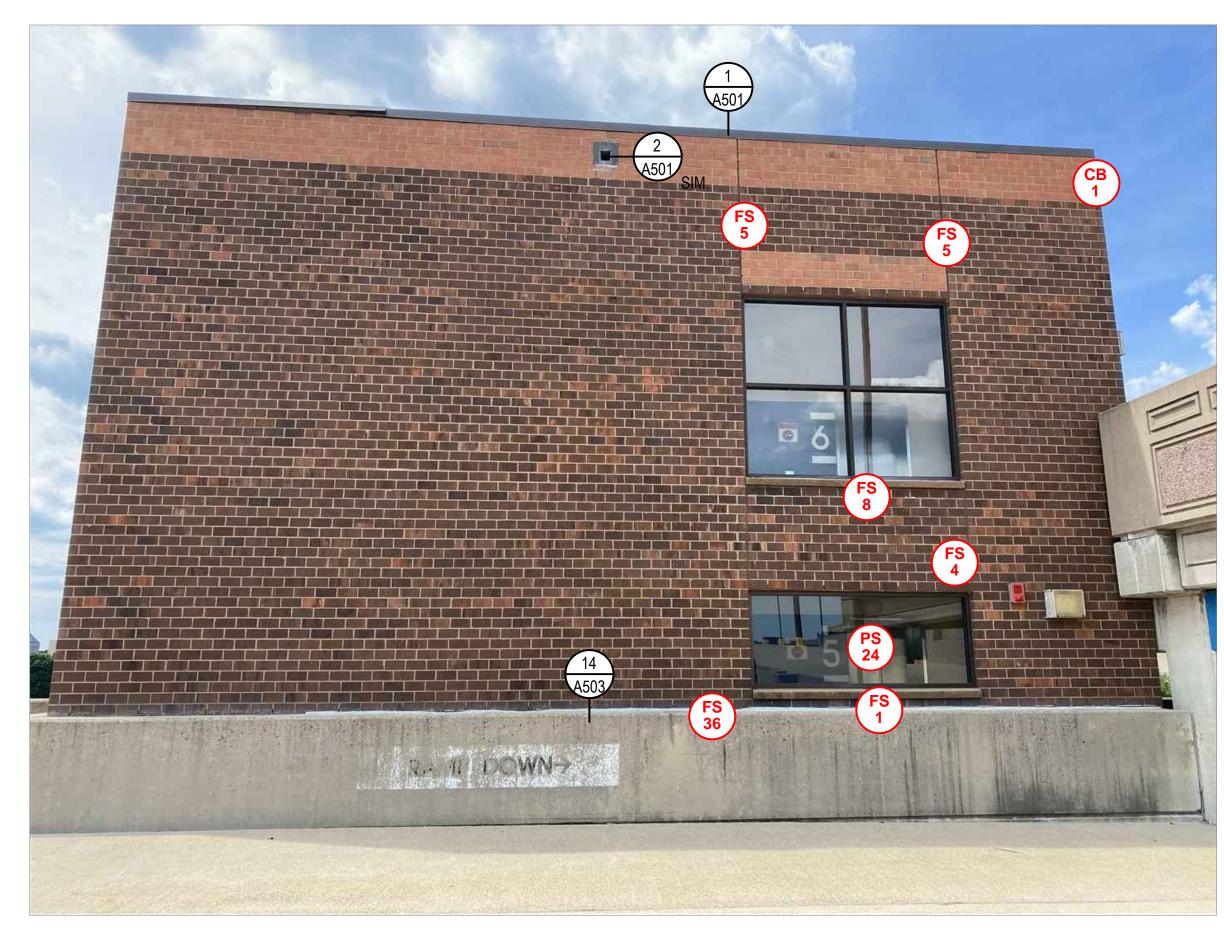

32 GEORGE A. AYOTTE GARAGE PENTHOUSE EAST ELEVATION A213 SCALE: NOT TO SCALE

**ELEVATION NOTES** 

- THE INFORMATION SHOWN ON THIS DRAWING HAS BEEN COMPILED FROM VARIOUS SOURCES, AND MAY NOT REFLECT THE ACTUAL CONDITIONS AT THE TIME OF CONSTRUCTION.
- DISCREPANCIES NOTED BY THE CONTRACTOR IN THE DRAWINGS OR SPECIFICATIONS MUST BE BROUGHT TO THE OWNER'S ATTENTION PRIOR TO BID SUBMISSION.
- THE DEFECTS NOTED INDICATE APPROXIMATE LOCATIONS. THEY ARE NOT INTENDED TO DEFINE LIMITS OF WORK.
- THE ELEVATION DRAWINGS SHOWN ON THIS SHEET ARE ORIGINAL SCANNED DOCUMENTS USED TO EXPEDITE THE DESIGN PROCESS. THE DRAWING MAY NOT BE FULL SCALE AS SHOWN. CONTRACTOR TO VERIFY DIMENSIONS IN FIELD.

REPAIR LEGEND

**MASONRY** 

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IOVATION AND REPAIR OF GEORGE A. TE AND JOSEPH M. DOWNES PARKING FACILITIES IN LOWELL, MA

REN AYOT

BRICK MASONRY TO BE REBUILT;
# INDICATES SQUARE FEET

SEALANTS

MORTAR TO BE PATCHED

\ EFFLORESCENCE TO BE CLEANED;

VEGETATIVE GROWTH TO BE CLEANED

# INDICATES SQUARE FEET

# INDICATES SQUARE FEET

AG ALGAE GROWTH TO BE CLEANED;

# INDICATES SQUARE FEET

# INDICATES SQUARE FEET

RUST STAINING TO BE CLEANED;

ATMOSPHERIC STAINING TO BE CLEANED; # INDICATES SQUARE FEET

EXISTING ANCHOR/METAL STUB TO BE

REMOVED AND VOID IN BRICK OR

# INDICATES LINEAR FEET DC DELAMINATING CONCRETE, REFER TO

PS FAILED PERIMETER SEALANT TO BE REPAIRED, REFER TO DETAIL 7/S501; # INDICATES LINEAR FEET

SPALLED CONCRETE, REFER TO DETAIL 1/S501; # INDICATES SQUARE FEET D = DEEP SPALL, REFER TO DETAIL 2/S501

# INDICATES SQUARE FEET

CB CRACKED BRICK TO BE REPLACED;

SB SPALLED BRICK TO BE REPLACED;

# INDICATES SQUARE FEET

# INDICATES LINEAR FEET

# INDICATES LINEAR FEET

CC CRACKED CONCRETE, REFER TO

CONCRETE

(APPROXIMATE SCALE);

DETAIL 1/S501;

STEP CRACK TO BE REPAIRED

DETERIORATED MORTAR JOINT TO BE

REPOINTED, REFER TO DETAIL 1/A701;

DETERIORATED MORTAR JOINT TO BE

REPOINTED, REFER TO DETAIL 1/A701;

↓ # J # INDICATES UNITS

↓ # J # INDICATES UNITS

FAILED SEALANT TO BE REPAIRED, REFER TO DETAIL 7/S501; # INDICATES LINEAR FEET

PAINT CLASS 3 PAINT DEFECT(PEELING PAINT) SUBSTRATE TO BE SCRAPED, PRIMED, AND PAINTED

SHEET NOTES

DEFECT NOTE;
REFER TO REPAIR NOTES

NOTE: NOT ALL DEFECTS SHOWN IN THE LEGEND MAY BE PRESENT ON THIS SHEET

DESCRIPTION PROJECT NO. 837920

NOTE: REMOVE AND REPLACE EXISTING CONCRETE PARAPET CAPS TO MATCH EXISTING AT THE GEORGE A. AYOTTE GARAGE. INSTALL NEW CONCRETE PARAPET CAPS WITH EPOXY COATED DOWELS INTO EXISTING MASONRY WALL. REFER TO DETAIL 2/A701.

NOTE: MASONRY ELEVATIONS TO BE CLEANED 100%. SPECIFIC STAINING DEFECTS HAVE BEEN NOTED ON PLANS. THE REMAINING FACADE IS TO BE CLEANED TO REMOVE DIRT AND DEBRIS TO MATCH THE NEWLY CLEANED AREAS OF THE FACADE.

**KEY PLAN** NOT TO SCALE # ELEVATION SHOWN ON THIS PLAN

CADD FILE 837920 A200s DESIGNED BY DRAWN BY NCB CHECKED BY AEO/ACP DATE 2/22/2022 DRAWING SCALE NOT TO SCALE GRAPHIC SCALE

SHEET TITLE


GEORGE A AYOTTE GARAGE PENTHOUSE **ELEVATIONS** 

DRAWING NO.

GEORGE A. AYOTTE GARAGE PENTHOUSE SOUTH ELEVATION A214 SCALE: NOT TO SCALE



GEORGE A. AYOTTE GARAGE PENTHOUSE WEST ELEVATION A214 SCALE: NOT TO SCALE

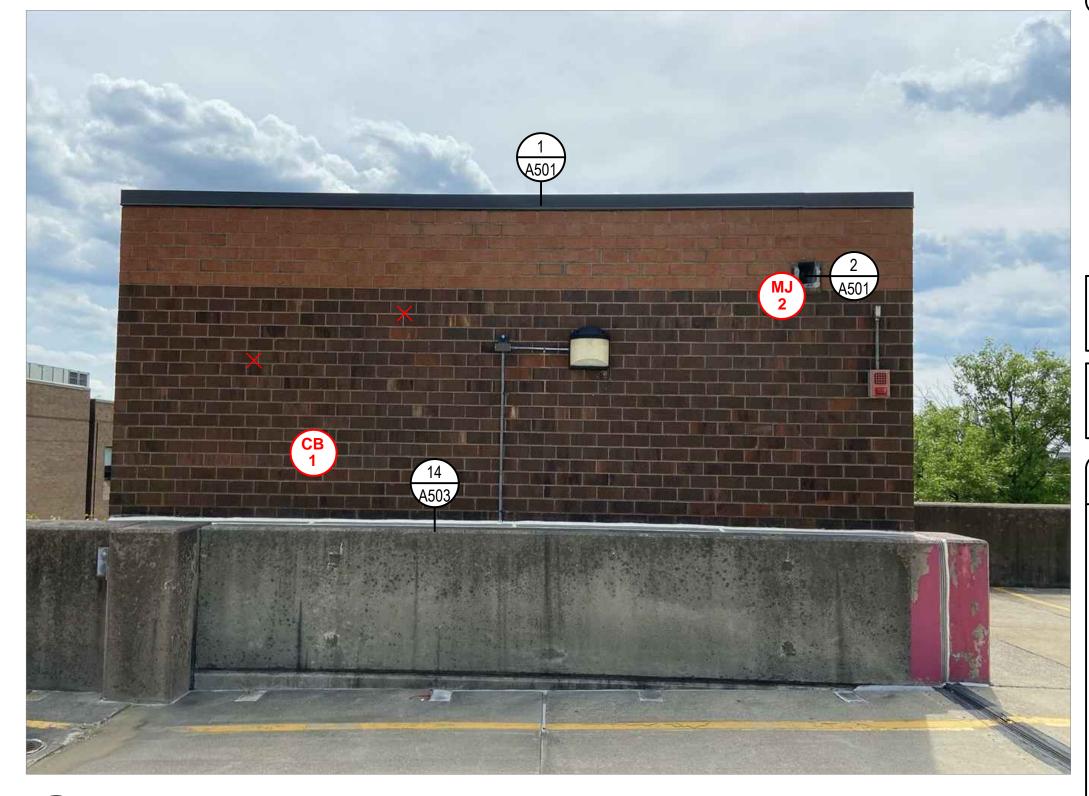

GEORGE A. AYOTTE GARAGE PENTHOUSE NORTH ELEVATION A214 SCALE: NOT TO SCALE

#### **ELEVATION NOTES**

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- THE DEFECTS NOTED INDICATE APPROXIMATE LOCATIONS. THEY ARE NOT INTENDED TO DEFINE LIMITS OF WORK.
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#### REPAIR LEGEND

## **MASONRY**

EFFLORESCENCE TO BE CLEANED;

# INDICATES SQUARE FEET

# INDICATES SQUARE FEET

AG ALGAE GROWTH TO BE CLEANED;

# INDICATES SQUARE FEET

# INDICATES SQUARE FEET

MORTAR TO BE PATCHED

BRICK MASONRY TO BE REBUILT;
# INDICATES SQUARE FEET

**SEALANTS** 

REPAIRED, REFER TO DETAIL 7/S501;

FAILED SEALANT TO BE REPAIRED,

SHEET NOTES

PS FAILED PERIMETER SEALANT TO BE

# INDICATES LINEAR FEET

REFER TO DETAIL 7/S501;

# INDICATES LINEAR FEET

ATMOSPHERIC STAINING TO BE

CLEANED; # INDICATES SQUARE FEET

EXISTING ANCHOR/METAL STUB TO BE

REMOVED AND VOID IN BRICK OR

RUST STAINING TO BE CLEANED;

VG VEGETATIVE GROWTH TO BE CLEANED:

- CB CRACKED BRICK TO BE REPLACED; # / # INDICATES UNITS
- SB SPALLED BRICK TO BE REPLACED:
- DETERIORATED MORTAR JOINT TO BE REPOINTED, REFER TO DETAIL 1/A701; # INDICATES SQUARE FEET
- DETERIORATED MORTAR JOINT TO BE REPOINTED, REFER TO DETAIL 1/A701; # INDICATES LINEAR FEET
- STEP CRACK TO BE REPAIRED (APPROXIMATE SCALE); # INDICATES LINEAR FEET

#### CONCRETE

- CC CRACKED CONCRETE, REFER TO # DETAIL 4/S501; # INDICATES LINEAR FEET
- DELAMINATING CONCRETE, REFER TO # DETAIL 1/S501; # INDICATES SQUARE FEET
- SC SPALLED CONCRETE, REFER TO DETAIL 1/S501; # INDICATES SQUARE FEET D = DEEP SPALL, REFER TO DETAIL
  - **PAINT**
- CLASS 3 PAINT DEFECT(PEELING PAINT). SUBSTRATE TO BE SCRAPED, PRIMED,
  - DEFECT NOTE;
    REFER TO REPAIR NOTES

AND PAINTED NOTE: NOT ALL DEFECTS SHOWN IN THE LEGEND MAY BE PRESENT ON THIS SHEET

NOTE: REMOVE AND REPLACE EXISTING CONCRETE PARAPET CAPS TO MATCH EXISTING AT THE

NOTE: MASONRY ELEVATIONS TO BE CLEANED 100%. SPECIFIC STAINING DEFECTS HAVE BEEN

NOTED ON PLANS. THE REMAINING FACADE IS TO BE CLEANED TO REMOVE DIRT AND DEBRIS TO

**KEY PLAN** 

NOT TO SCALE

GEORGE A. AYOTTE GARAGE. INSTALL NEW CONCRETE PARAPET CAPS WITH EPOXY COATED

DOWELS INTO EXISTING MASONRY WALL. REFER TO DETAIL 2/A701

MATCH THE NEWLY CLEANED AREAS OF THE FACADE.

# ELEVATION SHOWN ON THIS PLAN

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IOVATION AND REPAIR OF GEORGE A. TE AND JOSEPH M. DOWNES PARKING FACILITIES IN LOWELL, MA REN AYOT

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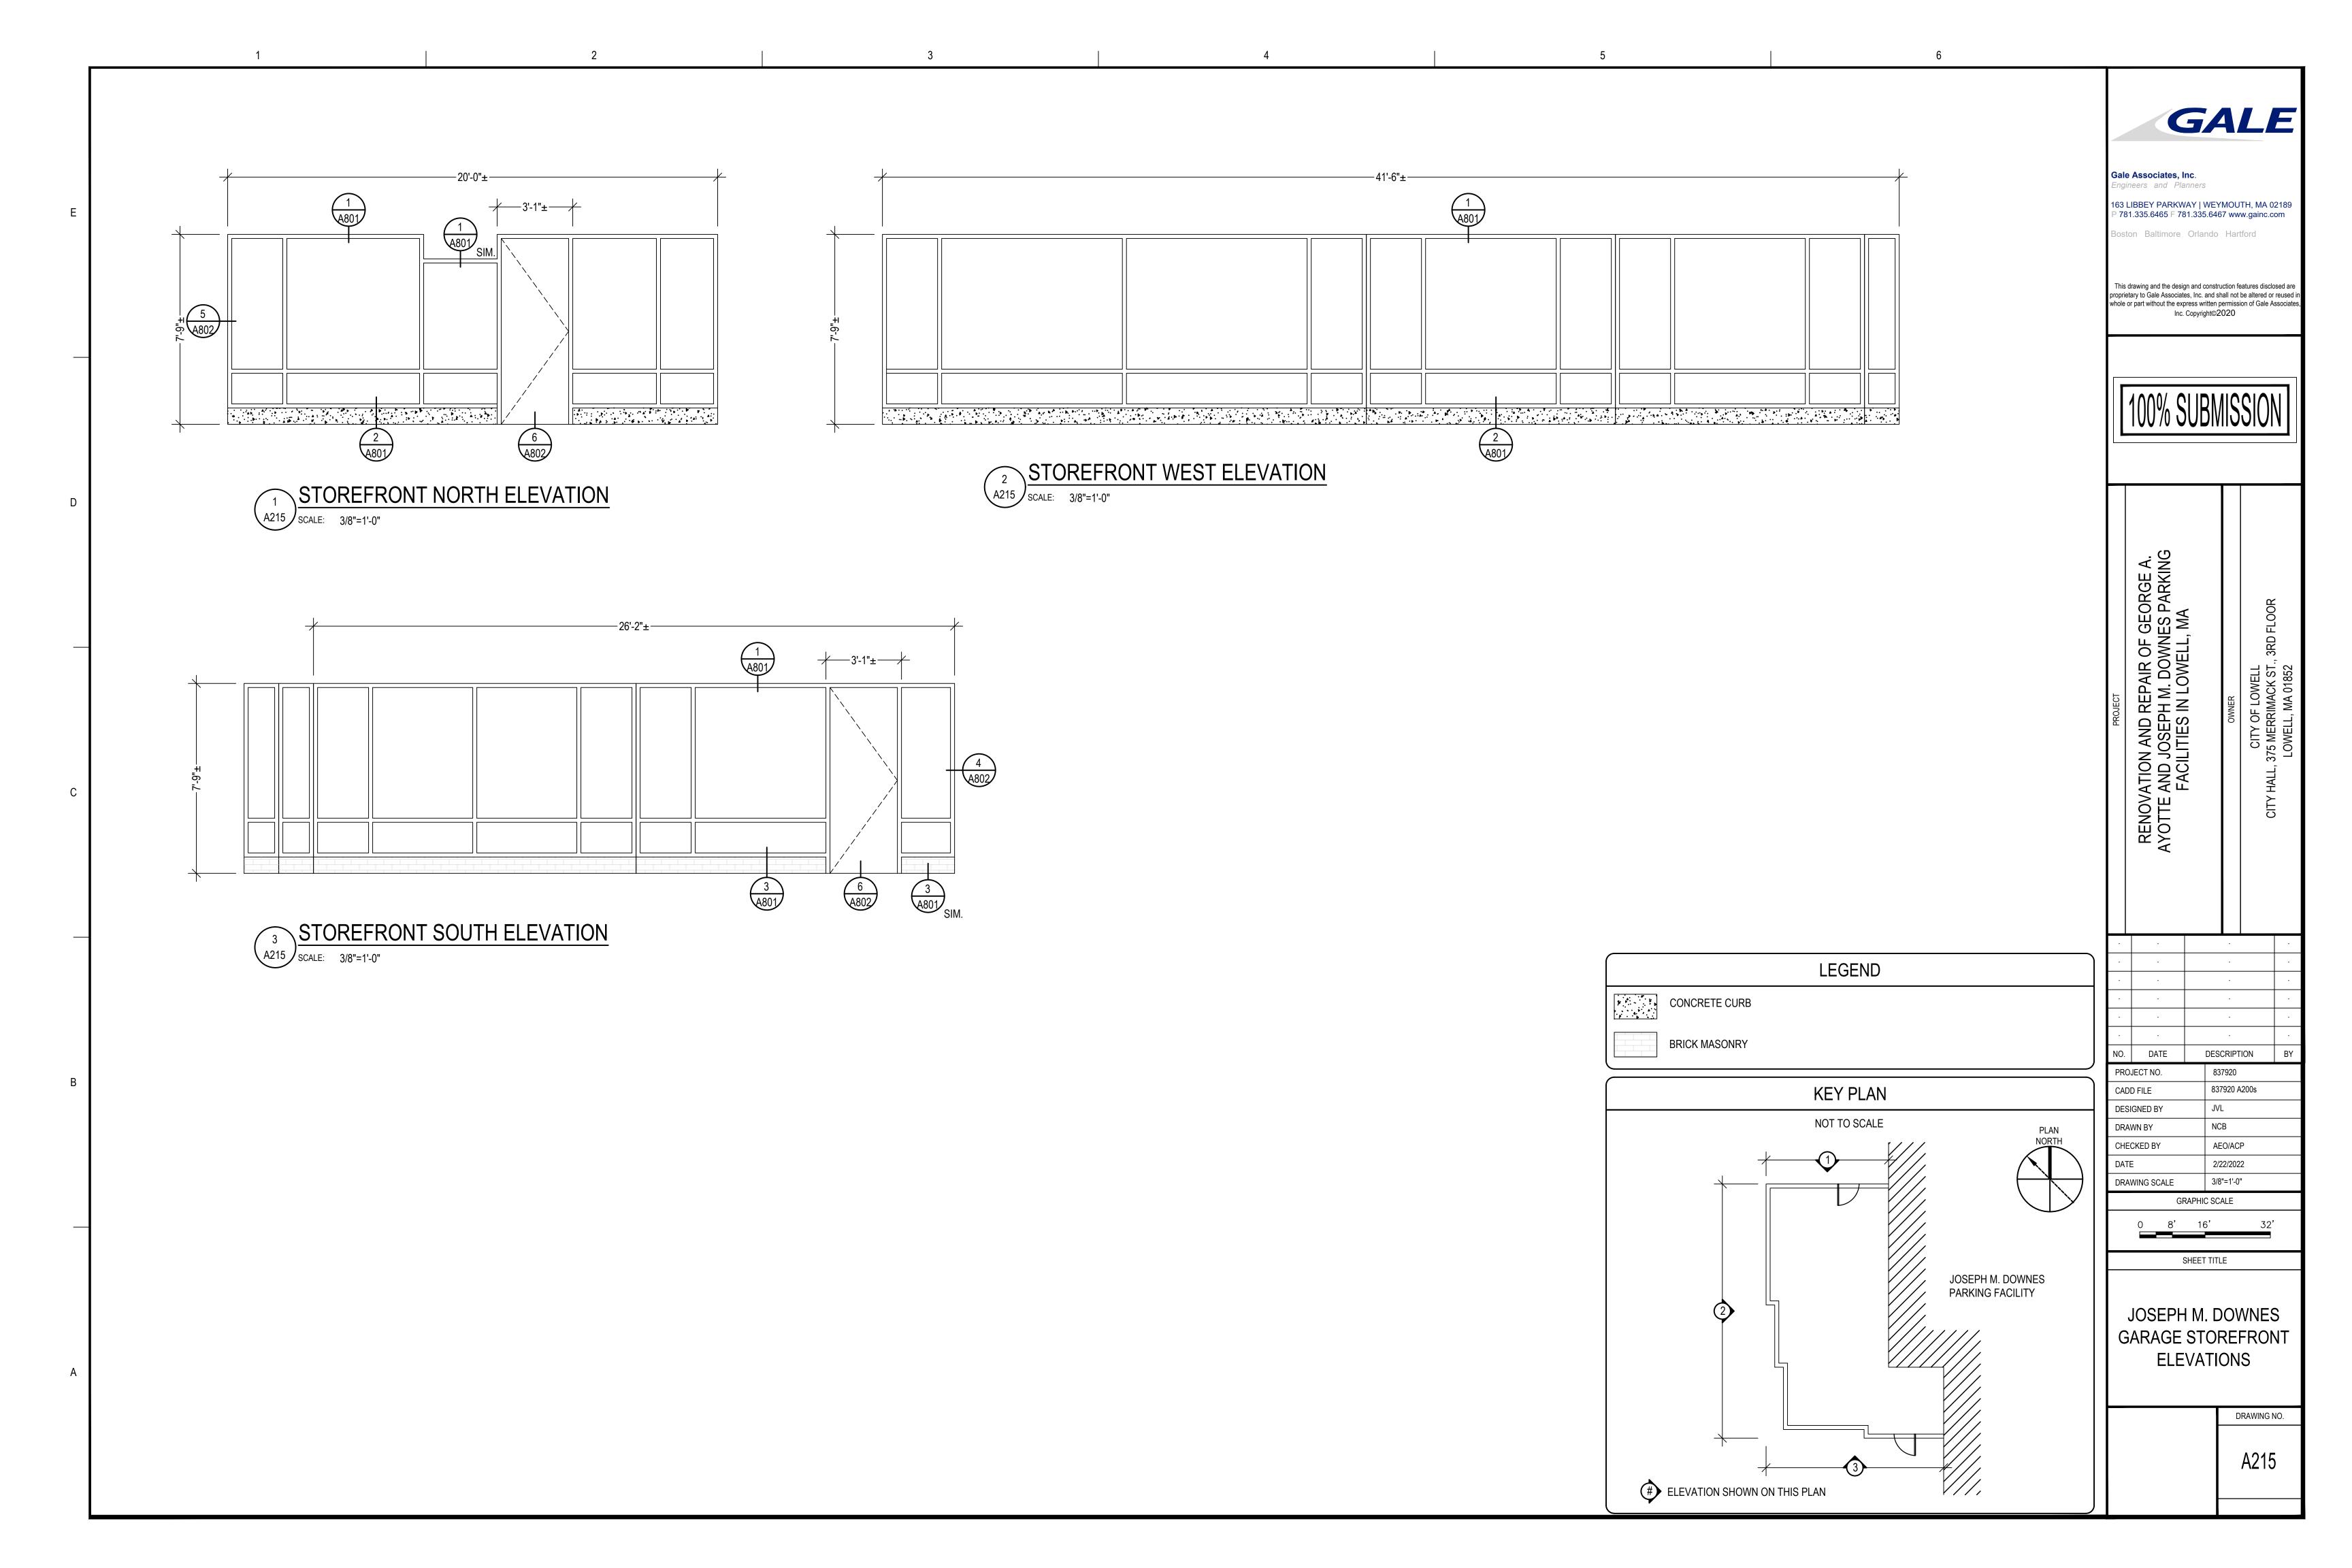
CADD FILE DESIGNED BY DRAWN BY CHECKED BY AEO/ACP


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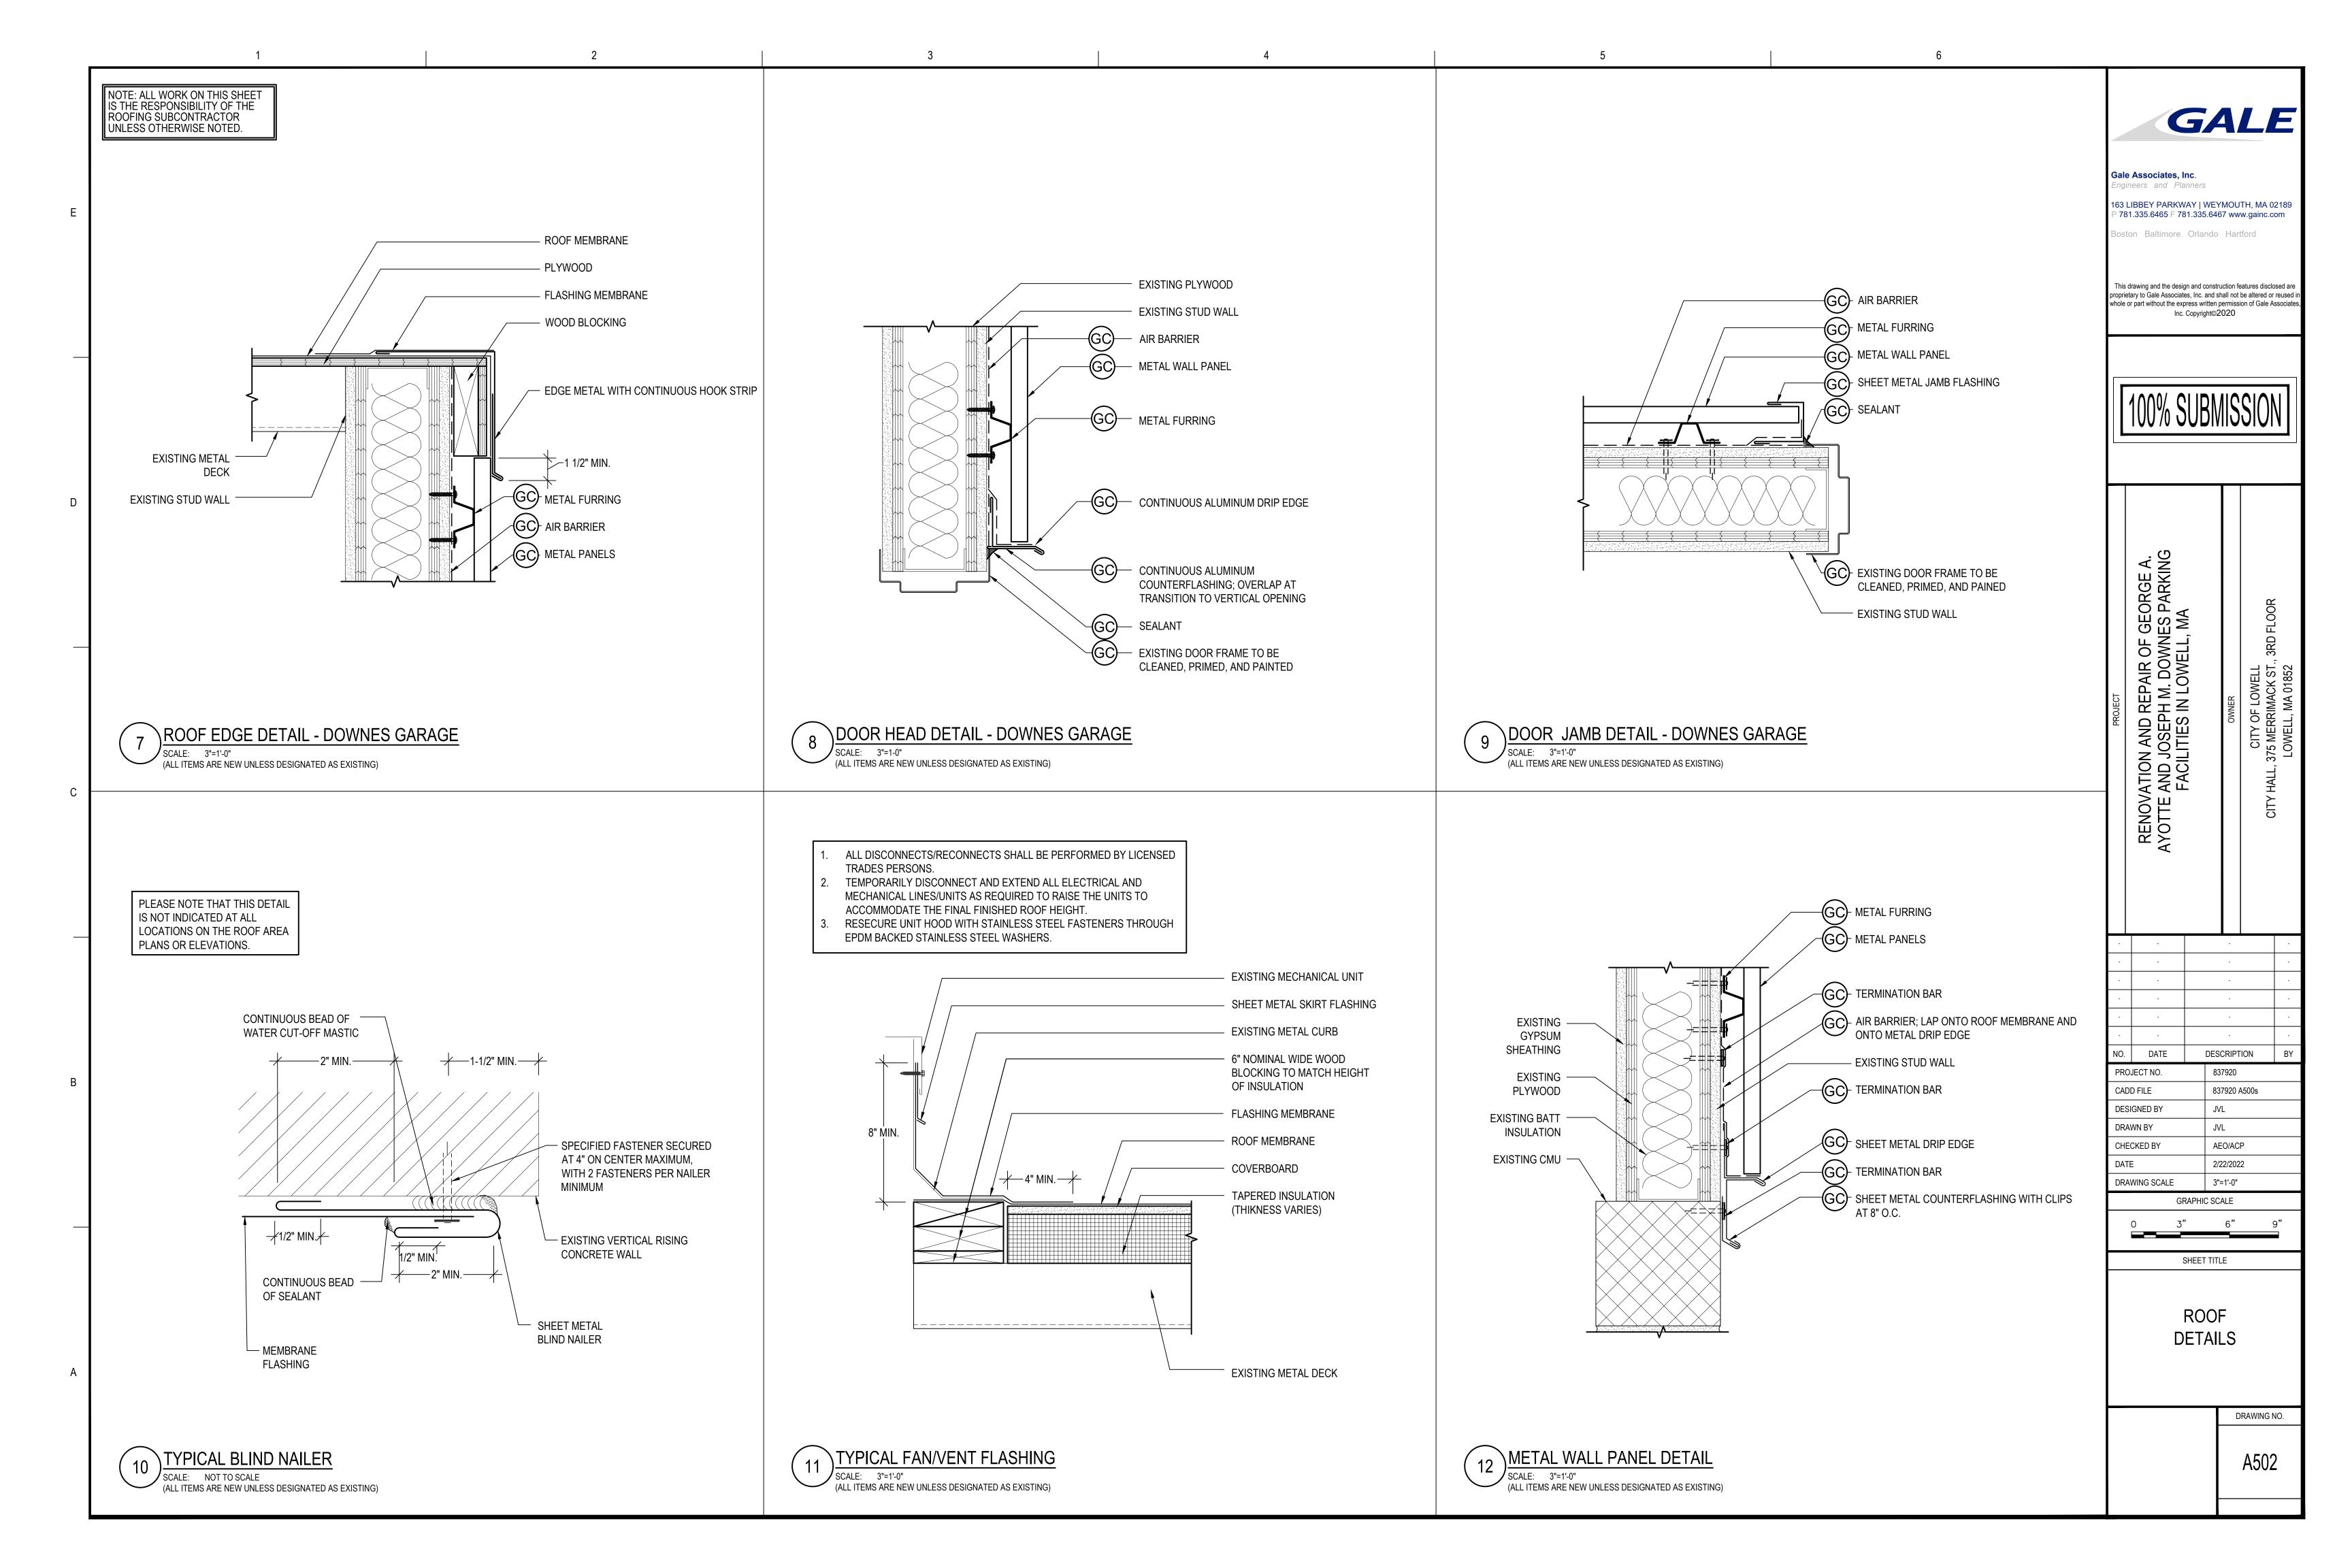
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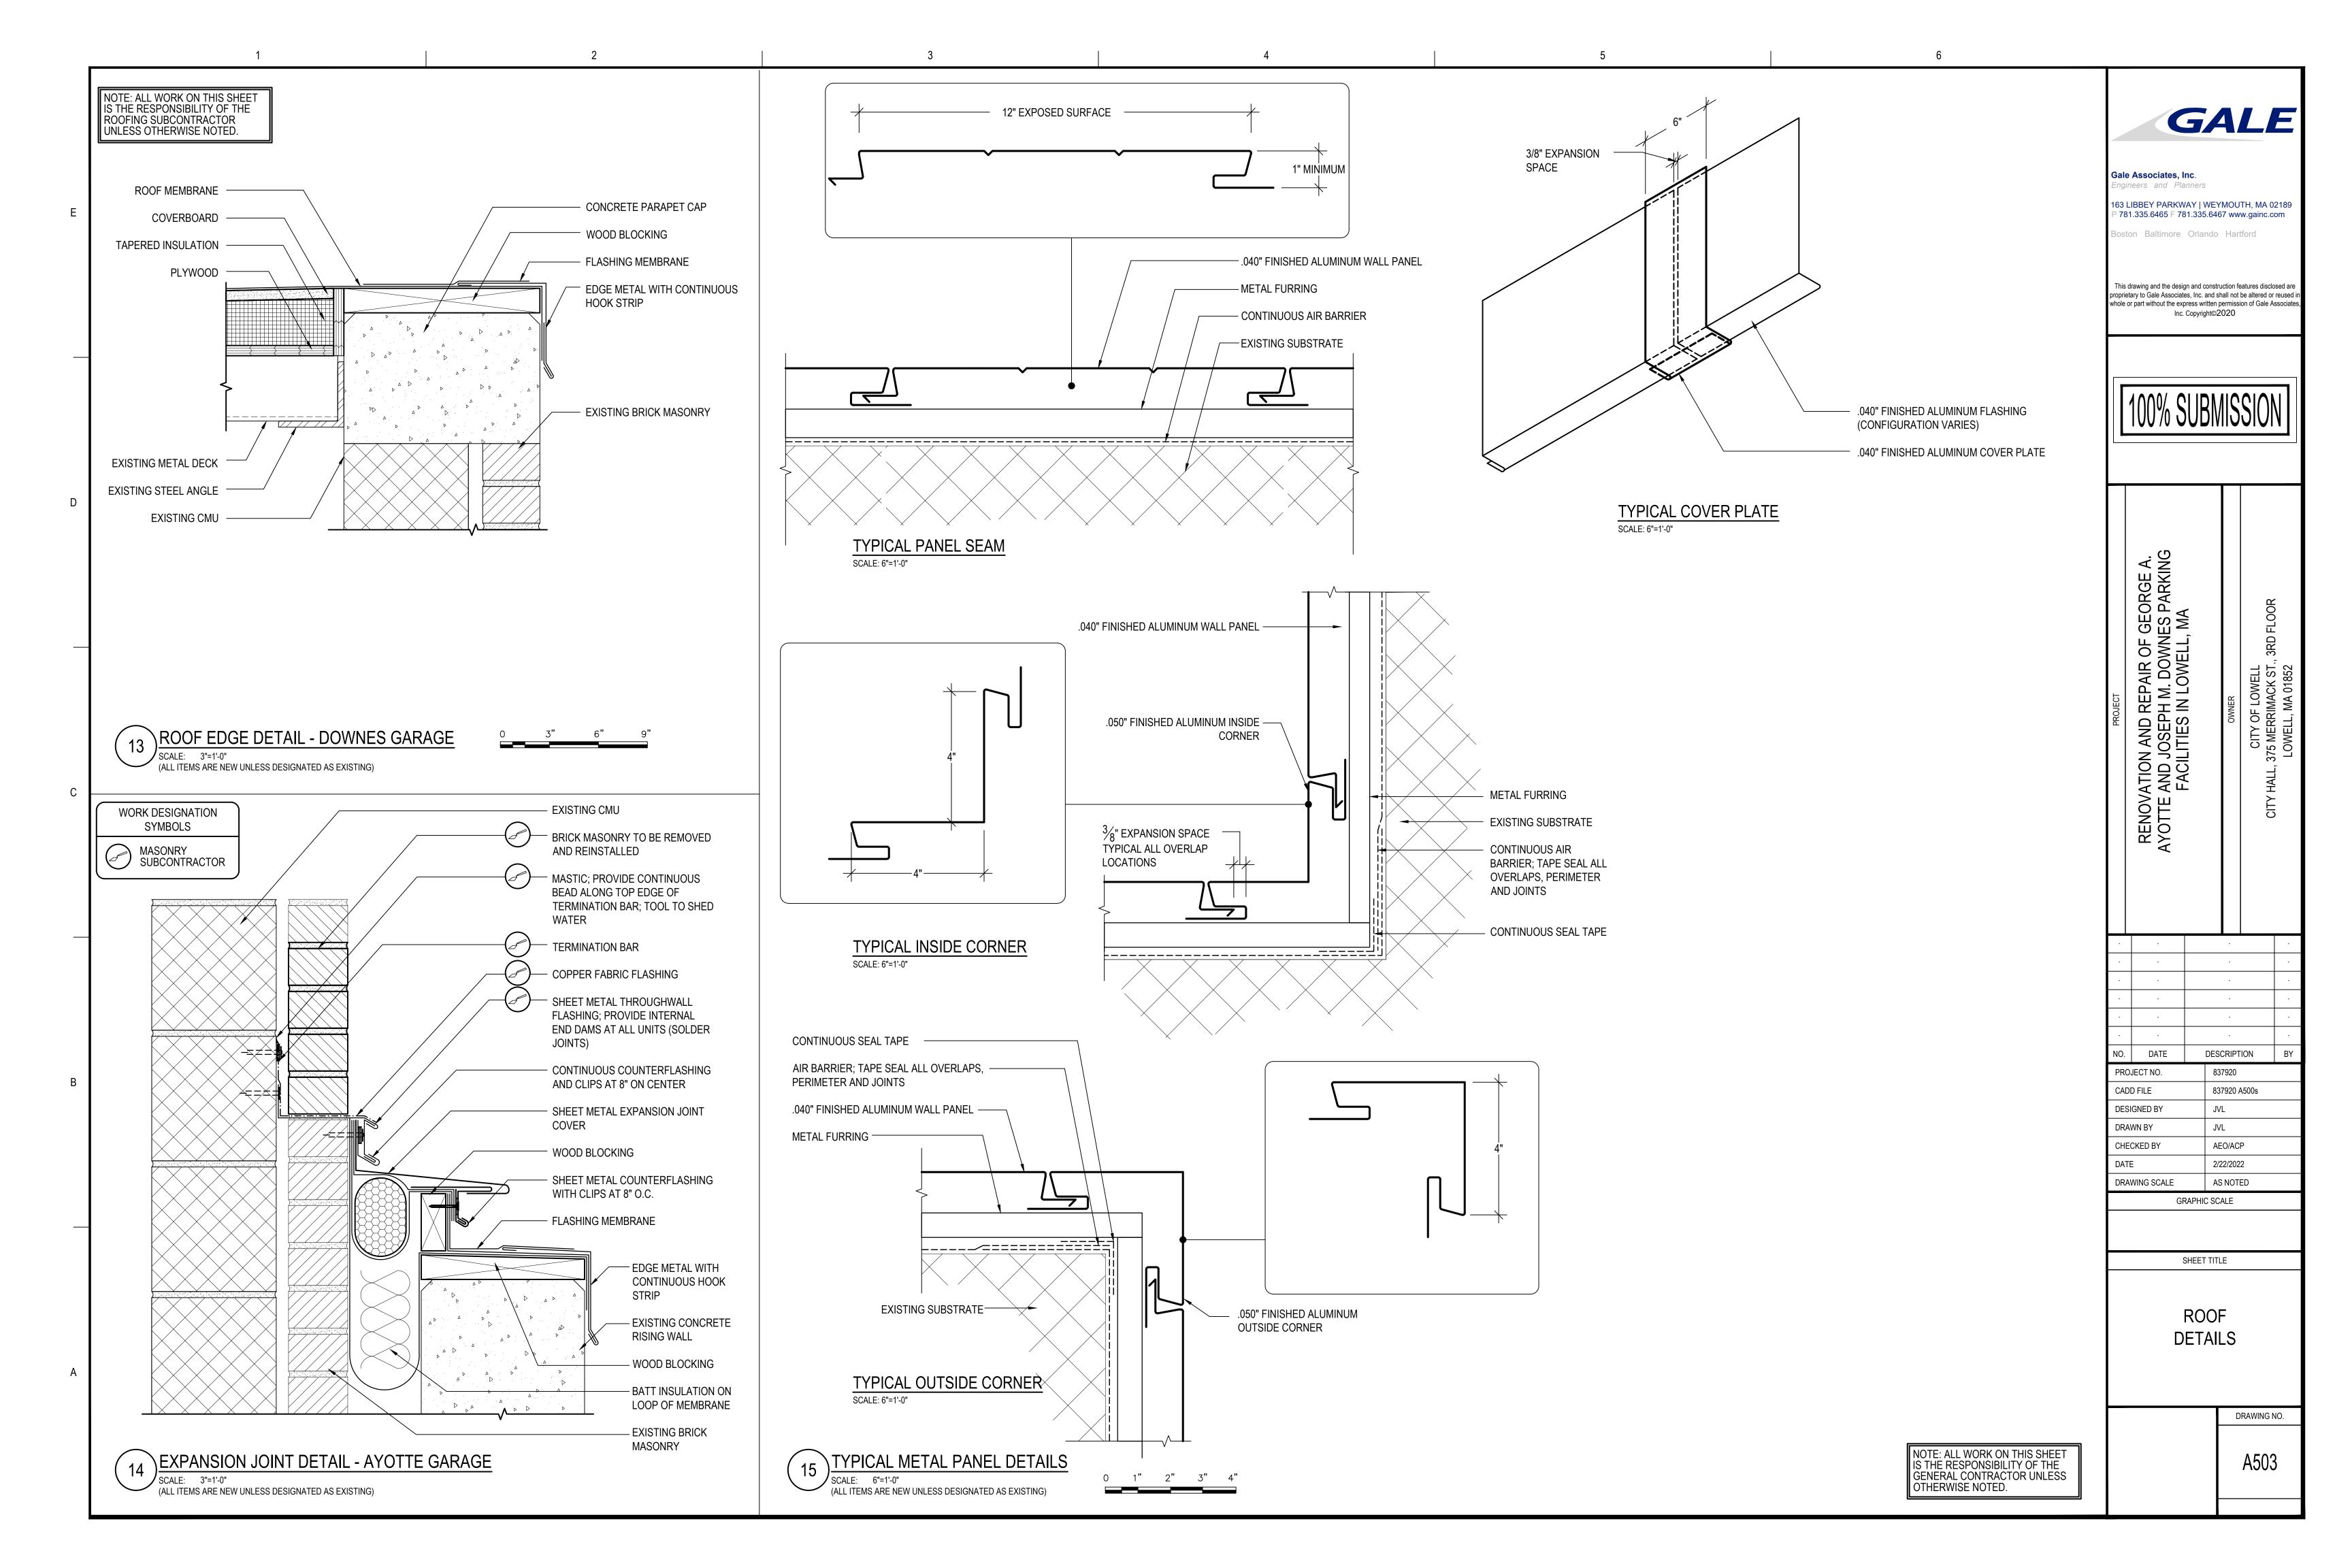
GEORGE A AYOTTE GARAGE PENTHOUSE **ELEVATIONS** 


DRAWING NO.








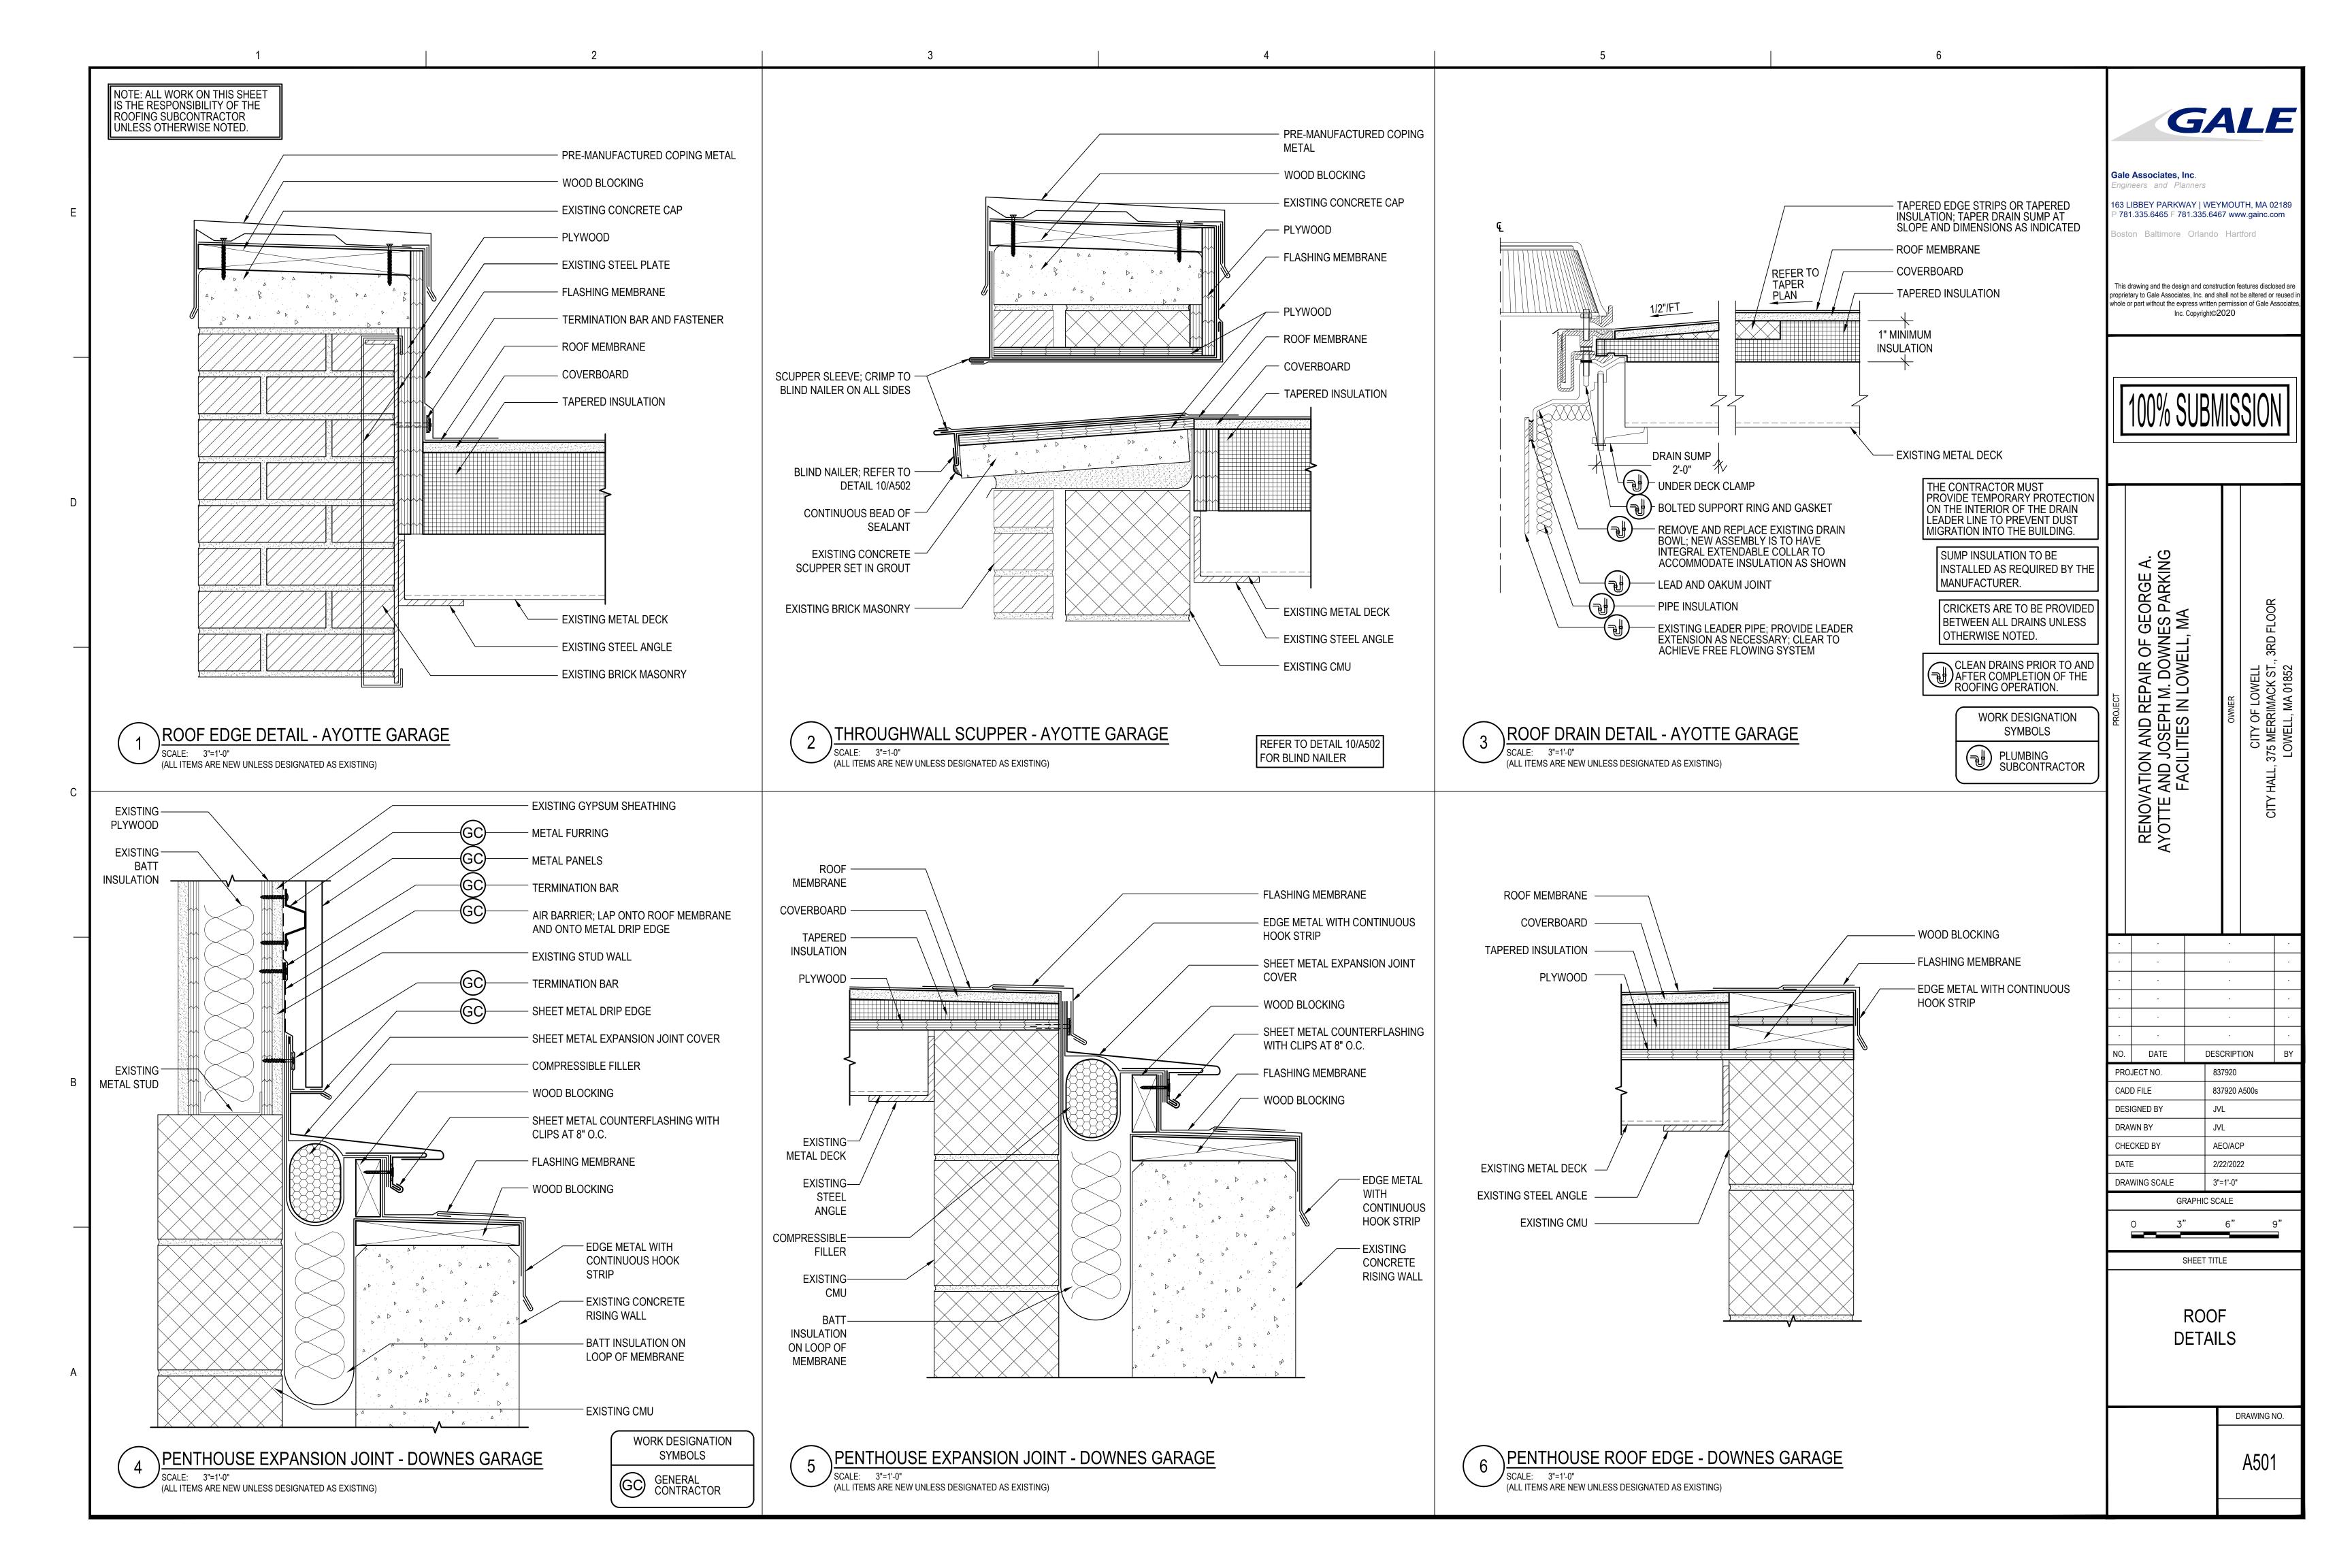

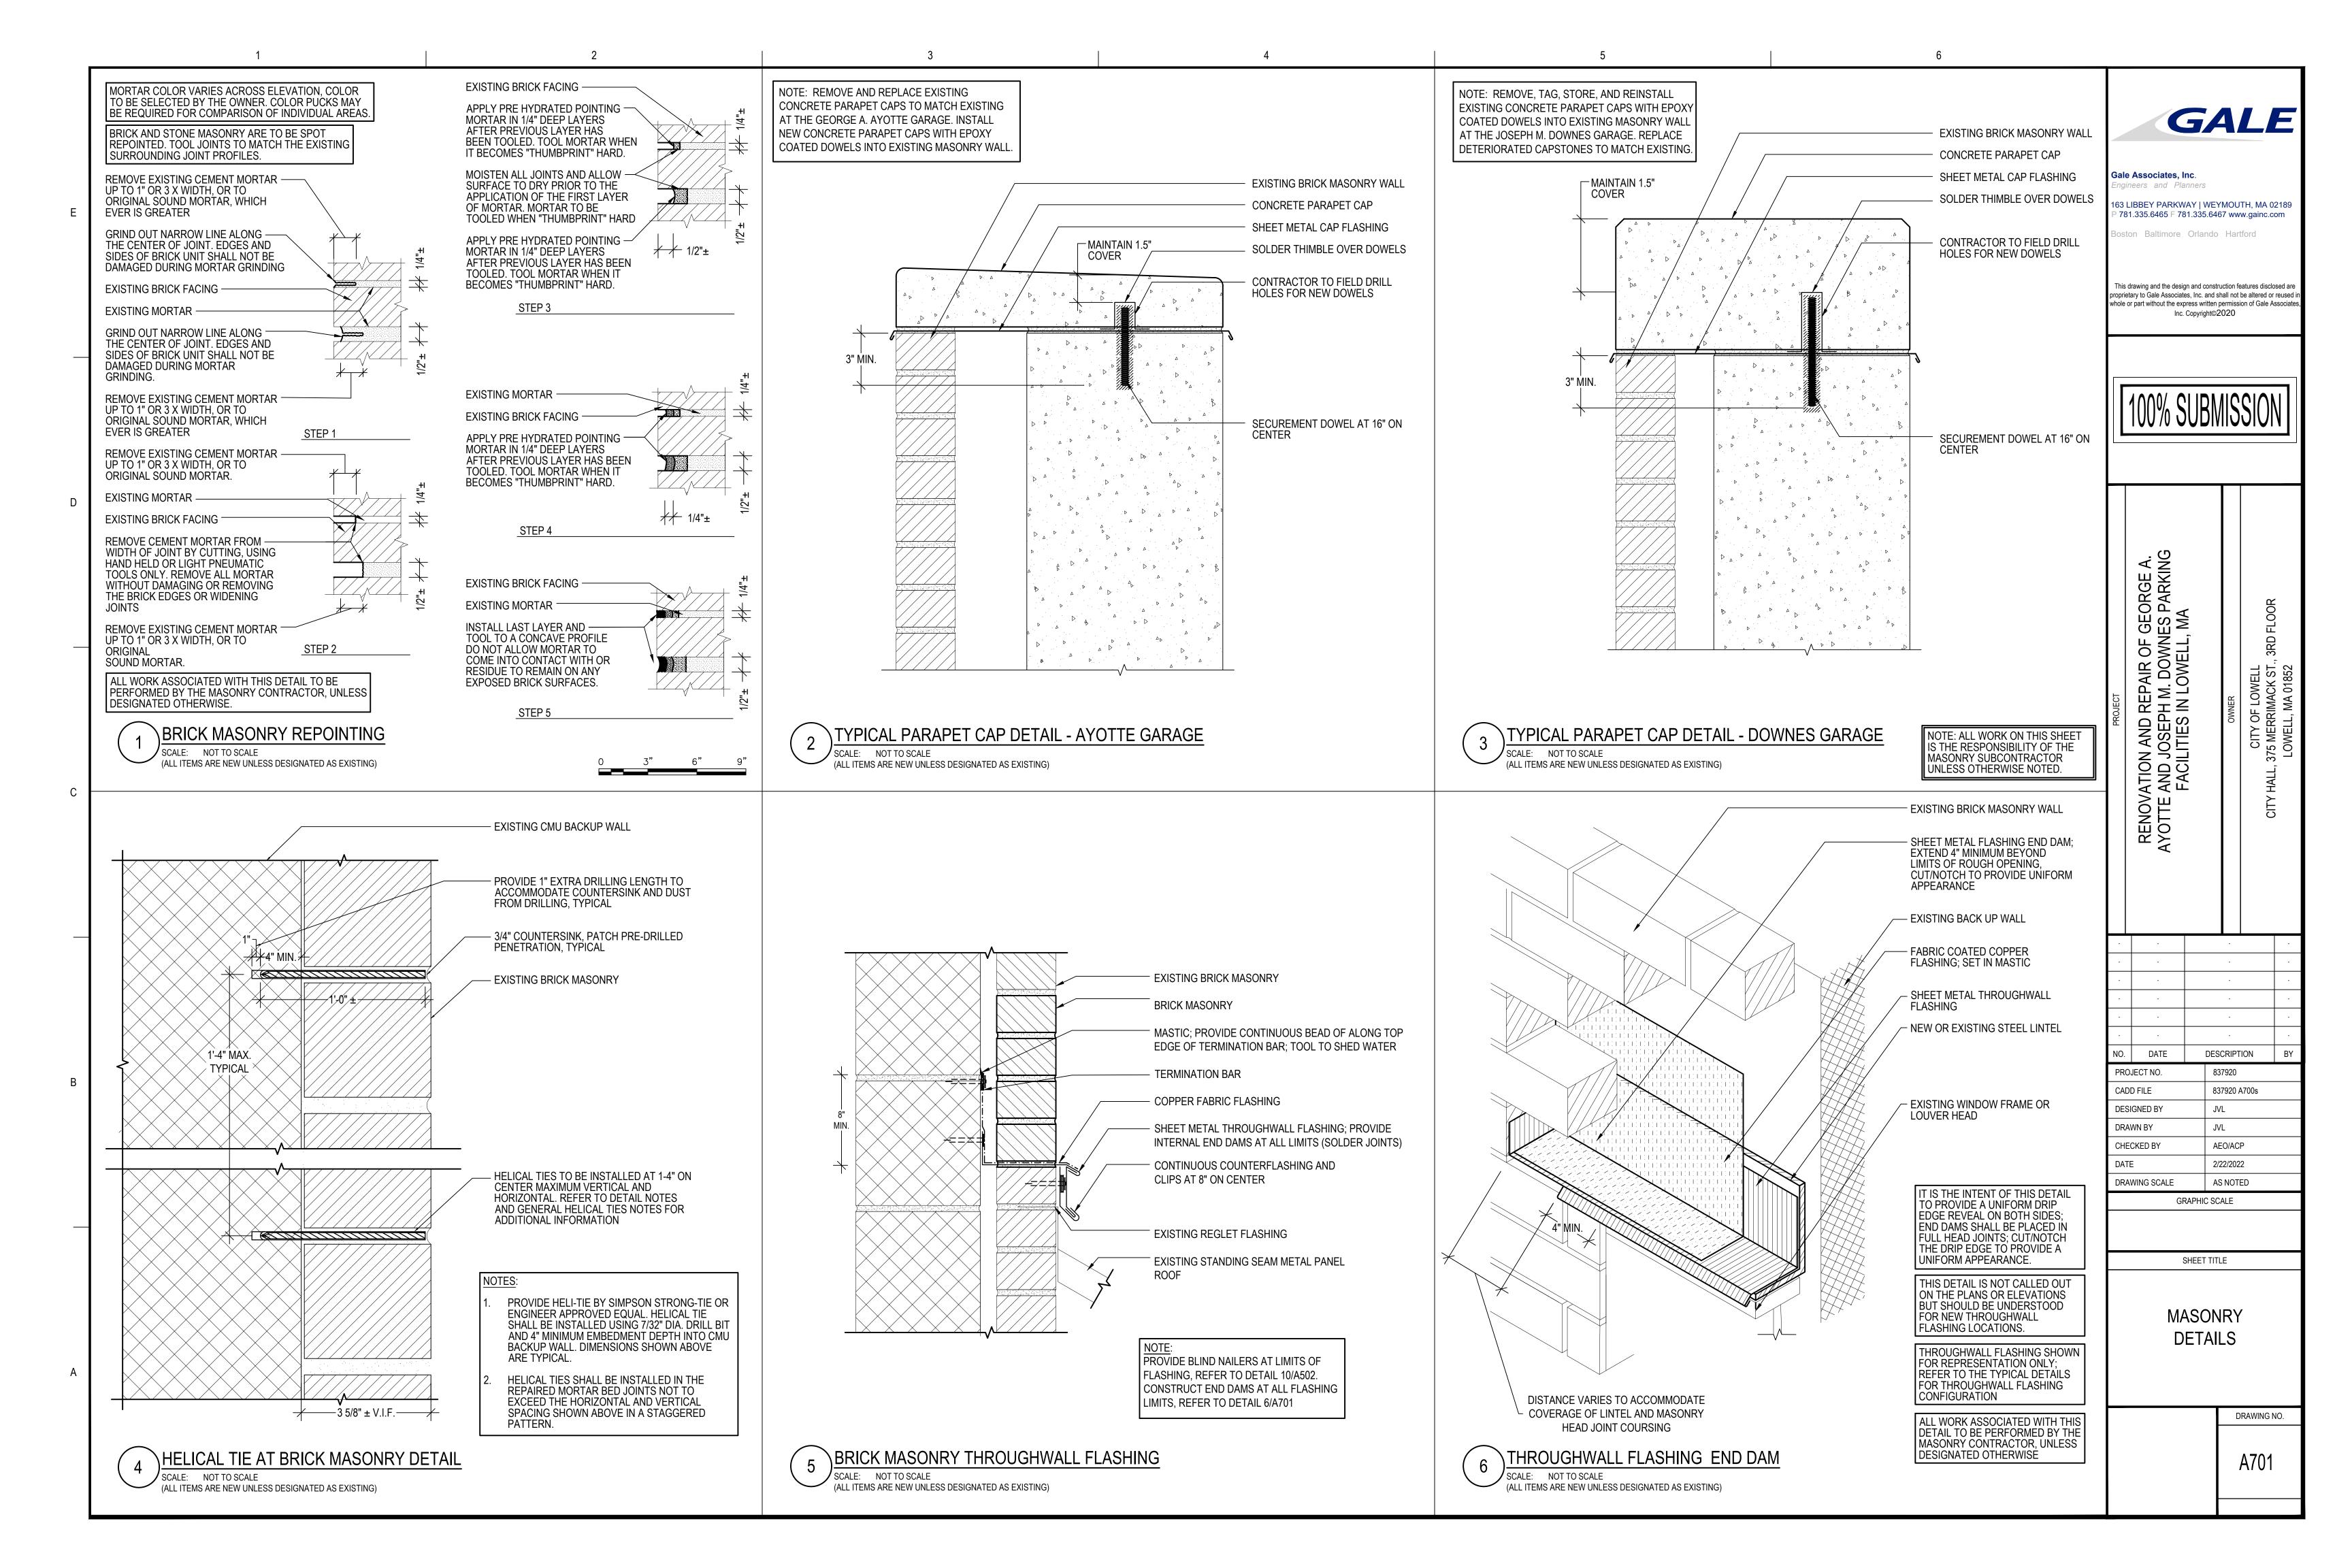

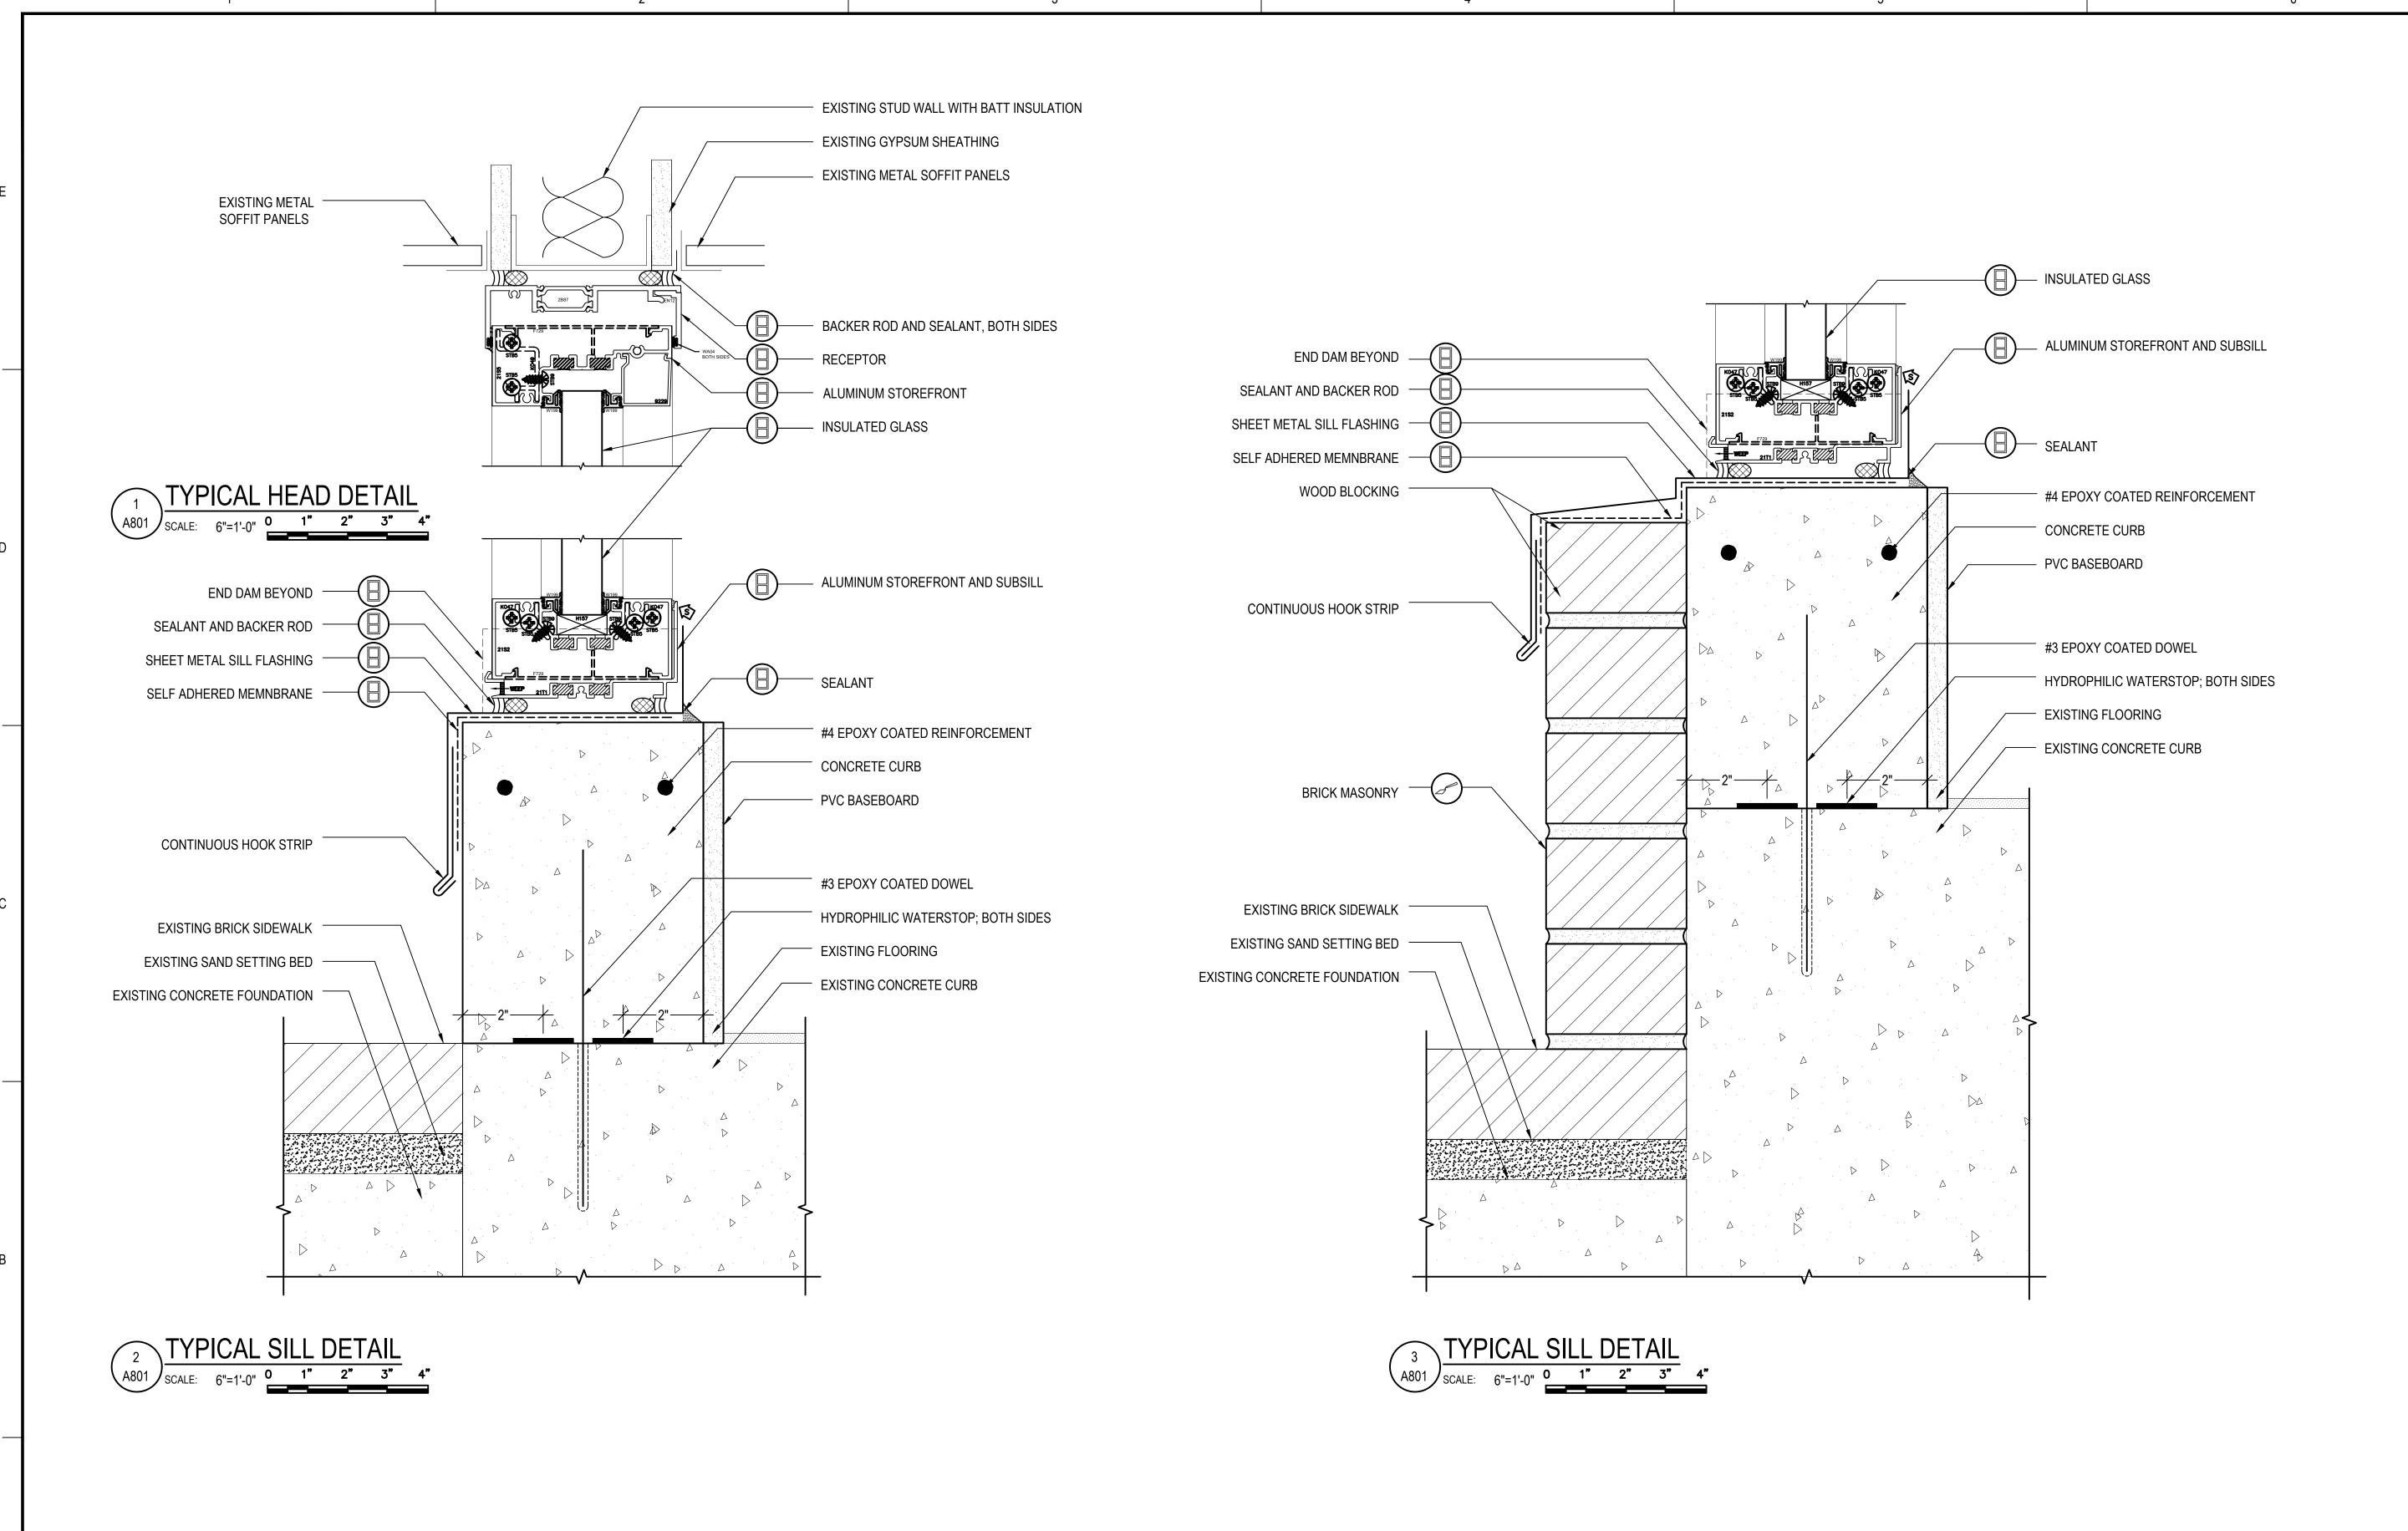

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GALE

NOTE: ALL WORK ON THIS PAGE IS THE RESPONSIBILITY OF THE GENERAL CONTRACTOR UNLESS OTHERWISE NOTED.

EXISTING BRICK MASONRY


SEALANT AND BACKER ROD


RECEPTOR


ALUMINUM STOREFRONT


INSULATED GLASS


EXISTING INTERIOR FINISH

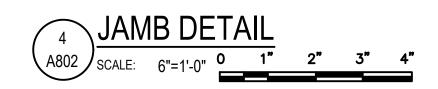

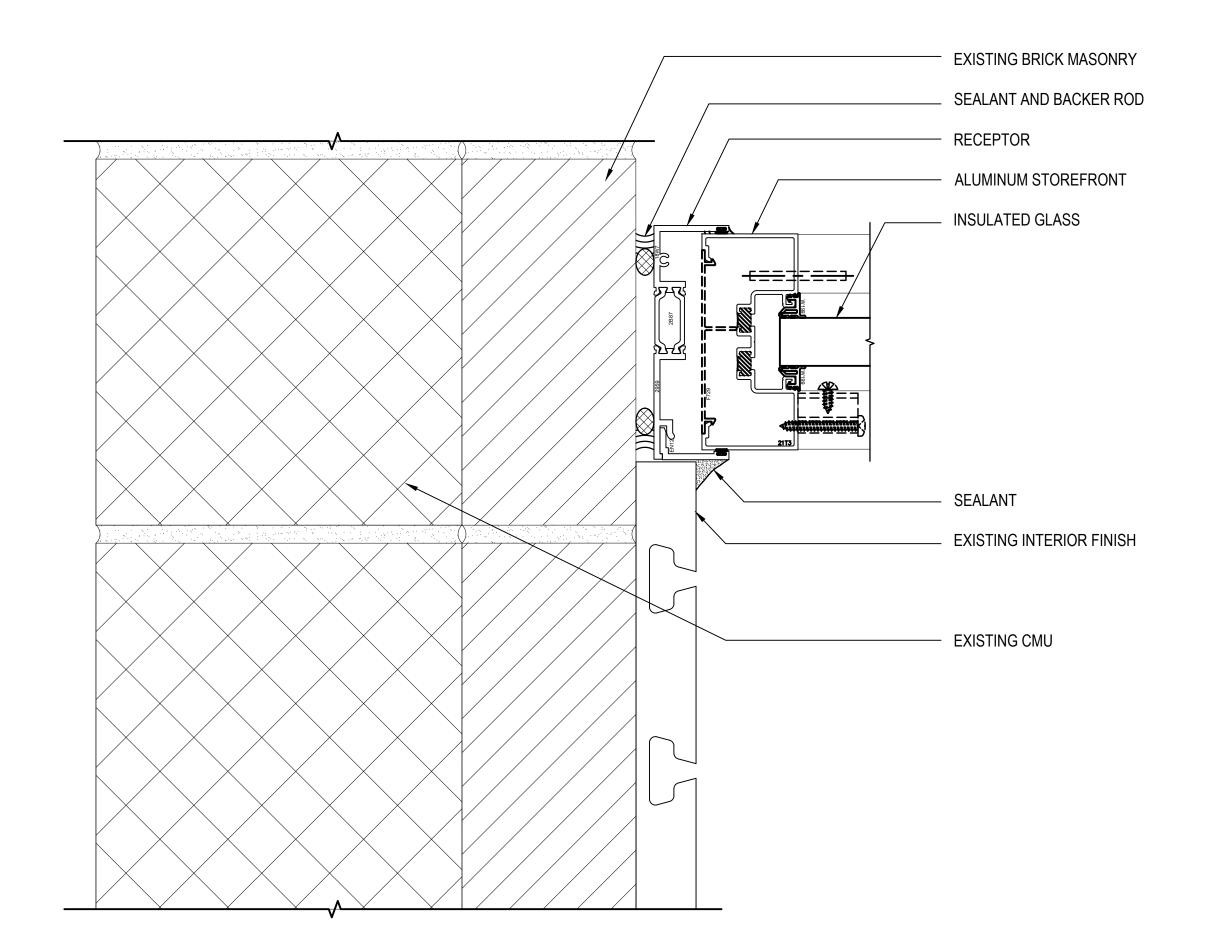

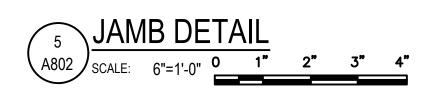

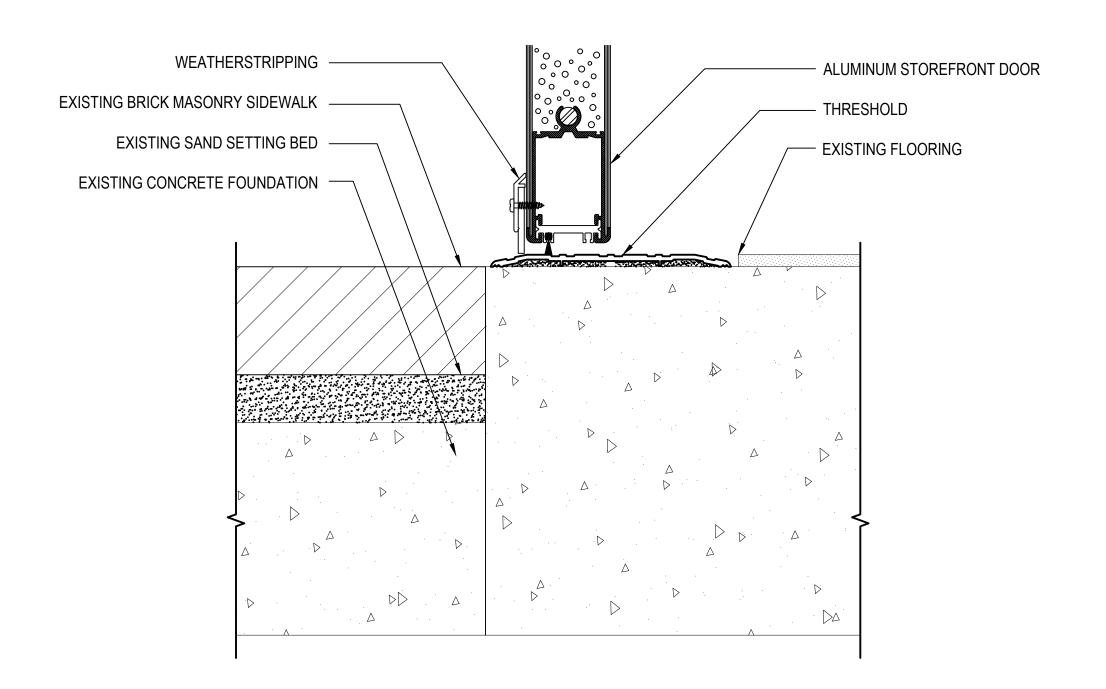

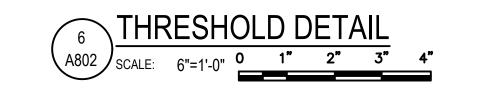

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100% SUBMISSION

RENOVATION AND REPAIR OF GEORGE A. AYOTTE AND JOSEPH M. DOWNES PARKING FACILITIES IN LOWELL, MA  OWNER  CITY OF LOWELL CITY HALL, 375 MERRIMACK ST., 3RD FLOOR

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NO.	DATE	DESCRIPTION		BY
PROJECT NO.		837920		
CADD FILE		837920 A800s		
DESIGNED BY		JVL		
DRAWN BY		JVL		
CHECKED BY		AEO/ACP		
DATE		2/22/2022		
DRAWING SCALE		6"=1'-0"		
GRAPHIC SCALE				

0 2' 4' 6'

SHEET TITLE

STOREFRONT DETAILS

DRAWING NO.

NOTE: ALL WORK ON THIS PAGE IS THE RESPONSIBILITY OF THE WINDOW SUBCONTRACTOR UNLESS OTHERWISE

A802

#### **GENERAL NOTES:**

- 1. THE GENERAL AND SUBCONTRACTORS INSTALLING WORK DEFINED IN THE CONTRACT DOCUMENTS SHALL CONFORM TO THE CURRENT EDITION OF THE COMMONWEALTH OF MASSACHUSETTS STATE BUILDING CODE (CMR 780), PROJECT SPECIFICATIONS, AND THIS DESIGN PACKAGE.
- 2. FOR THE SAKE OF CLARITY, EACH INDIVIDUAL DETAIL ON THE PARKING LEVEL FLOOR PLANS HAS NOT BEEN INDICATED. INSTALLATION DETAILS HAVE BEEN INDICATED FOR TYPICAL COMPONENTS AT RANDOM LOCATIONS.
- HATCH PATTERNS ARE FOR REPRESENTATION ONLY AND SHOULD NOT BE USED A MEANS FOR QUANTIFYING.
- 4. DISCREPANCIES NOTED BY THE CONTRACTOR IN THE DRAWINGS OR SPECIFICATIONS MUST BE BROUGHT TO THE OWNER'S ATTENTION PRIOR TO BID SUBMISSION.
- ALL ITEMS OF CONSTRUCTION SHALL BE IN ACCORDANCE WITH LOCAL, STATE AND FEDERAL REGULATIONS APPLICABLE TO THE PROJECT.
- 6. THE CONTRACTOR SHALL REPORT DETERIORATED OR UNSUITABLE STRUCTURAL CONCRETE OR SUBSTRATES TO THE OWNER AND ENGINEER IN WRITING PRIOR TO PERFORMING OR CONTINUING WITH THE WORK.
- THE CONTRACTOR IS RESPONSIBLE FOR SEGREGATING WORK AREAS FROM THE GENERAL PUBLIC USING SIGNS, CONES, CAUTION TAPE, ETC. THE CONTRACTOR SHALL CONTAIN ALL DUST AND DEBRIS DURING ALL PHASES OF THE WORK.
- UPON COMPLETION OF THE WORK AND PRIOR TO FINAL PAYMENT, THE CONTRACTOR SHALL SUBMIT AN ALL-INCLUSIVE LABOR AND MATERIALS GUARANTEE OF THE WORK TO BE FREE FROM DEFECTS IN MATERIALS AND WORKMANSHIP. THIS GUARANTEE SHALL BE FOR A PERIOD OF TWO (2) YEARS AND SHALL BE SIGNED BY A PRINCIPAL OF THE CONTRACTOR'S FIRM AND SEALED IF A CORPORATION.
- 9. THE CONTRACTOR'S BASE BID FOR THIS PROJECT MUST INCLUDE ALL LABOR, MOBILIZATION, PERMITTING, MATERIALS, TEMPORARY PROTECTION, ETC. NO ADDITIONAL COSTS WILL BE SUBMITTED TO THE OWNER OR ENGINEER IN ORDER TO COMPLETE THE INTENT OF THE WORK AS INDICATED ON THE DESIGN DRAWINGS.
- 0. THE CONTRACTOR PERSONNEL PRESENT AT THE SITE DURING ALL PHASES OF THE WORK MUST BE MAINTAINED BY THE CONTRACTOR FOR THE DURATION OF THE WORK. THE CONTRACTOR'S WORKERS SHALL NOT BE CHANGED OR ROTATED DURING THE DURATION OF THIS PROJECT UNLESS SPECIFICALLY TRAINED FOR THIS PARTICULAR RENOVATION PROJECT AND APPLICATION - NO EXCEPTIONS.
- 11. THE CONTRACTOR IS TO COORDINATE ON-SITE USE OF WATER & ELECTRICITY WITH THE OWNER.
- 12. WATERPROOFING AND CONCRETE REPAIR MATERIAL MANUFACTURER'S TECHNICAL REPESENTATIVE AND SUBCONTRACTORS MUST BE PRESENT AT THE PROJECT PRECONSTRUCTION MEETING AND MUST INCLUDE PERIODIC SITE VISITS WITH FORMAL REPORTING AS SPECIFIED.

#### DEMOLITION NOTES

- 1. NO DEMOLITION WORK SHALL PROCEED UNTIL A PLAN HAS BEEN SUBMITTED TO AND APPROVED BY THE OWNER AND ENGINEER DETAILING THE METHODS AND EQUIPMENT TO BE USED TO DEMOLISH AND/OR SURFACE PREPARE STRUCTURES AND FEATURES.
- 2. ALL DEMOLISHED MATERIALS AND DEBRIS SHALL BE LEGALLY DISPOSED OF OFF SITE IN A MANNER SATISFACTORY TO THE OWNER AND CURRENT DEP/MEPA REQUIREMENTS.

#### PROTECTION OF EXISTING STRUCTURES:

EXISTING STRUCTURES, UTILITY LINES AND EMBEDDED UTILITIES MUST BE COORDINATED WITH AND IDENTIFIED BY THE OWNER AND CONTRACTOR, AND MARKED ON-SITE PRIOR TO INITIATING CONSTRUCTION. IN THE EVENT THAT ANY UNMARKED OR UNKNOWN STRUCTURE/UTILITY ARE UNCOVERED BY THE CONTRACTOR, WORK MUST HALT AND THE CONTRACTOR SHALL REPORT ITS FINDINGS TO THE OWNER'S SITE REPRESENTATIVE FOR INSTRUCTIONS BEFORE PROCEEDING FURTHER. THE EXISTING STRUCTURES AND UTILITIES WHICH ARE ADJACENT TO THE SITE AND THOSE TO REMAIN WITHIN THE LIMITS OF THE WORK SHALL BE PROTECTED AGAINST DAMAGE. THE CONTRACTOR SHALL BE FULLY RESPONSIBLE TO THE OWNER IN THE EVENT OF REMOVAL OF OR DAMAGE TO ANY EXISTING OBJECTS BY CONTRACTORS PERSONNEL, WHICH ARE INTENDED BY THE OWNER TO REMAIN IN PLACE.

#### QUALITY ASSURANCE:

- CONTRACTOR MUST COORDINATE AND PAY FOR ALL MATERIAL MANUFACTURER'S SITE VISITS TO REVIEW CONSTRUCTION. AT A MINIMUM, THE MANUFACTURER'S TECHNICAL REPRESENTATIVE SHALL BE ON SITE FOR THE FOLLOWING REVIEWS:
- A. PRE-CONSTRUCTION MEETING.
- B. CONCRETE PREPARATION PRIOR TO INSTALLATION OF MATERIALS.
- C. REVIEW MATERIAL STORAGE, MIXING, SURFACE PREPARATION, APPLICATION, CURING AND TEMPORARY PROTECTION FOR EACH MATERIAL TYPE OR COMPONENT.
- D. MINIMUM ONE (1) SITE VISITS PER WEEK DURING INSTALLATION. MOCK-UP OF EACH REPAIR TYPE WITH MANUFACTURER'S REPRESENTATIVE PRESENT.
- E. PERIODIC TESTING OF MATERIAL THICKNESS TO CONFIRM CONFORMANCE TO MANUFACTURER'S WRITTEN TECHNICAL DATA AND THESE CONTRACT DOCUMENTS.
- 2. FOR EACH SITE VISIT, THE MANUFACTURER'S REPRESENTATIVE MUST PROVIDE A WRITTEN FIELD REPORT INDICATING AREAS REVIEWED, PROCEDURES USED, RECOMMENDATIONS MADE, INCORRECT INSTALLATIONS, CORRECTIVE ACTIONS AND PHOTOGRAPHIC DOCUMENTATION. THE WRITTEN FIELD REPORT MUST INCLUDE DATE, TIME, COMPLETE LIST OF PERSONNEL ON SITE, AREAS REVIEWED WITH SKETCH PLAN IDENTIFICATION; PLACED WITH PHOTO DOCUMENTS ON MANUFACTURER'S COMPANY LETTERHEAD.
- 3. THE CONTRACTOR SHALL OBTAIN AND PROVIDE COPIES OF ALL MATERIAL AND SYSTEM WARRANTIES TO THE OWNER.

#### CONCRETE REPAIR NOTES

- ALL CONCRETE REPAIRS SHALL BE PERFORMED IN ACCORDANCE WITH THESE TECHNICAL NOTES
  AND REPAIR DETAILS AS WELL AS MANUFACTURER'S SPECIFIC REQUIREMENTS FOR THE
  SPECIFIED PRODUCTS.
- 2. DO NOT FEATHER EDGE ANY REPAIRS. THE MIN. REPAIR MORTAR APPLICATION THICKNESS IS PREFERRED TO BE 1", HOWEVER, NEVER LESS THAN ½" THICK AT PERIMETERS.
- 3. ALL LOOSE, DETERIORATED, PUNKY, SOFT, CARBONATED, DELAMINATING, SEGREGATED, CRACKED AND OTHER DEFICIENT CONCRETE MUST BE FULLY REMOVED DOWN TO SOLID CONCRETE SUBSTRATE. NOTIFY ENGINEER IF FULL DEPTH REPLACEMENT IS REQUIRED OR IF CRACKS ARE OBSERVED BEHIND THE SPALL AFTER THE DETERIORATED CONCRETE IS REMOVED.
- 4. PERIMETERS OF ALL SPALL REPAIRS MUST BE SAW-CUT TO A "NORMAL" STRAIGHT EDGE IN A POLYGON SHAPE. IN NO CASE REINFORCING STEEL OR OTHER EMBEDDED ITEMS BE CUT OR DAMAGED. THE CONTRACTOR MUST PROVIDE GROUND PENETRATING RADAR OR OTHER MEANS OF ELECTRONIC SCANNING TO LOCATE AND MARK EMBEDDED STEEL TO AVOID CUTTING. DAMAGE TO ANY STEEL REINFORCING OR OTHER EMBEDDED ITEMS DUE TO CUTTING/ REMOVAL OF THE DETERIORATED CONCRETE SHALL BE REPAIRED AT NO ADDITIONAL COST TO THE OWNER. THE CONTRACTOR MUST PROVIDE ELECTRIC CURRENT SCANNING TO LOCATE AND MARK EMBEDDED CONDUIT.
- 5. ALL SPALL REPAIR AREA SUBSTRATES MUST BE THOROUGHLY EXAMINED AFTER COMPLETING THE FINAL SURFACE PREPARATION, TO VERIFY THAT NO ADDITIONAL SUBSTRATE CRACKING OR OTHER STRUCTURAL CONDITIONS EXIST. NOTIFY GALE IF ANY CRACKS OR OTHER DETERIORATED CONDITIONS ARE IDENTIFIED.
- 6. SPALL REPAIR SURFACE PROFILE MUST ACHIEVE AN ICRI-CSP 8 OR 9. WHERE ACCESS IS LIMITED OR DIFFICULT DUE TO PIPING OR OTHER OBSTRUCTIONS, THEN AN ICRI-CSP 7 SURFACE PROFILE MAY BE CONSIDERED AS APPROVED BY THE ENGINEER.
- 7. RUSTED REINFORCING STEEL BARS MUST BE FULLY CLEANED TO BRIGHT, SHINY STEEL TO CONFORM TO SSPC SP11 REQUIREMENTS. WHERE REINFORCING STEEL IS SHOWING SECTION LOSS OF 1/8" OR 25% OR MORE SECTION LOSS, SUPPLEMENTAL REINFORCING STEEL MUST BE PLACED TO ACHIEVE A MINIMUM OF 40 BAR DIAMETER LENGTH LAPS, AND TIED DIRECTLY ADJACENT TO SOLID BAR SECTIONS THAT DO NOT HAVE SECTION LOSS. ADDITIONAL CONCRETE REMOVAL AND DRILLING WILL BE REQUIRED TO PLACE THE NEW REINFORCING STEEL.
- 8. REMOVE ADDITIONAL CONCRETE BEHIND AND AROUND ALL REINFORCING STEEL BARS WHICH ARE CORRODED SO THAT PROPER AND THOROUGH CLEANING MAY BE ACHIEVED AROUND THE ENTIRE BAR. A MINIMUM OF 1" CLEAR, UNOBSTRUCTED SPACE AROUND EACH REINFORCING STEEL BAR MUST BE ACHIEVED ALONG THE FULL LENGTH OF THE BAR IN THE AREA OF THE SPALL REPAIR. CLEAN BARS TO ACHIEVE SSPC-SP11 COMPLIANCE. BARS MUST BE FULLY UNCOVERED TO COMPLY WITH THAT NOTED HEREIN, IF ANY PORTION OF THE REBAR IS EXPOSED AND IT IS RUSTED.
- 9. IN ALL CASES, THE EXISTING AND NEW REINFORCING STEEL MUST HAVE A MINIMUM CONCRETE/REPAIR MORTAR COVER OF 1 ½". NOTIFY THE ENGINEER IF MODIFICATION OF STEEL PLACEMENT OR CONCRETE THICKNESS IS REQUIRED TO ACHIEVE THIS REQUIREMENT.
- 10. WITH LARGE OR DEEPER SPALL REPAIR AREAS, WITH DEPTHS EXCEEDING 3 INCHES, IF NO EXISTING REBAR IS PRESENT, OR REBAR GRID (INNER AND OUTER GRIDS) IS SEPARATED BY MORE THAN 6 INCHES, THEN THE SUBSTRATE OF THE REPAIR MUST BE PINNED WITH STAINLESS STEEL, 8 MM HELICAL TIES; OR STAINLESS STEEL FULLY THREADED CAP SCREWS WITH HEX HEADS PROJECTING OUTWARD BY 2 INCHES INTO THE MEDIUM OF THE REPAIR. DRILL HOLES FOR THREADED BOLTS (CAP SCREWS) TO 1/8" TO 1/4" LARGER THAN THE BOLT DIAMETER. BOLT DIAMETERS SHALL BE 3/16" TO 1/4", AND SHALL BE EMBEDDED 2 INCHES INTO SOLID CONCRETE. USE SPECIFIED STRUCTURAL ADHESIVE TO PLACE THREADED ROD PINS. HELICAL ANCHOR PINS, IF USED, MUST BE DRIVEN USING THE MANUFACTURER REQUIRED DRIVING TOOL AND BIT. PLACE PINS A MAXIMUM OF 8 INCHES ON CENTER, AND TIE 2" X 2" X 14 GAGE HOT-DIP GALVANIZED OR STAINLESS STEEL MESH FROM PIN-TO-PIN. PLACE THE MESH 2" FROM THE BELLY OF THE PREPARED SPALL AREA, WHILE ALWAYS MAINTAINING A MINIMUM 1 1/2" OF CONCRETE/REPAIR MORTAR COVER AT THE OUTSIDE SURFACE OF THE REPAIR.
- 11. WHEN DRILLING INTO SOLID CONCRETE TO PLACE NEW SUPPLEMENTAL STEEL REINFORCING BARS, DRILL THE HOLES 1/4" LARGER THAN THE BAR DIAMETER. FULLY VACUUM, BLOW OUT (WITH OIL FREE COMPRESSED AIR) AND BRISTLE BRUSH OUT THE HOLES TO REMOVE ALL DUST, DEBRIS, LAITANCE, ETC. THE DEPTH OF THE HOLES MUST BE DETERMINED BY GALE BASED UPON BAR SIZE, LOCATION, AND NEED FOR DEVELOPMENT. THIS WILL BE DETERMINED ON A CASE BY CASE BASIS. IN NO CASE SHALL THE DRILLED HOLES BE LESS THAN THAT NOTED ON THE DESIGN DRAWINGS UNLESS APPROVED BY THE ENGINEER. IN NO CASE SHALL SUPPLEMENTAL BARS BE LESS THAN #4 BARS, UNLESS OTHERWISE APPROVED BY THE ENGINEER. IN MANY CASES, NEW REINFORCING STEEL BARS MAY BE #5 OR LARGER, DEPENDING UPON THE EXTENT OF REINFORCEMENT CORROSION AND NEED FOR SUPPLEMENTAL STEEL. BARS EMBEDDED INTO CLEANED DRILLED HOLES MUST BE FULLY ADHERED IN PLACE USING SIKADUR 31 HI-MOD AS MANUFACTURED BY SIKA CORPORATION. OR ENGINEER APPROVED EQUAL.
- 12. JUST PRIOR TO PLACING THE REPAIR MORTAR AND FORMWORK, THE ENTIRE SUBSTRATE OF THE SPALL REPAIR MUST BE THOROUGHLY CLEANED OF ALL BOND INHIBITING MATERIALS, BROUGHT TO SATURATED SURFACE DRY (SSD) CONDITION WITH POTABLE WATER, RECEIVE THE BONDING AGENT OR BRISTLE BRUSH APPLIED BONDING SLURRY (ALL AS REQUIRED BY THE MATERIAL MANUFACTURER), AND CLEANED REBAR COATED WITH SPECIFIED COATING. APPLY TWO (2) COATS OF THE SPECIFIED REBAR COATING ON CLEANED EXISTING STEEL WITHOUT SPILLING THE MATERIAL ON ANY OTHER SURFACES OR COMPONENTS. DO NOT ALLOW THE COATING TO DRY BETWEEN COATS, NOT DRY PRIOR TO APPLYING THE REPAIR MORTAR. ALL MATERIALS MUST BE APPLIED IN A "WET-ON-WET" CONDITION FOR GREATER BOND.
- 13. FOLLOW ALL CURRENT MANUFACTURER DATA SHEETS AND CURRENT ACI AND ICRI CONCRETE REPAIR REQUIREMENTS AND CODE REGULATIONS FOR PROPER PLACEMENT, VIBRATION, CURING AND STRIPPING OF FORMS.
- 14. ALL CONCRETE PATCH REPAIRS MUST BE APPLIED VIA FORM-AND-POUR METHODS. HAND PATCHING IS NOT ALLOWED ON THIS PROJECT.

#### CONCRETE REPAIR NOTES (CONTINUED)

- 15. THE FOLLOWING MATERIALS SHALL BE USED FOR THE CONCRETE REPAIRS
  - A. CONCRETE FORM AND POUR REPAIR MORTAR: SIKACRETE 211 FOR FULL DEPTH SPALLS; SIKAQUICK 1000 FOR PARTIAL DEPTH SPALLS, AS MANUFACTURED BY SIKA CORPORATION, OR ENGINEER APPROVED EQUAL. READY-MIX CONCRETE MAY BE USED AT FULL-DEPTH AND TRENCH DRAIN REPLACEMENT IF APPROVED BY THE ENGINEER.
  - B. SUPPLEMENTAL REINFORCING: ASTM 615, GRADE 60 DEFORMED BARS SIZED AS DETERMINED BY GALE BASED ON EXISTING CONDITIONS.
  - C. REBAR COATING (CORROSION INHIBITOR): SIKA ARMATEC 110 EPOCEM AS MANUFACTURED BY SIKA CORPORATION. OR ENGINEER APPROVED EQUAL.
  - D. STRUCTURAL ADHESIVE: SIKADUR 32 HI-MOD AS MANUFACTURED BY SIKA CORPORATION, OR ENGINEER APPROVED EQUAL.
- 16. THE CONTRACTOR SHALL HIRE AND COORDINATE THE SERVICES OF THE MANUFACTURER'S TECHNICAL FIELD REPRESENTATIVE TO VISIT THE SITE A MINIMUM OF ONE (1) TIME PER WEEK DURING THE CONSTRUCTION PERIOD. MANUFACTURER'S SITE VISITS ARE REQUIRED FOR THE CRACK AND CONCRETE REPAIR MORTAR APPLICATION. THE MANUFACTURER'S REPRESENTATIVE SHALL REVIEW MATERIAL STORAGE, MIXING, INSTALLATION, CURING, ETC. AND SUBMIT A WRITTEN FIELD REPORT INDICATING OBSERVATIONS AND RECOMMENDATIONS FOR EACH SITE VISIT.

#### TRAFFIC COATING NOTES:

- 1. EXISTING COATING SHALL BE REMOVED TO BARE CONCRETE BY HIGH PRESSURE WATERBLASTING (HYDRO-DEMOLITION) OR ENGINEER'S APPROVED EQUIVALENT METHOD. ALL EXISTING WATERPROOFING, DEBRIS, LOOSE CONCRETE, ETC. SHALL BE REMOVED TO PROVIDE AN OPEN CAPILLARY CONCRETE SURFACE FOR APPLICATION OF THE NEW COATING SYSTEM, AND MINIMUM SURFACE PROFILE TO COMPLY WITH ICRI-CSP 5.
- 2. THE TRAFFIC COATING SYSTEM MUST BE KELMAR T.E. EXPOSURE FOUR (4) WATERPROOFING SYSTEM BY TECHNICAL BARRIER SYSTEMS, INC. EXPOSURE FOUR (4) ALTERNATING WEAR COAT AND AGGREGATE BROADCAST. TOTAL SYSTEM THICKNESS SHALL BE 3/16" TO 1/4" MINIMUM.
- 3. THE EXISTING WATERPROOFING SYSTEM SHALL BE FULLY REMOVED VIA PARTIAL DEPTH HYDRO-DEMOLITION OR ENGINEER APPROVED MECHANICAL ABRASION EQUIVALENT, DOWN TO BARE CONCRETE. THE CONCRETE DECK SHALL BE CLEANED AND PREPPED TO AN OPEN CAPILLARY CONDITION WITH ALL DIRT, DEBRIS, AND OILS REMOVED. AT CONTRACTOR'S OPTION (AND ONLY IF APPROVED BY ENGINEER), THE EXISTING WATERPROOFING MAY BE REMOVED VIA MECHANICAL MEANS AND THE CONCRETE DECK PREPARED VIA SHOT-BLASTING.
- 4. A STRETCH COAT OF NEO V II C MEMBRANE SHALL BE INSTALLED OVER ALL CRACKS PRIOR TO INSTALLING MEMBRANE OVER THE ENTIRE AREA. THE STRETCH COAT SHALL BE MINIMUM 4" WIDE OVER ALL CRACKS. CRACKS AND CONTROL JOINTS GREATER THAN 1/16" WIDE SHALL BE ROUTED AND SEALED WITH SEALANT PRIOR TO INSTALLING STRETCH COAT.
- 5. AT ALL CONTROL JOINTS AND CRACKS INDICATED TO RECEIVE SEALANT, THE STRETCH COAT SHALL BE INSTALLED AND KELFLEX TAPE SHALL BE EMBEDDED INTO THE NEWO V II C MEMBRANE.
- 6. CONCRETE SURFACE PRIMER SHALL BE DUALOX EPOXY PRIMER BY TBS PRODUCTS OR APPROVED EQUAL. PRIMER SHALL BE INSTALLED PER MANUFACTURER'S RECOMMENDATIONS.
- 7. INTERMEDIATE WATERPROOFING SHALL BE NEO V II C ELASTOMERIC WATERPROOFING MEMBRANE BY TBS PRODUCTS OR APPROVED EQUAL. WATERPROOFING MEMBRANE SHALL BE INSTALLED TO A 20 MIL DRY FILM THICKNESS (DFT).
- 8. WEAR COATS SHALL BE KELMAR T.E. 100% EPOXY WEAR COURSE BY TBS PRODUCTS WITH SILICON CARBIDE AGGREGATE BROADCAST TO REFUSAL. SILICON CARBIDE AGGREGATE SHALL BE NO. 20 OR NO. 24. CONTRACTOR SHALL PROVIDE IN-PLACE MOCK-UPS UTILIZING EACH AGGREGATE SIZE FOR OWNER, ENGINEER AND MANUFACTURER'S REPRESENTATIVE REVIEW. WEAR COAT SHALL BE INSTALLED IN MULTIPLE LIFTS (THREE LIFTS MINIMUM) TO A TOTAL 69 MIL THICKNESS (W/O AGGREGATE). AGGREGATE SHALL BE BROADCAST TO REFUSAL IN EACH LIFT, ALLOWED TO CURE AND THE EXCESS SHALL BE BRUSHED OFF PRIOR TO INSTALLATION OF NEXT LIFT.
- 9. TOP COAT SHALL BE 1910 COATING AS MANUFACTURED BY TBS PRODUCTS.
- 10. SEALANT FOR USE UNDER AND IN CONTACT WITH WATERPROOFING SHALL BE A SOLVENT-FREE, MOISTURE-TOLERANT, FLEXIBLE EPOXY CONTROL JOINT SEALER AND ADHESIVE, EITHER NON-SAGGING OR SELF-LEVELING AS REQUIRED SUCH AS SIKADUR 51 AS MANUFACTURED BY SIKA CORPORATION, INC. OR APPROVED EQUAL.

#### TRAFFIC MARKING PAINT:

- 1. PRIOR TO DEMOLITION, CONTRACTOR SHALL FIELD MEASURE ALL EXISTING PARKING STALLS, NO PARKING AREAS, ARROWS, ETC. AND PROVIDE OWNER AND ENGINEER WITH DIMENSIONED AS-BUILT LAYOUT OF ALL TRAFFIC MARKINGS. THE INTENT OF THE DESIGN IS TO REPLICATE THE EXISTING TRAFFIC MARKINGS.
- 2. TRAFFIC MARKING PAINT SHALL BE A PREMIUM QUALITY WATERBORNE ACRYLIC ALKYD TRAFFIC MARKING PAINT SUCH AS PRO-PARK B97 SERIES AS MANUFACTURED BY SHERWIN WILLIAMS OR APPROVED EQUAL. COLOR TO BE SELECTED BY OWNER.
- 3. STENCILS SHALL BE USED TO PROVIDE STRAIGHT, CONSISTENT TRAFFIC MARKINGS.
- 4. TRAFFIC COATING SHALL BE ALLOWED TO CURE MINIMUM 24 HOURS AFTER TOP COAT HAS BEEN INSTALLED PRIOR TO APPLICATION OF TRAFFIC MARKING PAINT.

#### TEMPORARY SHORING NOTES

- 1. THE CONTRACTOR MUST PROVIDE TEMPORARY STRUCTURAL SHORING SUPPORT OR SHORING TO PERFORM REPAIRS AS NOTED ON THE DRAWINGS. ALL MEANS AND METHODS TO ACCOMPLISH THE REPAIR WORK IS THE SOLE RESPONSIBILITY OF THE CONTRACTOR. SUBMIT PROPOSED MEANS AND METHODS TO THE OWNER AND ENGINEER FOR REVIEW.
- 2. THE CONTRACTOR MUST SUBMIT SHOP DRAWINGS TO THE ENGINEER PRIOR TO THE PERFORMANCE OF ANY WORK SHOWING THE LOCATION, SIZE, DIMENSIONS, CAPACITY, DETAIL, WEIGHT, EQUIPMENT, ETC. OF ALL SUPPORTING MEMBERS AS WELL AS A TIME SCHEDULE AND SEQUENCE OF WORK INDICATING WHEN ALL THE PERTINENT ITEMS OF WORK WILL BE PERFORMED.
- 3. THE CONTRACTOR MUST SUBMIT DESIGN CALCULATIONS, SIGNED-AND-SEALED BY A REGISTERED PROFESSIONAL ENGINEER IN THE COMMONWEALTH OF MASSACHUSETTS, TO THE ENGINEER FOR REVIEW PRIOR TO, OR INCLUSIVE WITH, SHOP DRAWINGS.
- 4. NO CONSTRUCTION WORK WILL COMMENCE UNTIL THE ENGINEER HAS REVIEWED THE SHORING SHOP DRAWINGS AND DESIGN CALCULATIONS.
- 5. CONTRACTOR MUST PROVIDE ADEQUATE LATERAL BRACING. ALL SHORING MUST BE CONTINUOUS THROUGH ALL LEVELS AND/OR SOLIDLY BLOCKED BETWEEN LEVELS. ALL SHORES MUST BE CARRIED DOWN TO FIRM BEARING MATERIAL AND THE LOAD MUST BE ADEQUATELY SPREAD OUT IF SUPPORTED ON THE EXISTING GRADE.
- 6. THE CONTRACTOR SHALL JACK BUILDING COMPONENTS TO A TRUE, PLUMB AND LEVEL PLANE. ANY DEFICIENCIES OR DAMAGE AS A RESULT OF SHORING OR JACKING SHALL BE THE CONTRACTOR'S RESPONSIBILITY AND SHALL BE RESTORED TO THE ORIGINAL CONDITION AT NO ADDITIONAL COST TO THE OWNER.
- 7. CONTRACTOR SHALL PROVIDE ALL OVERHEAD PROTECTION AT BUILDING ENTRANCE WAYS IN ACCORDANCE WITH OSHA, LOCAL, STATE AND FEDERAL GUIDELINES.



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RENOVATION AND REPAIR OF GEORGE A.
AYOTTE AND JOSEPH M. DOWNES PARKING
FACILITIES IN LOWELL, MA

OWNER

CITY OF LOWELL

CITY HALL, 375 MERRIMACK ST., 3RD FLOOR
1 OWNER

CITY HALL, 375 MERRIMACK ST., 3RD FLOOR

NO. DATE DESCRIPTION
PROJECT NO. 837920
CADD FILE
DESIGNED BY

DRAWN BY MSL/JVL

CHECKED BY AEO/ACP

DATE 2/22/2022

DRAWING SCALE NOT TO SCALE


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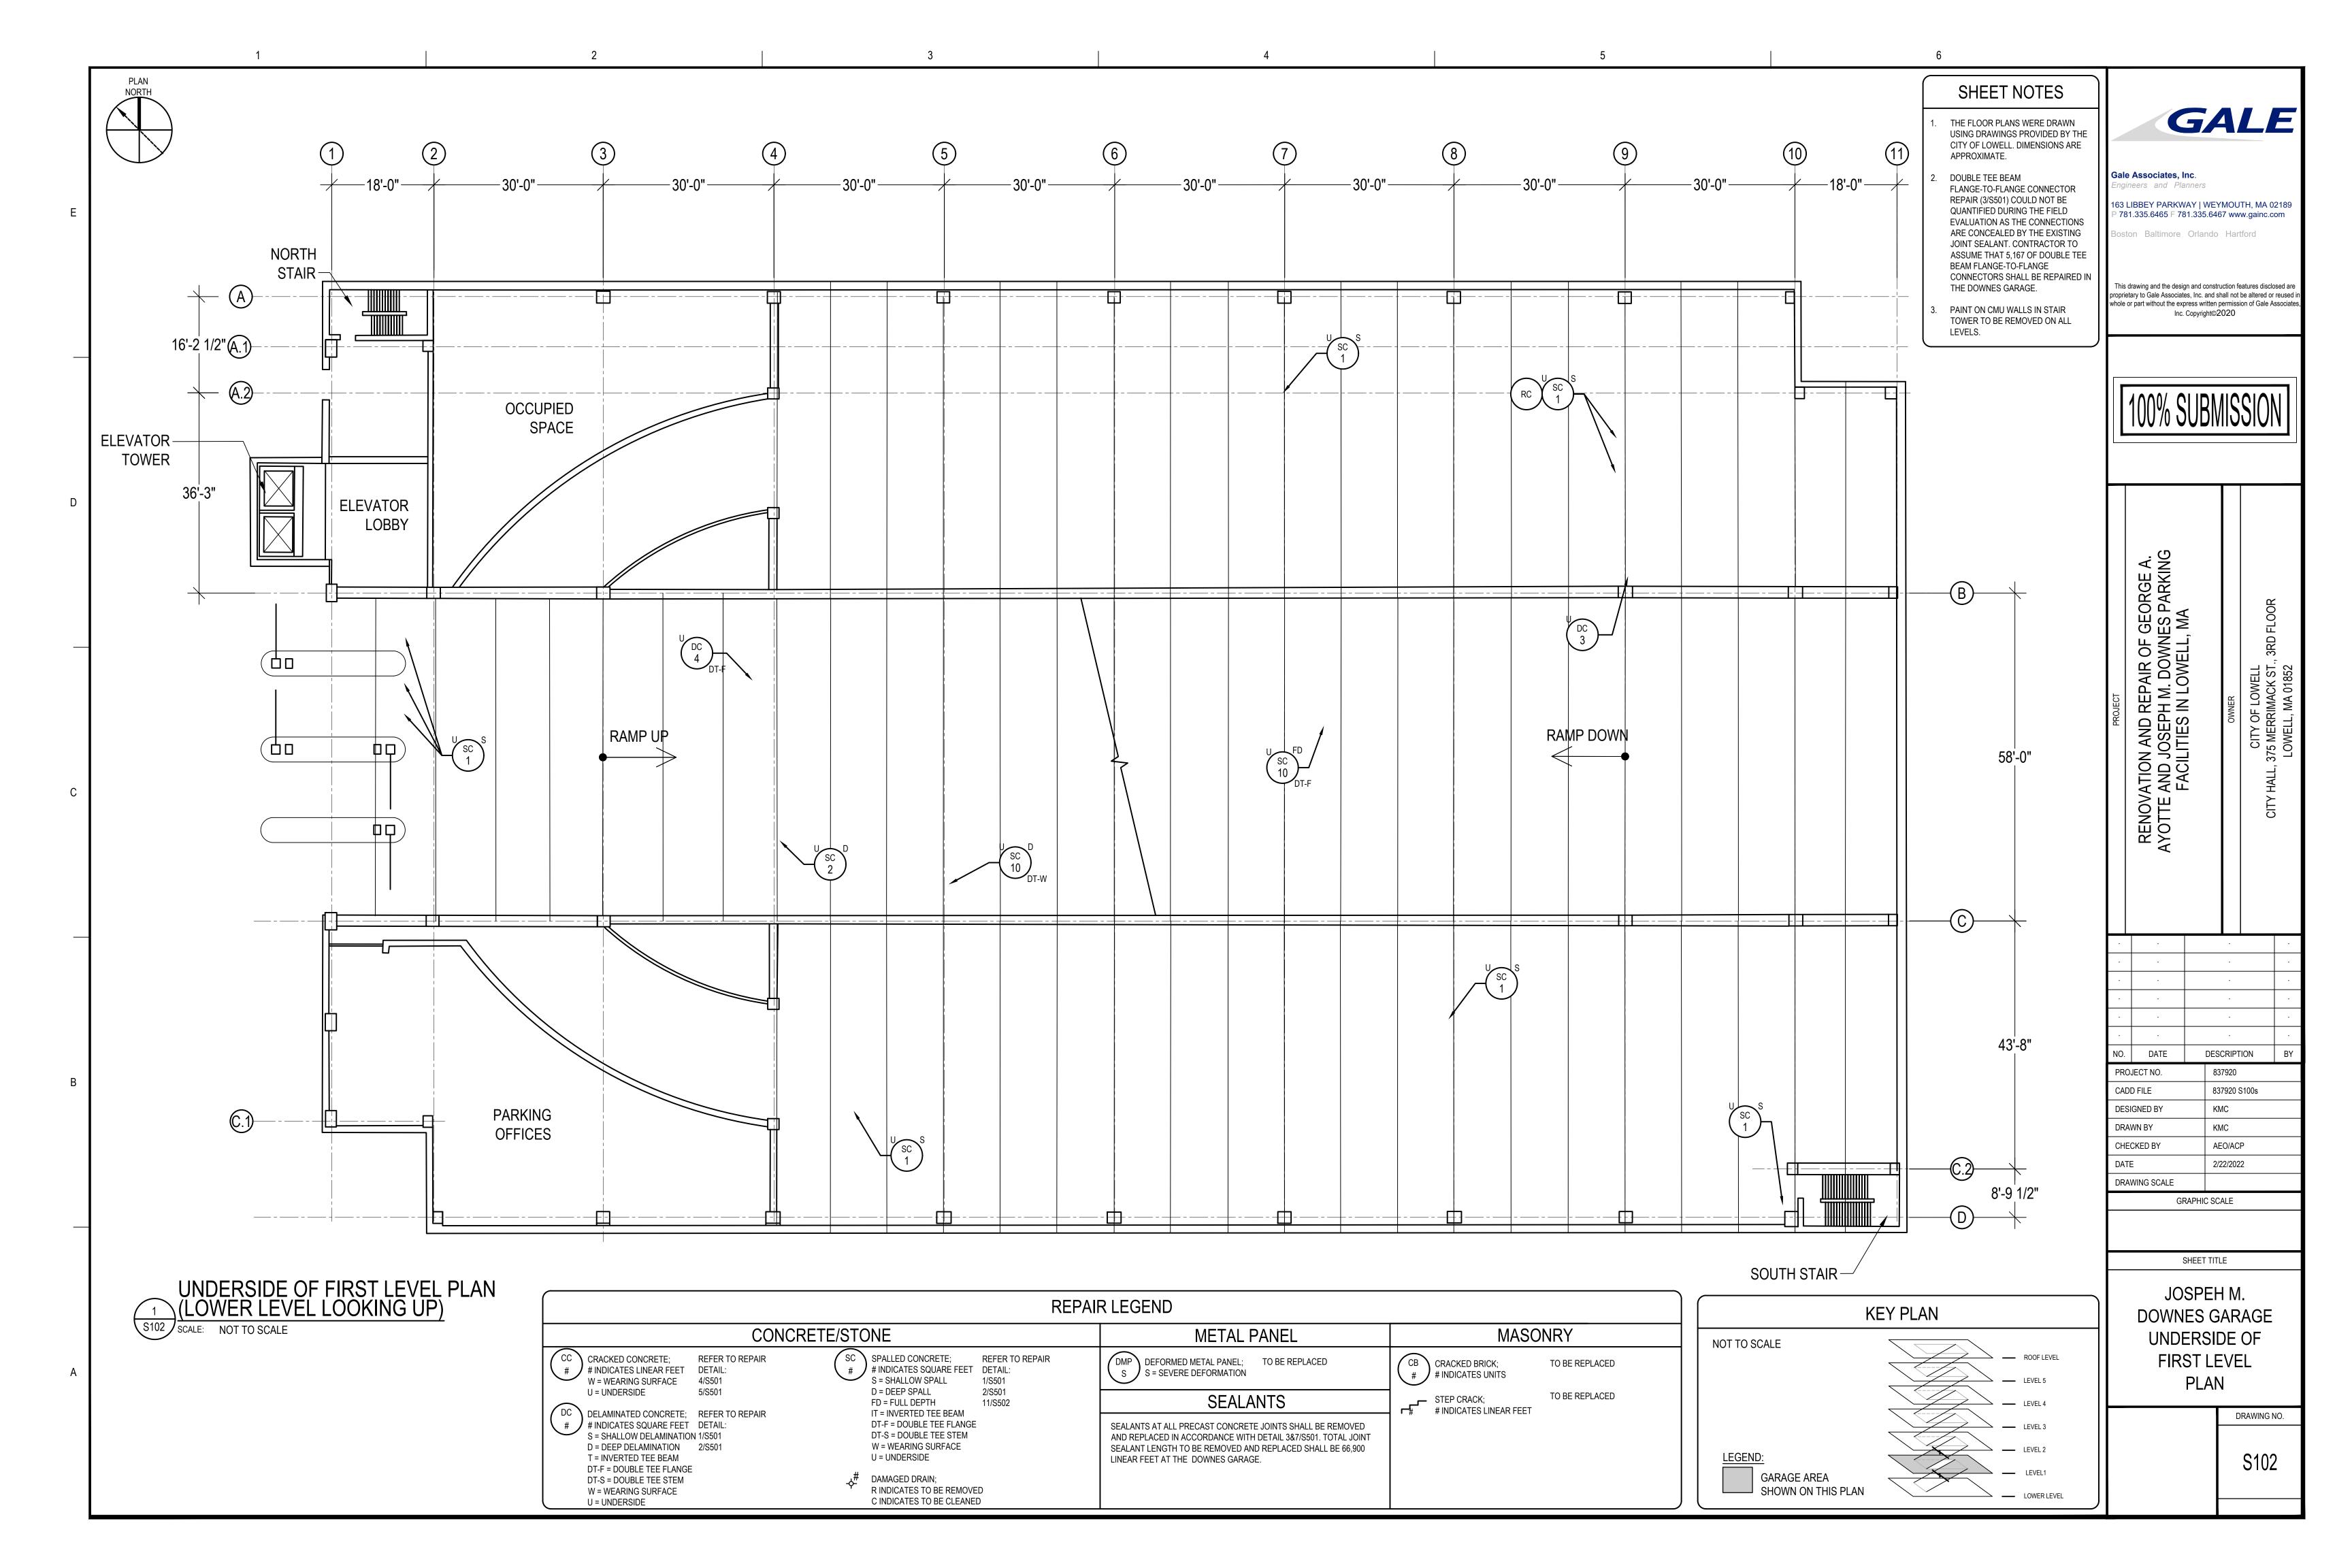
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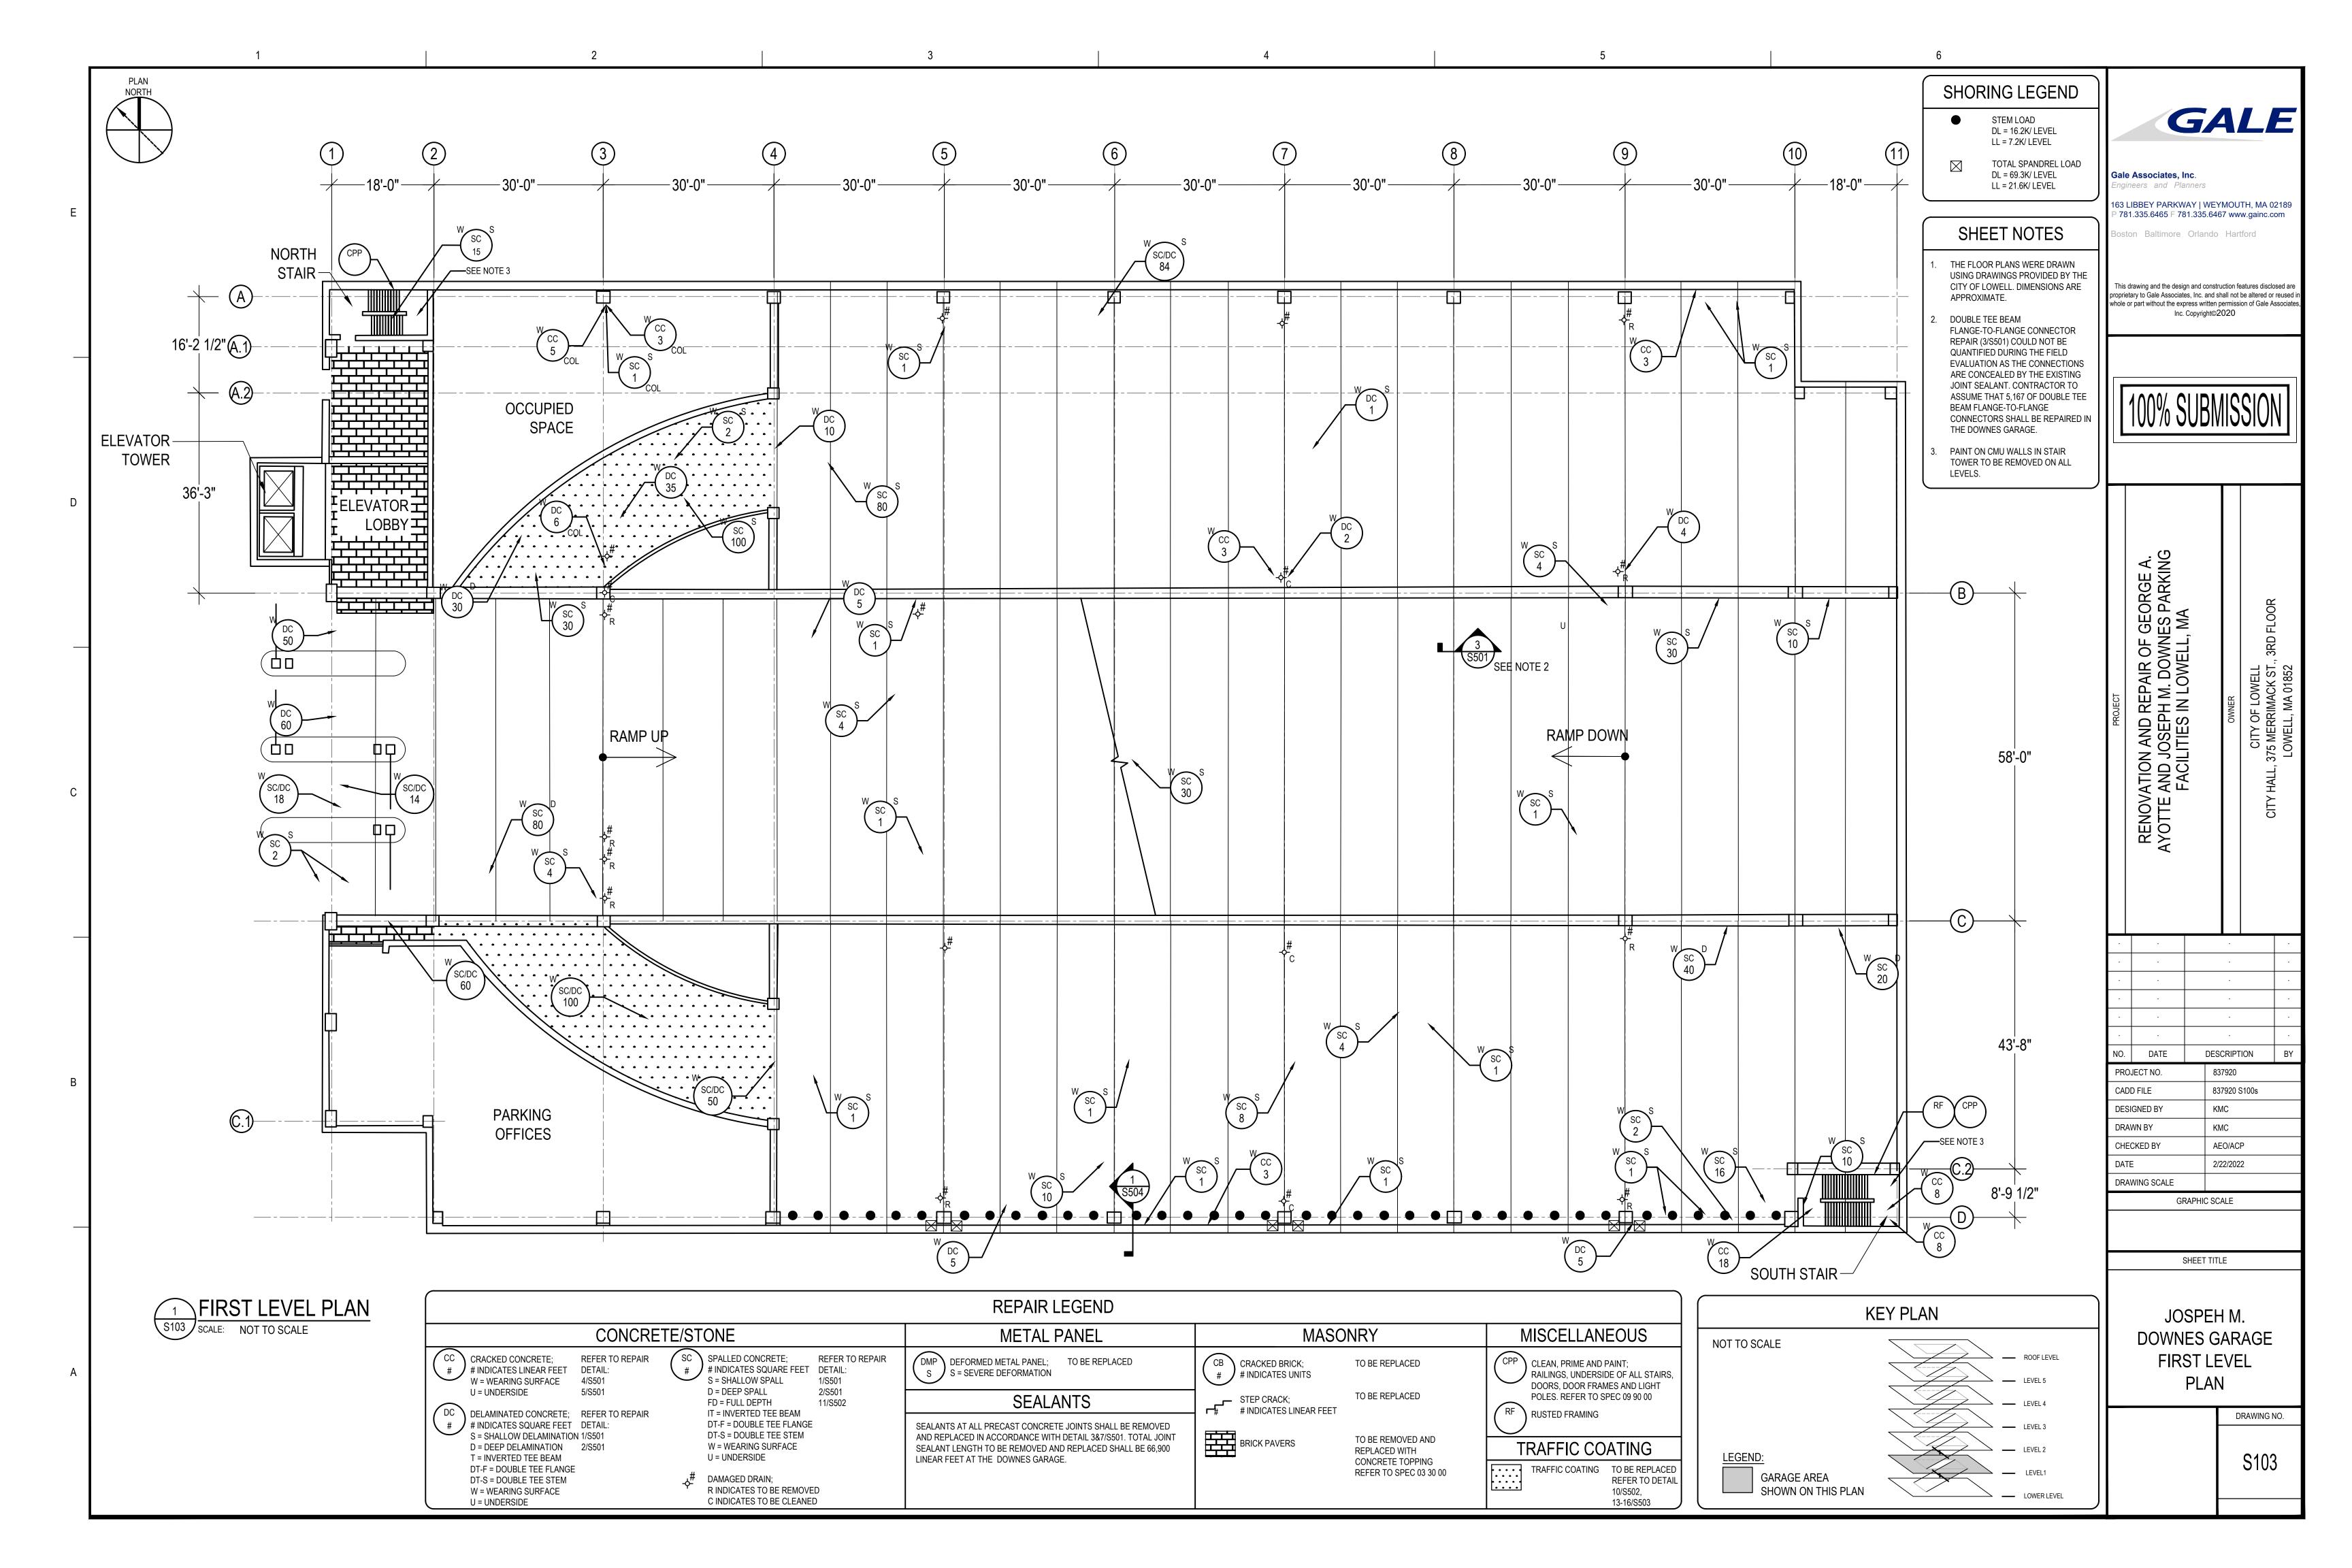
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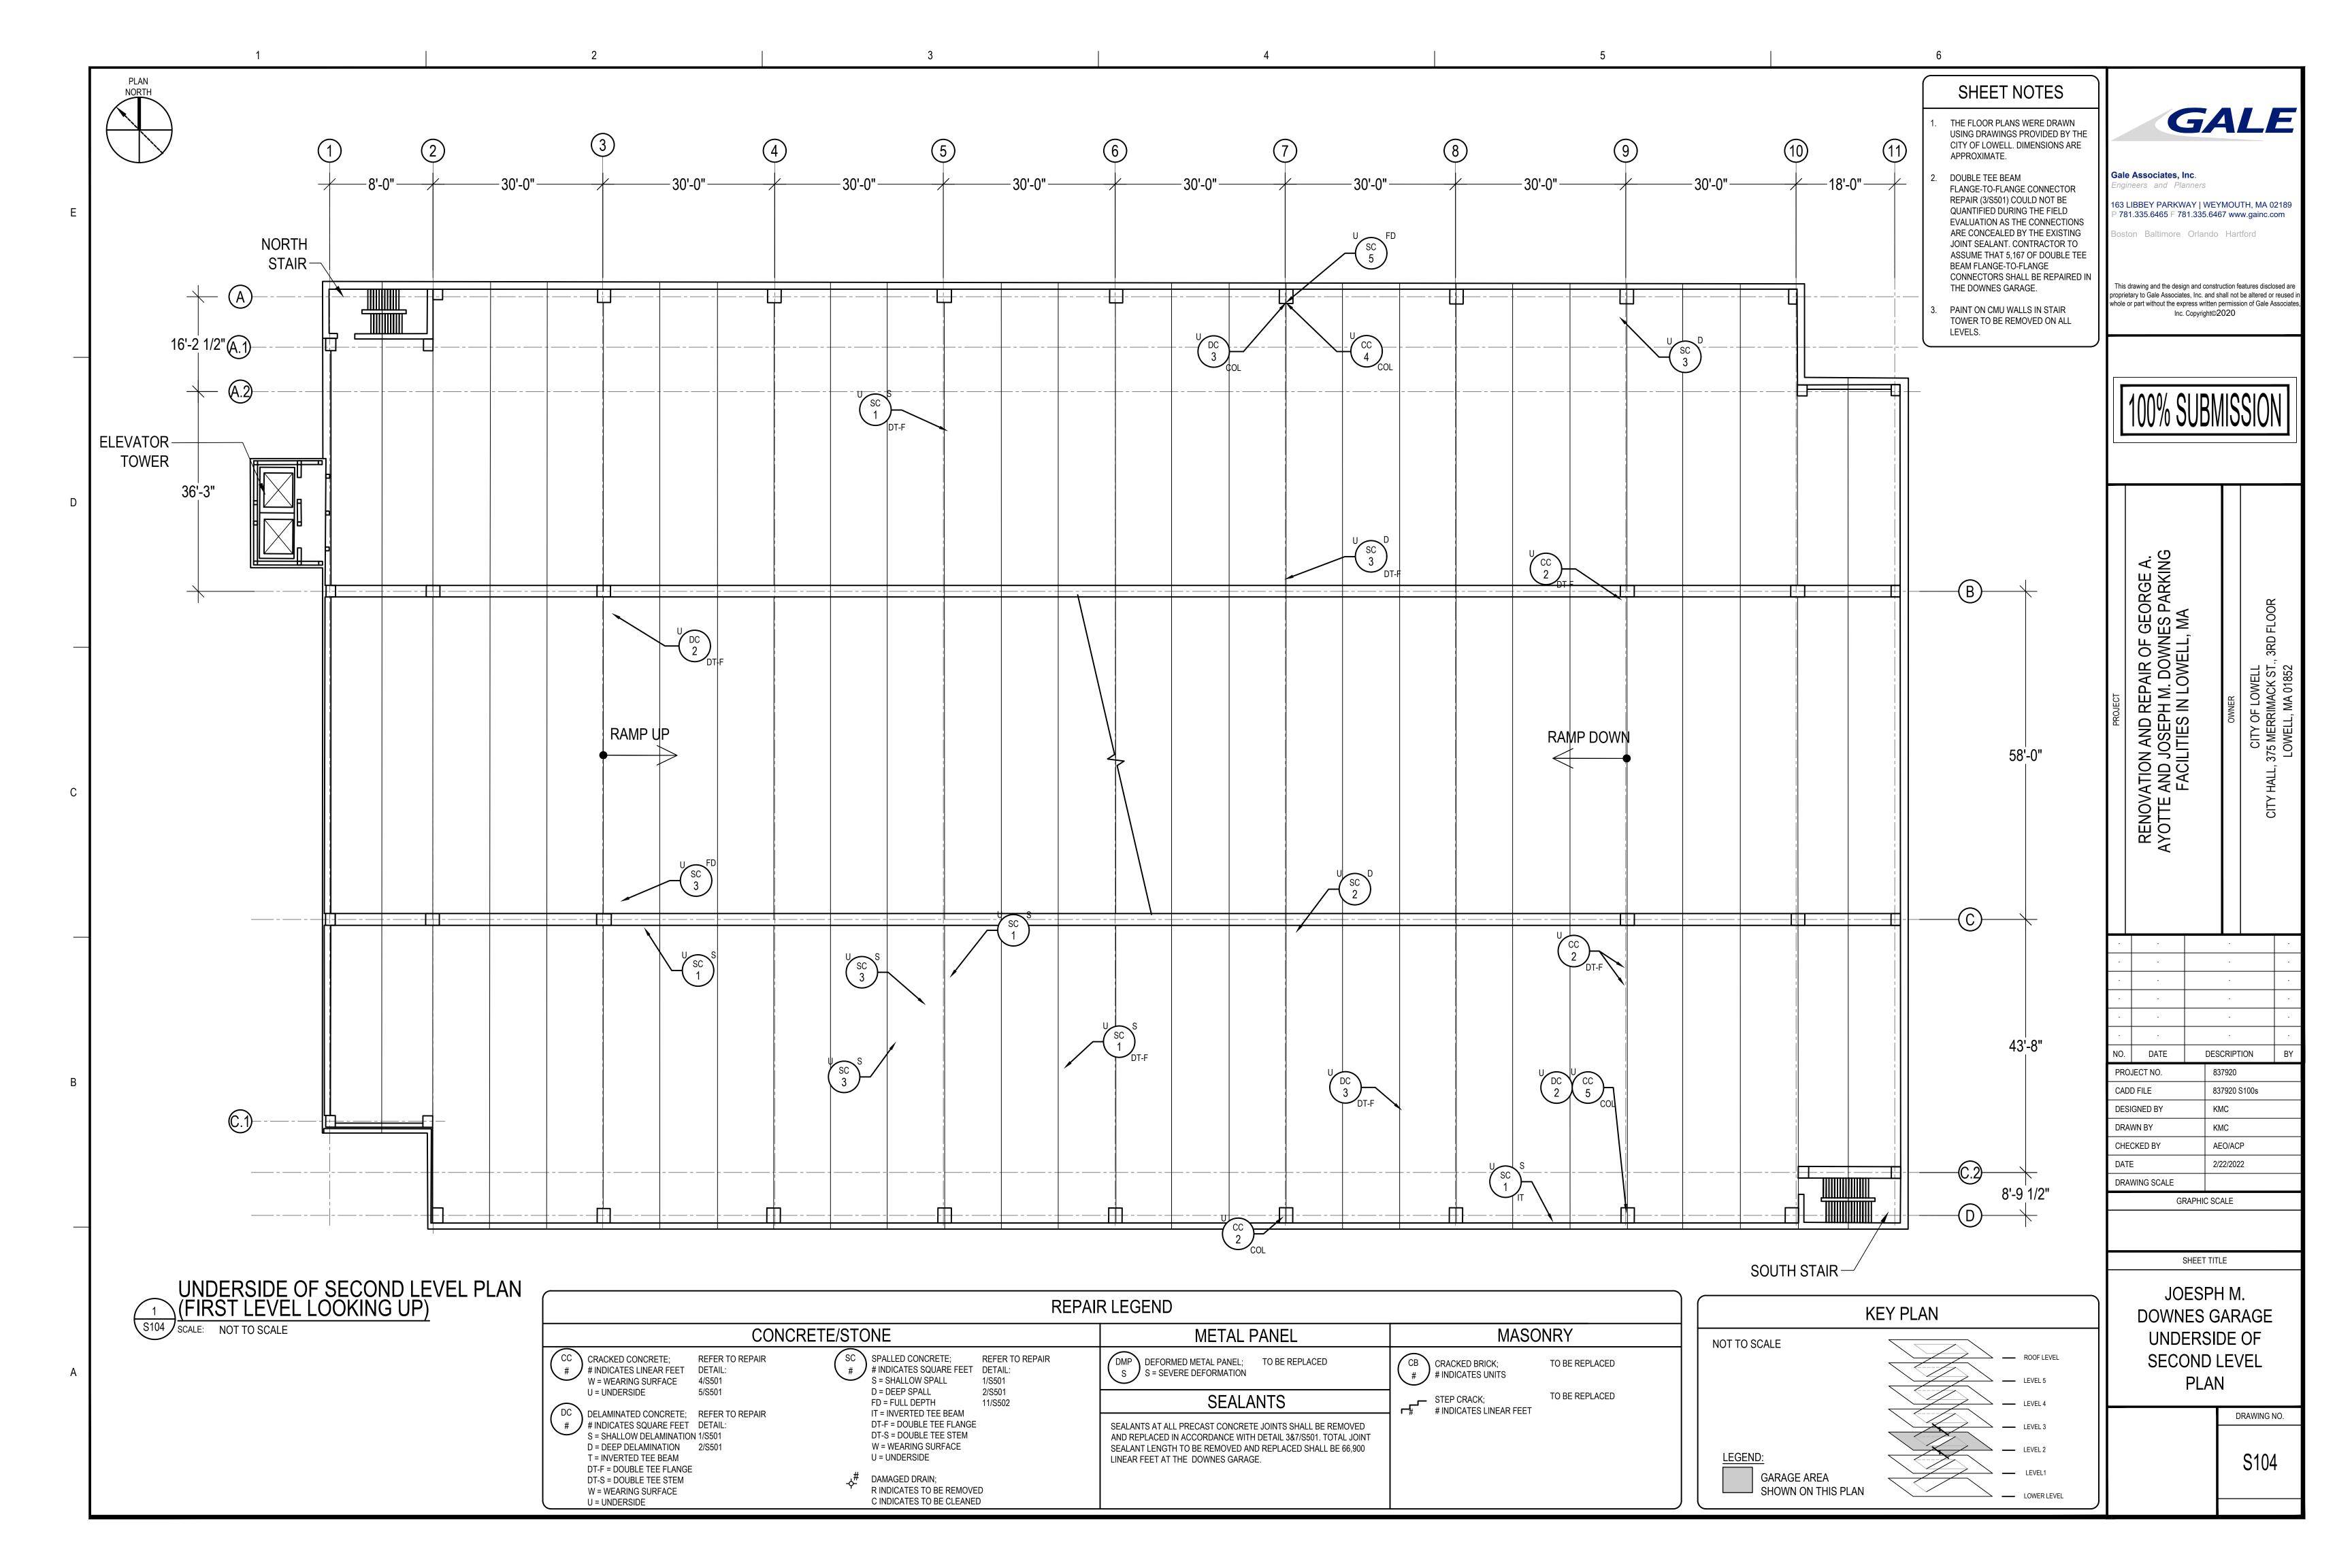
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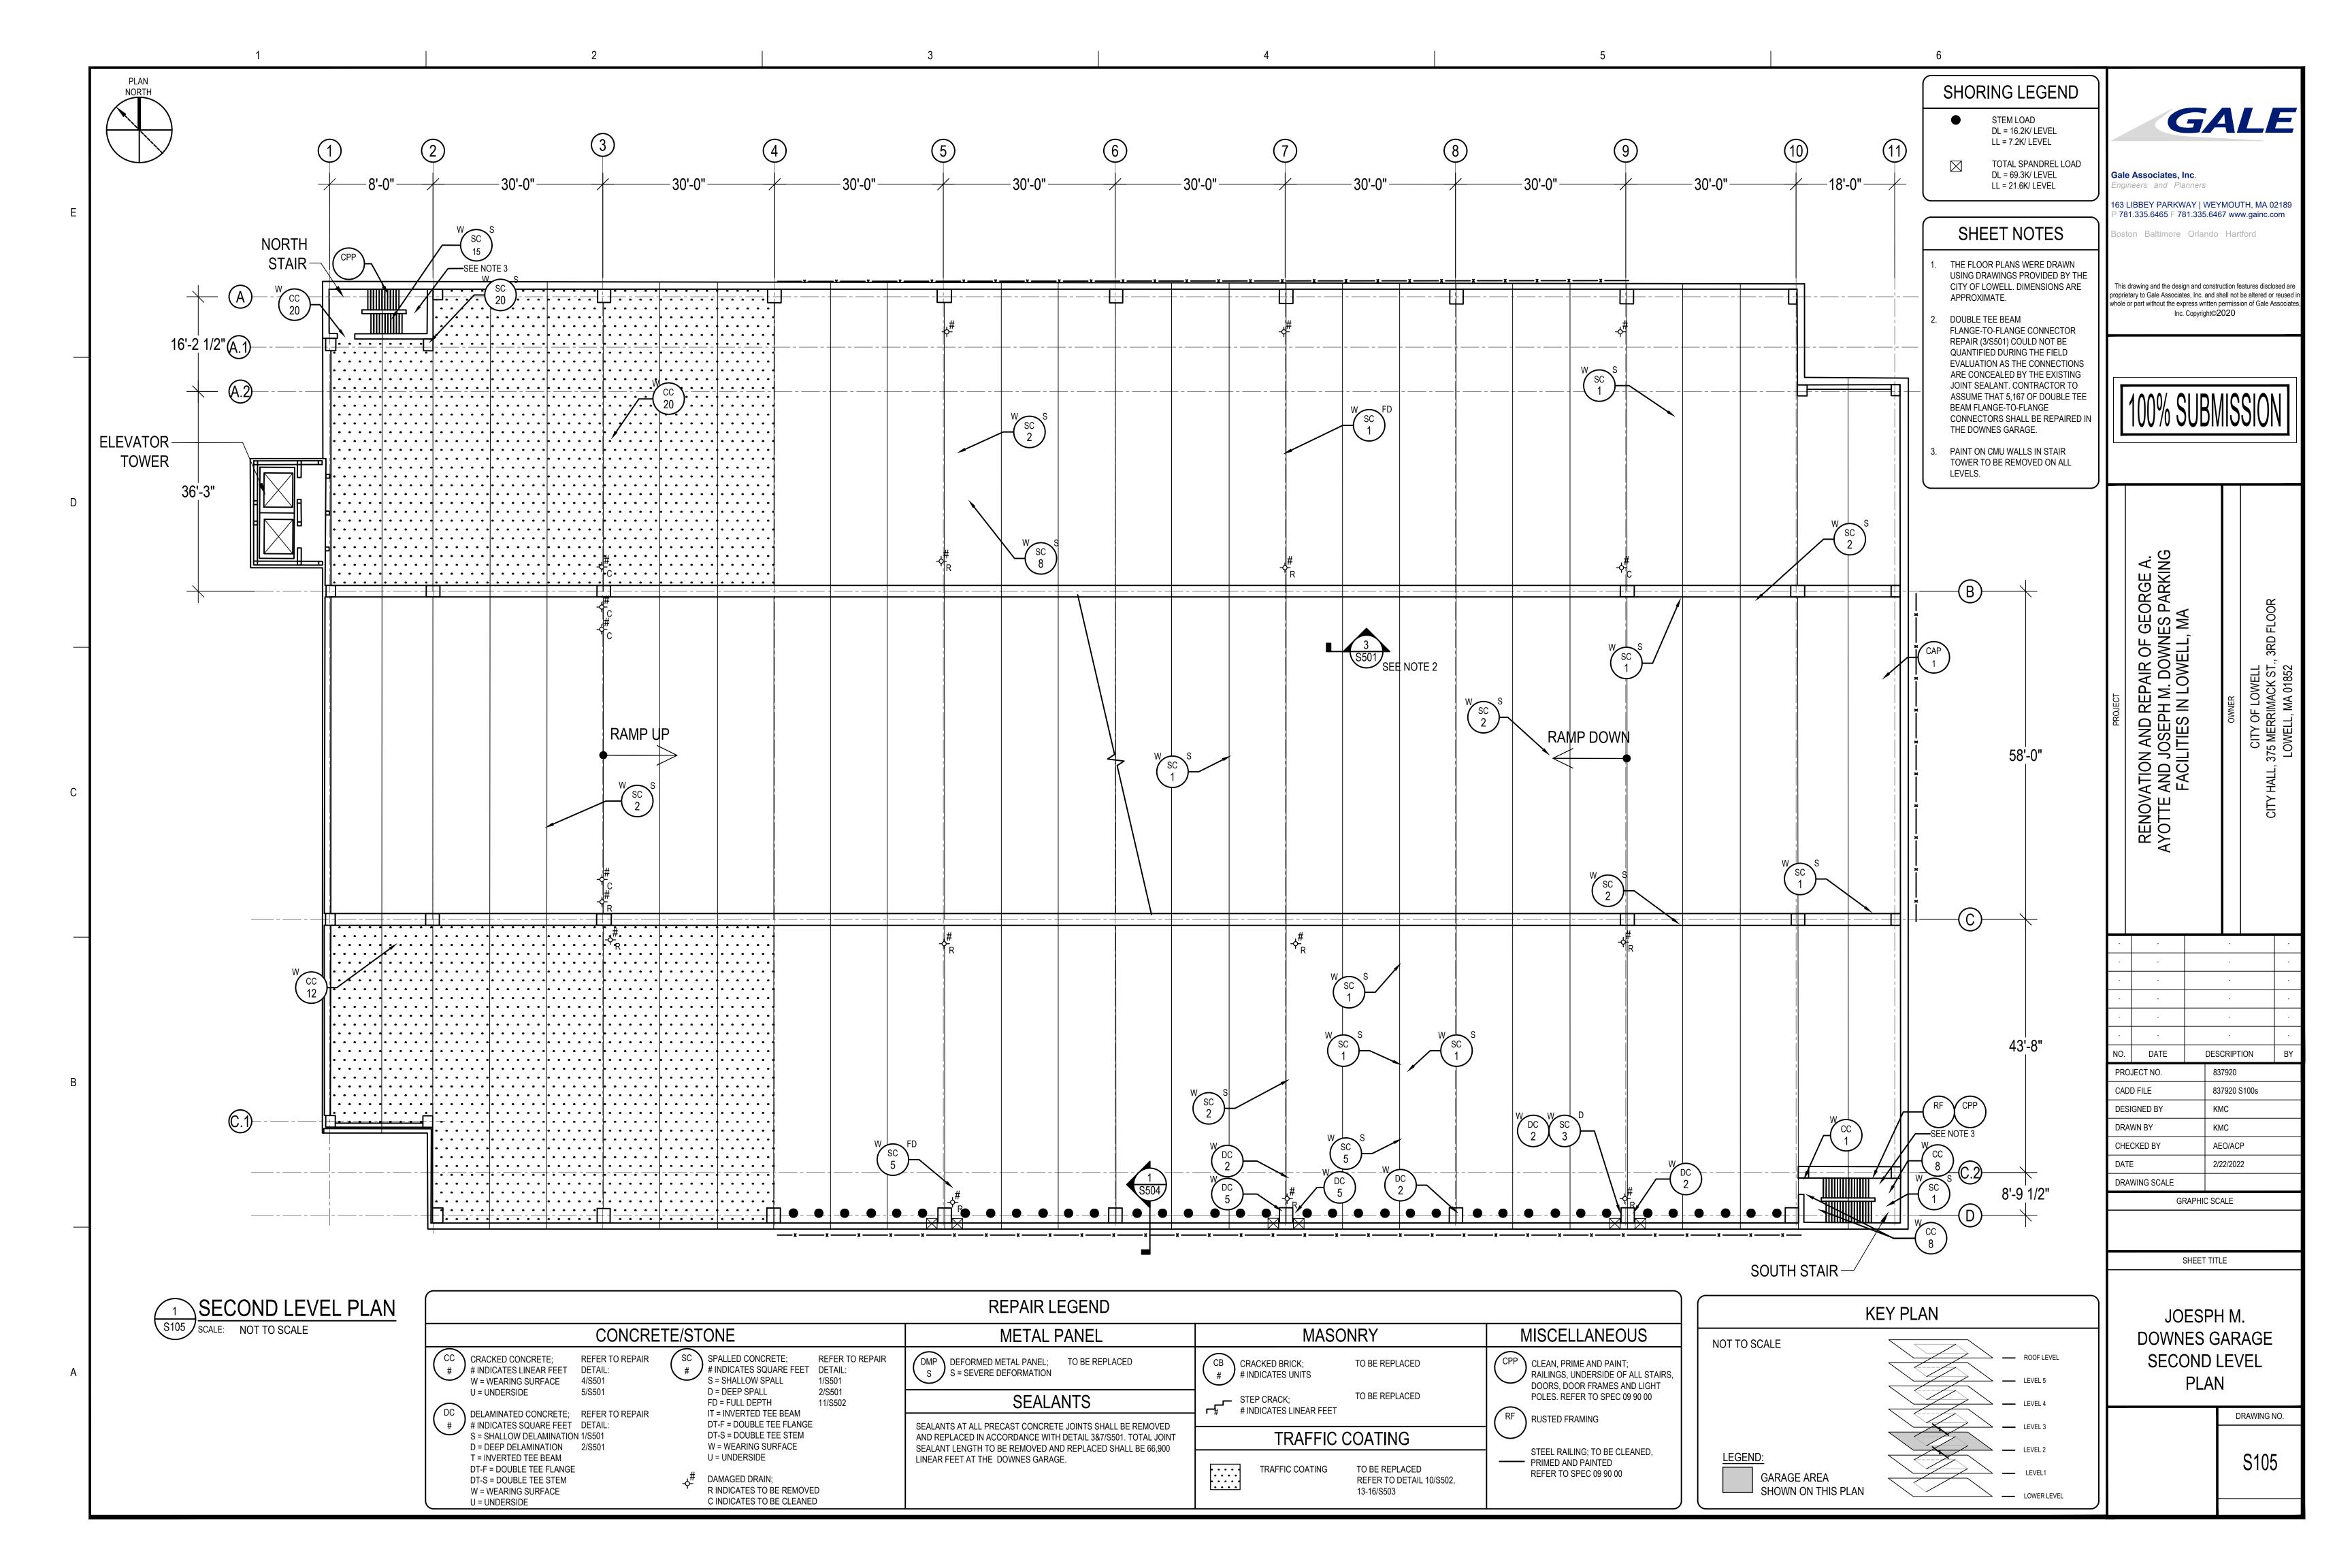
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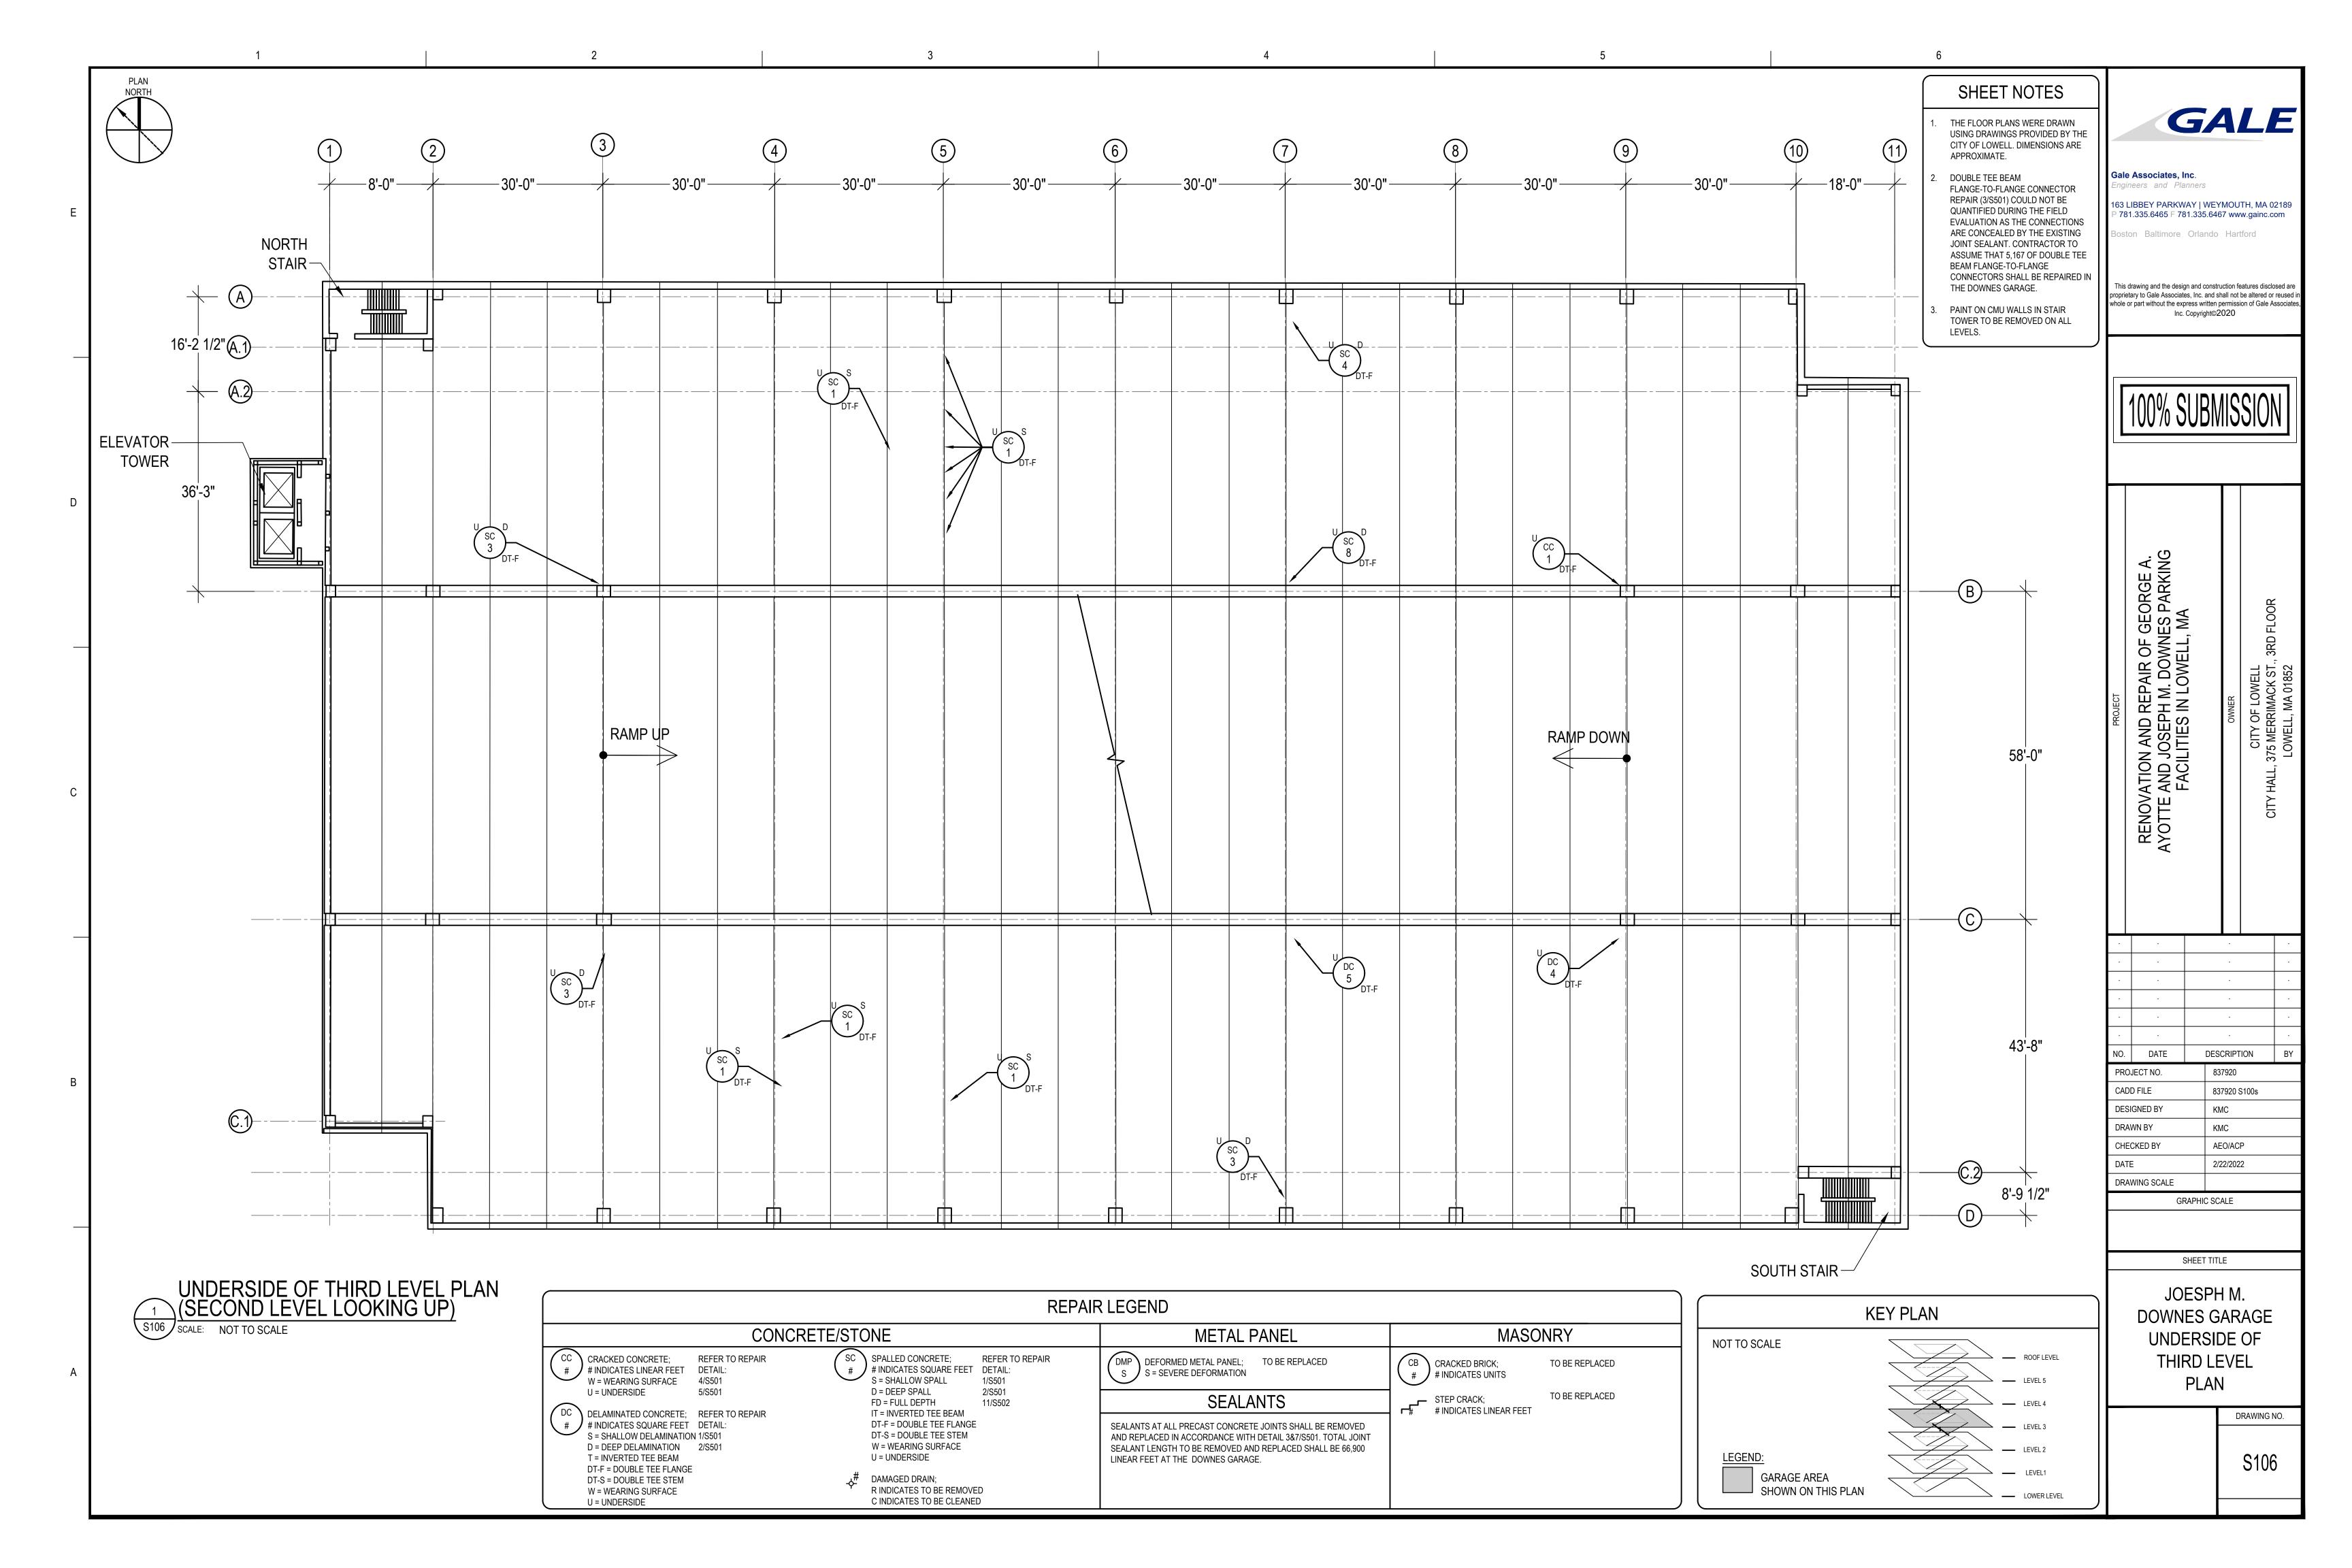














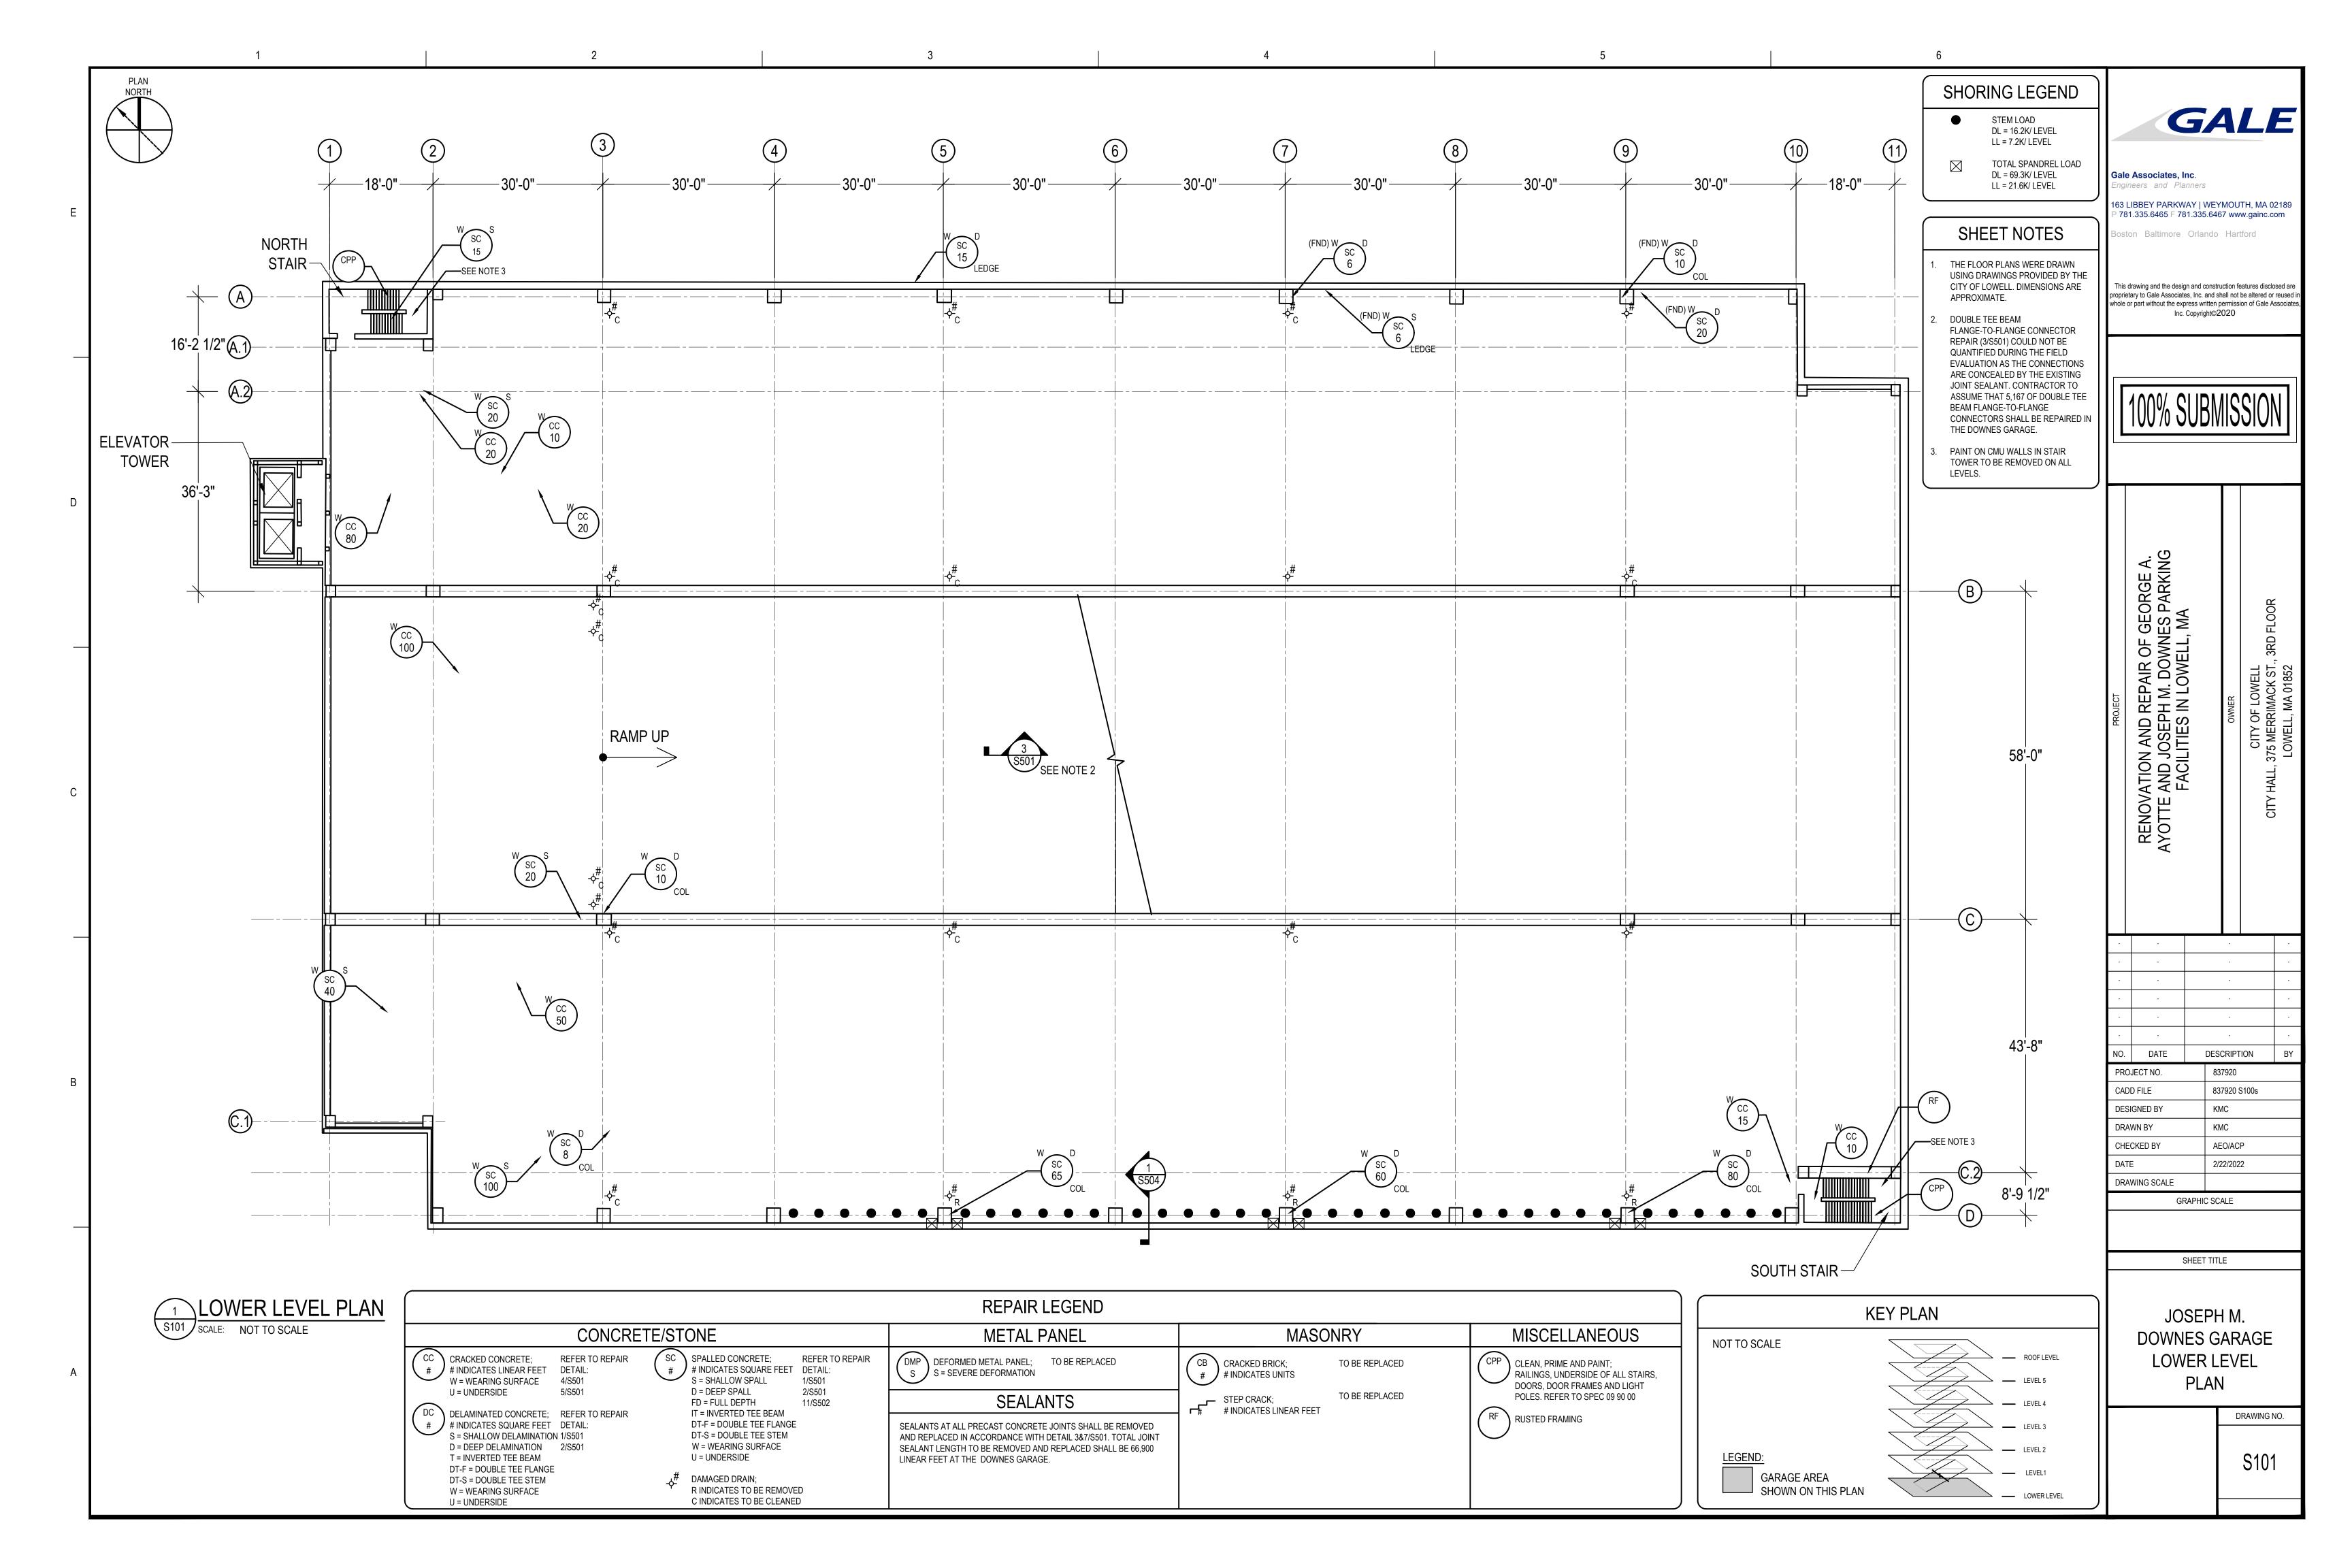


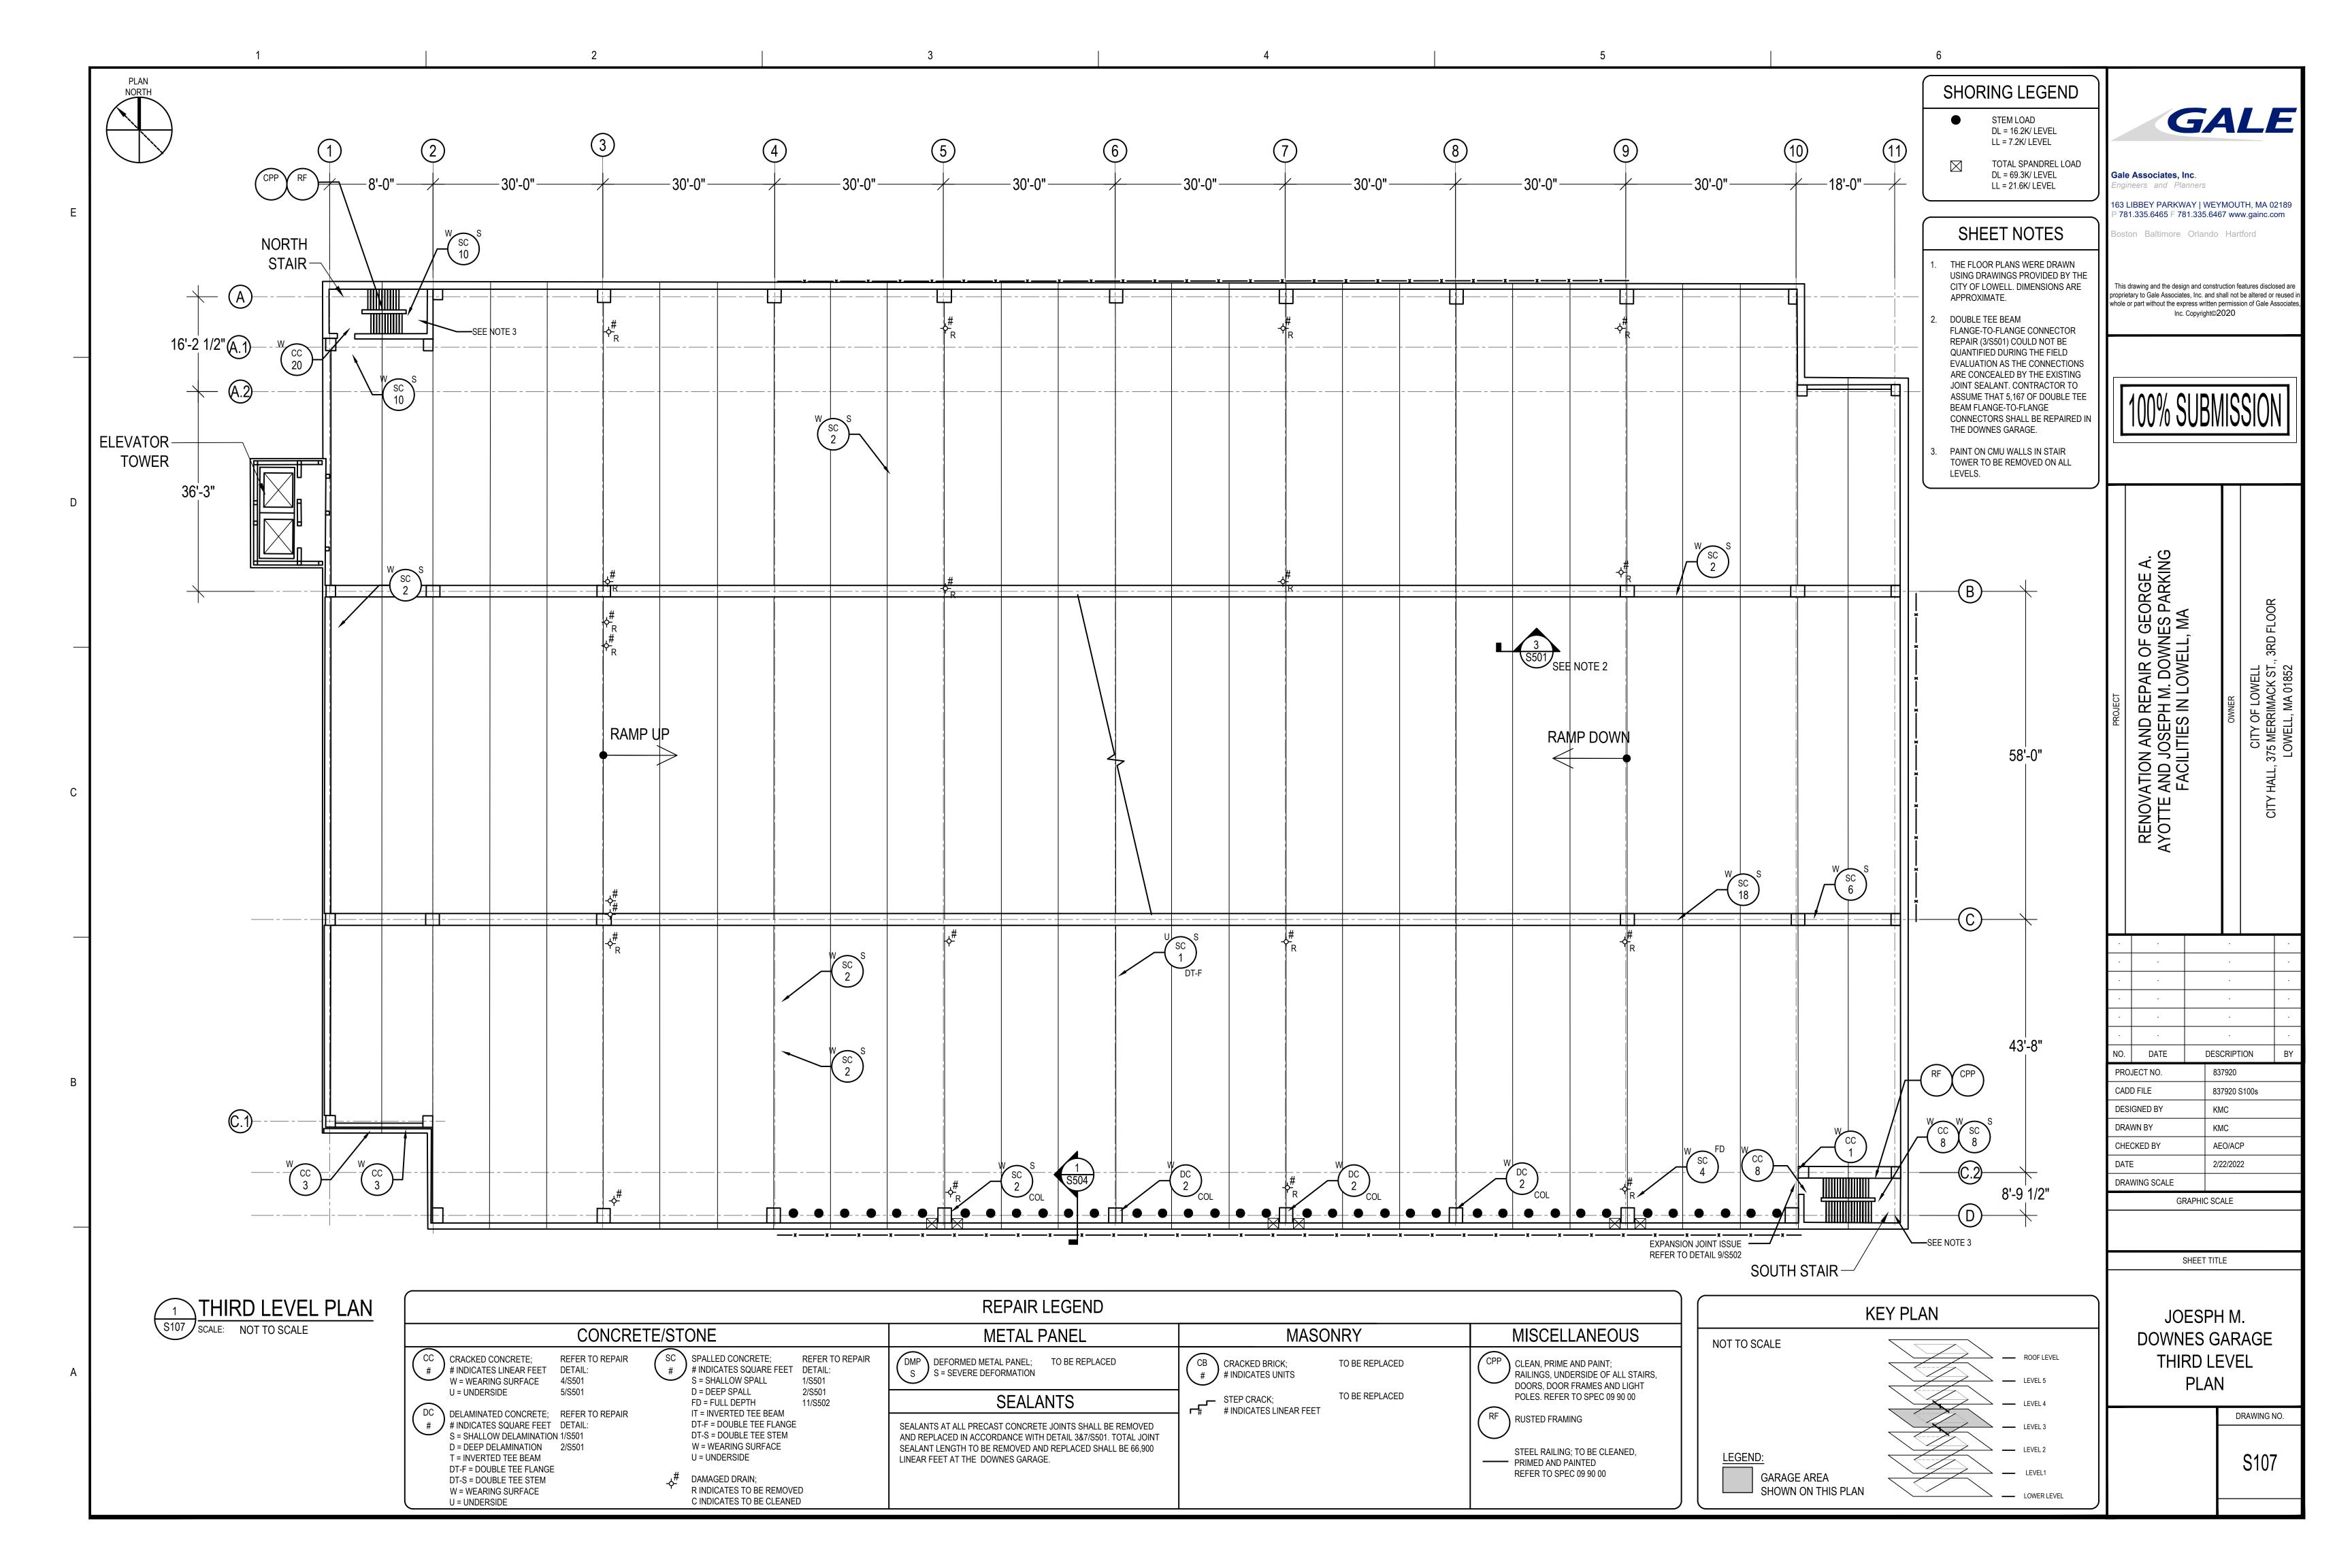


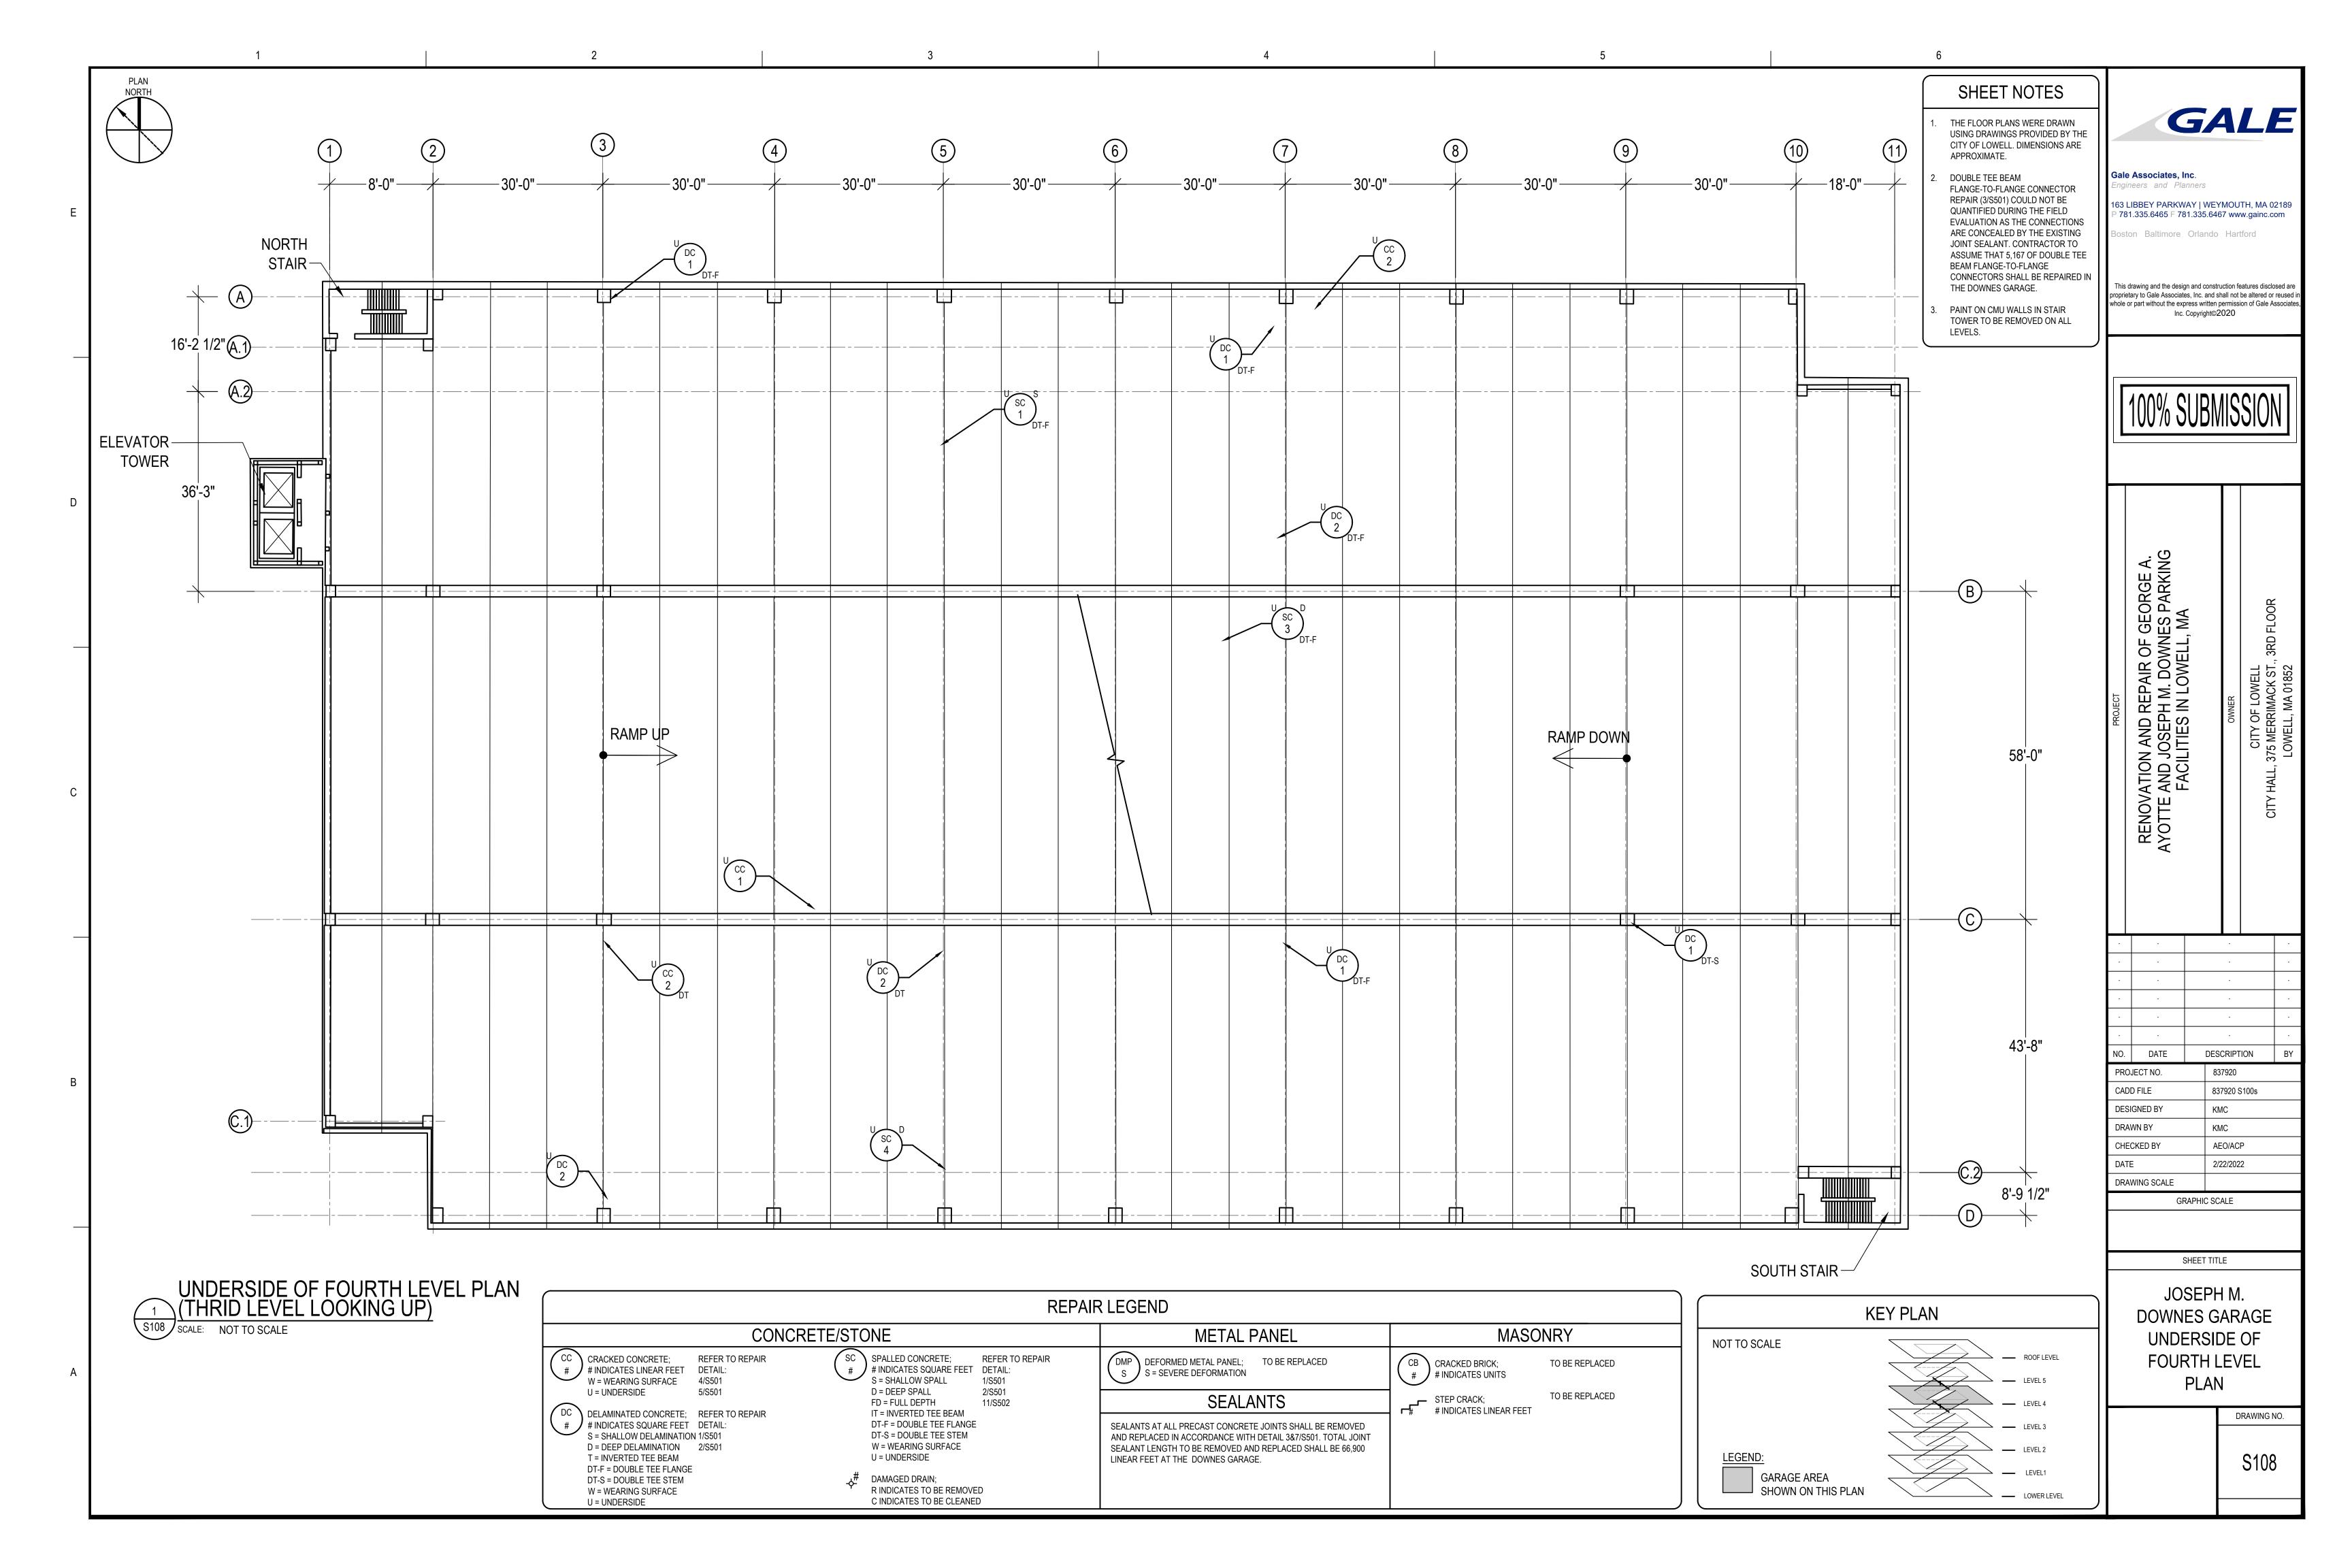


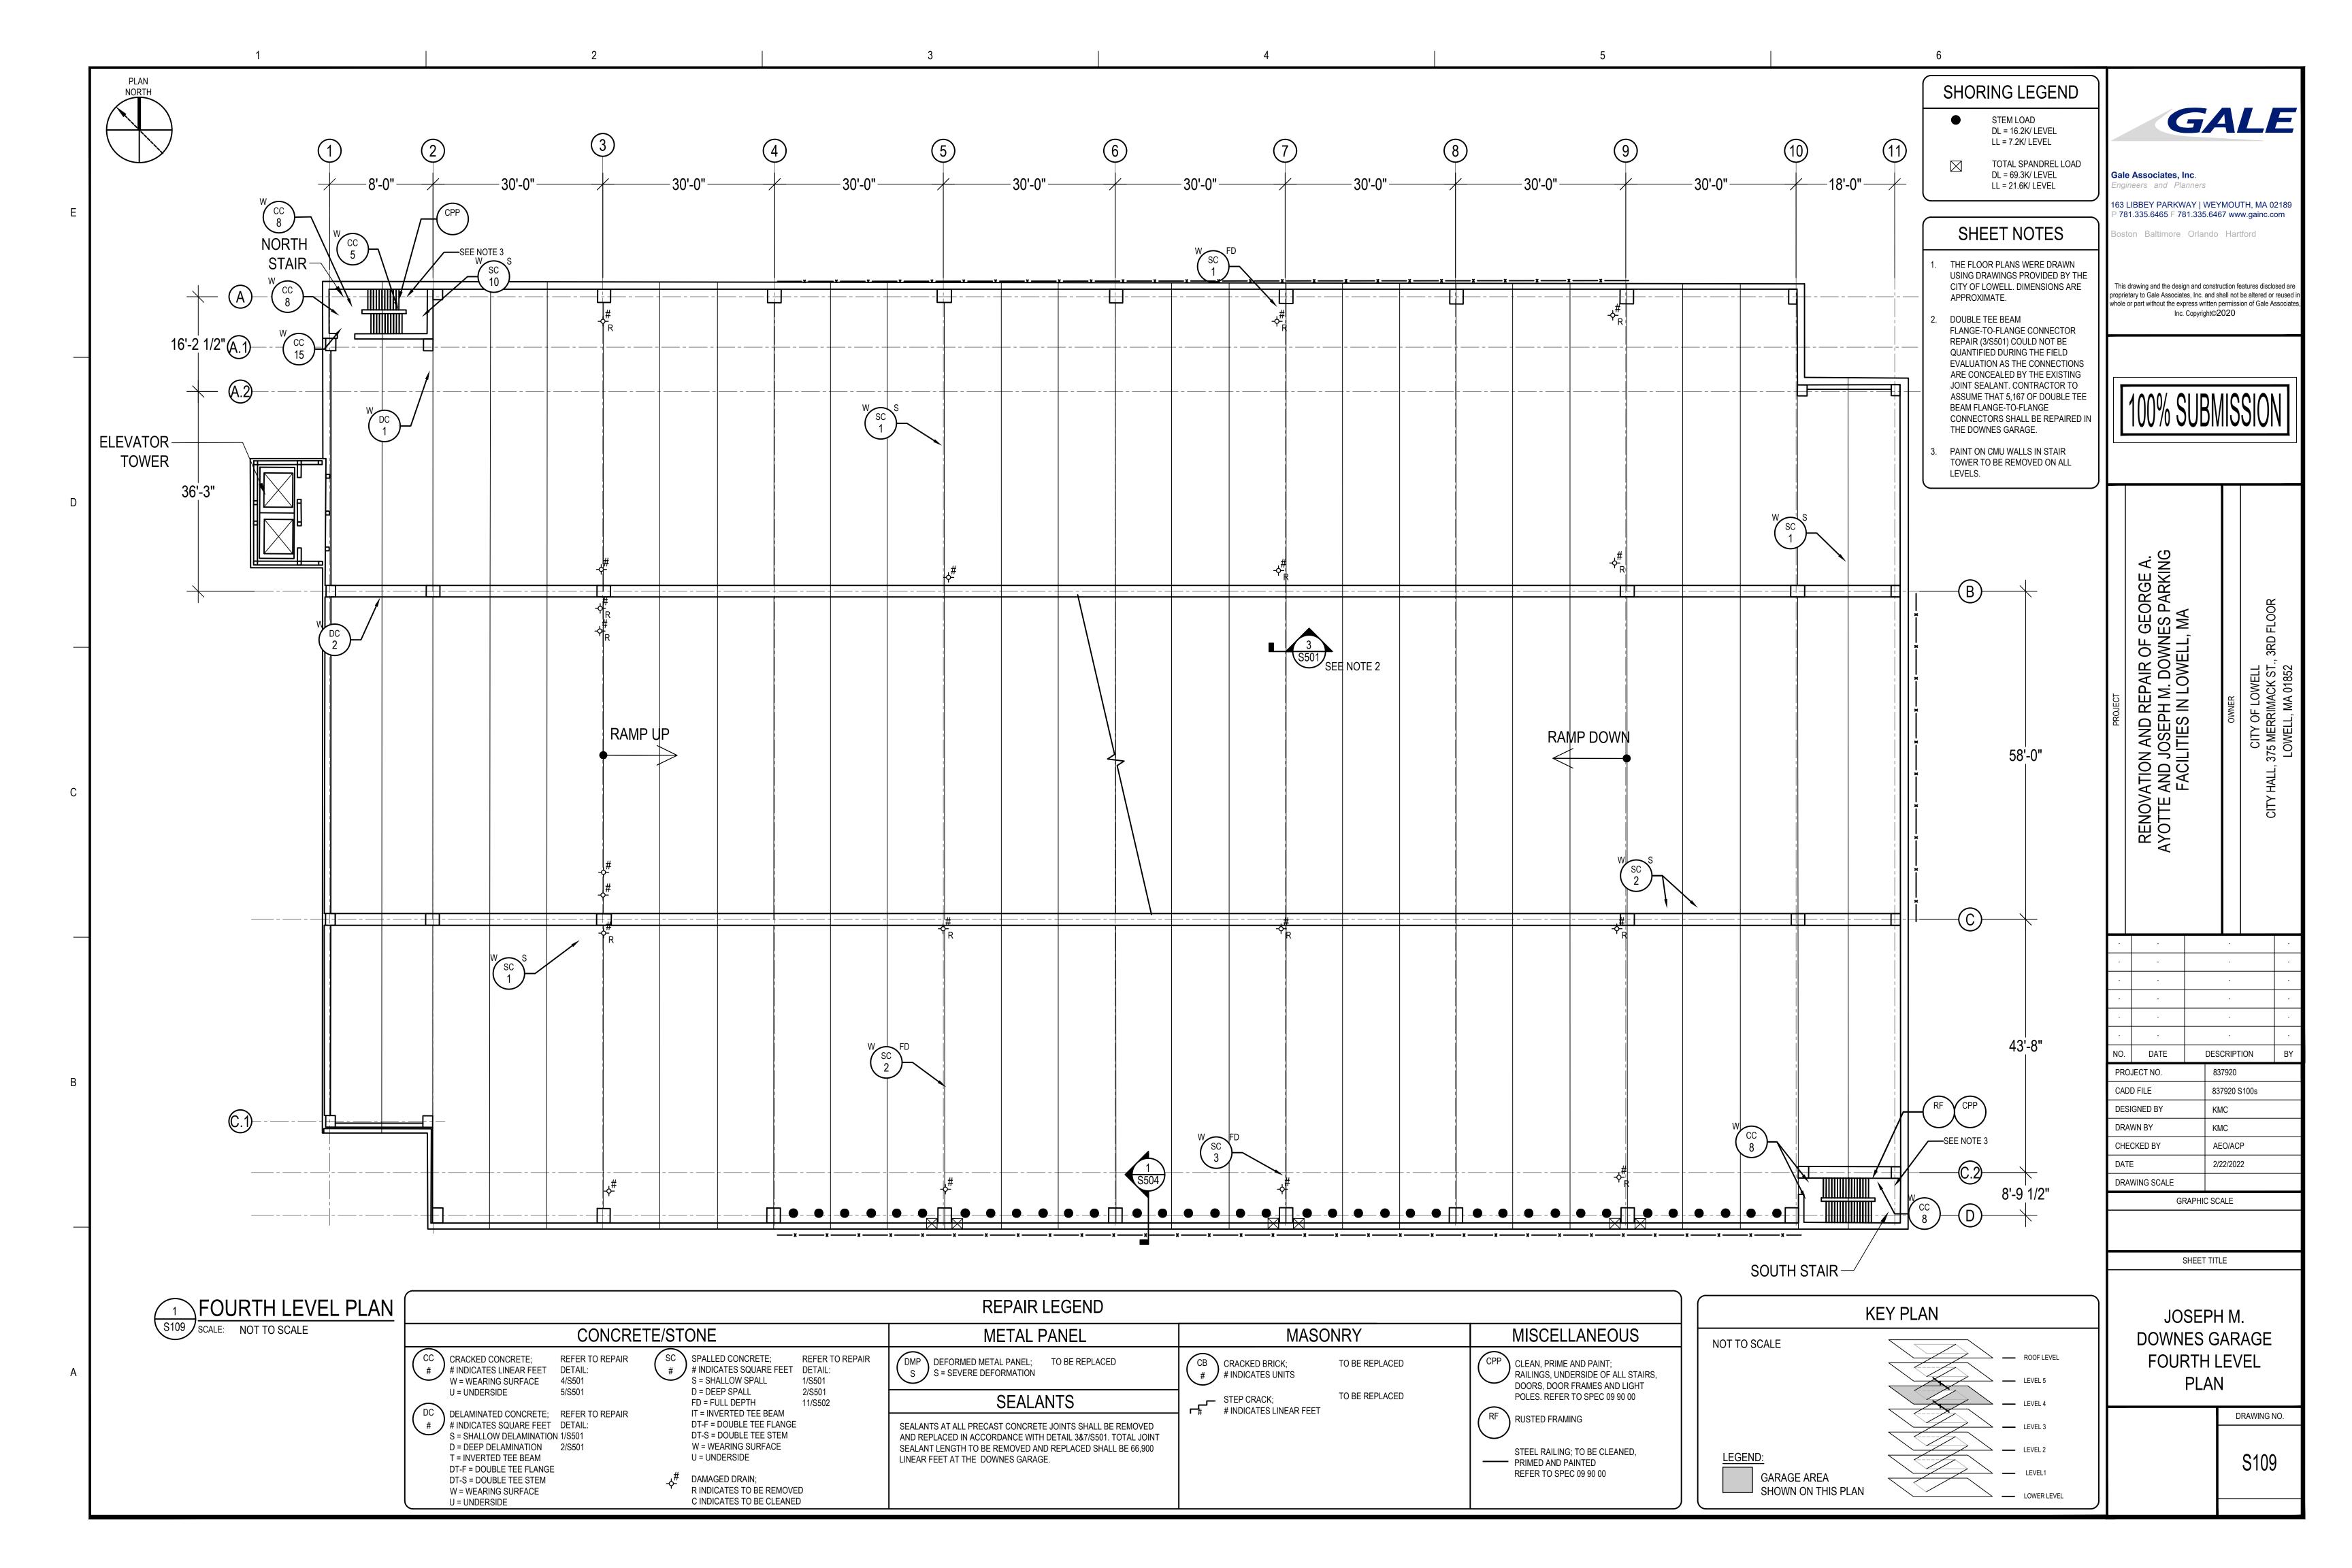


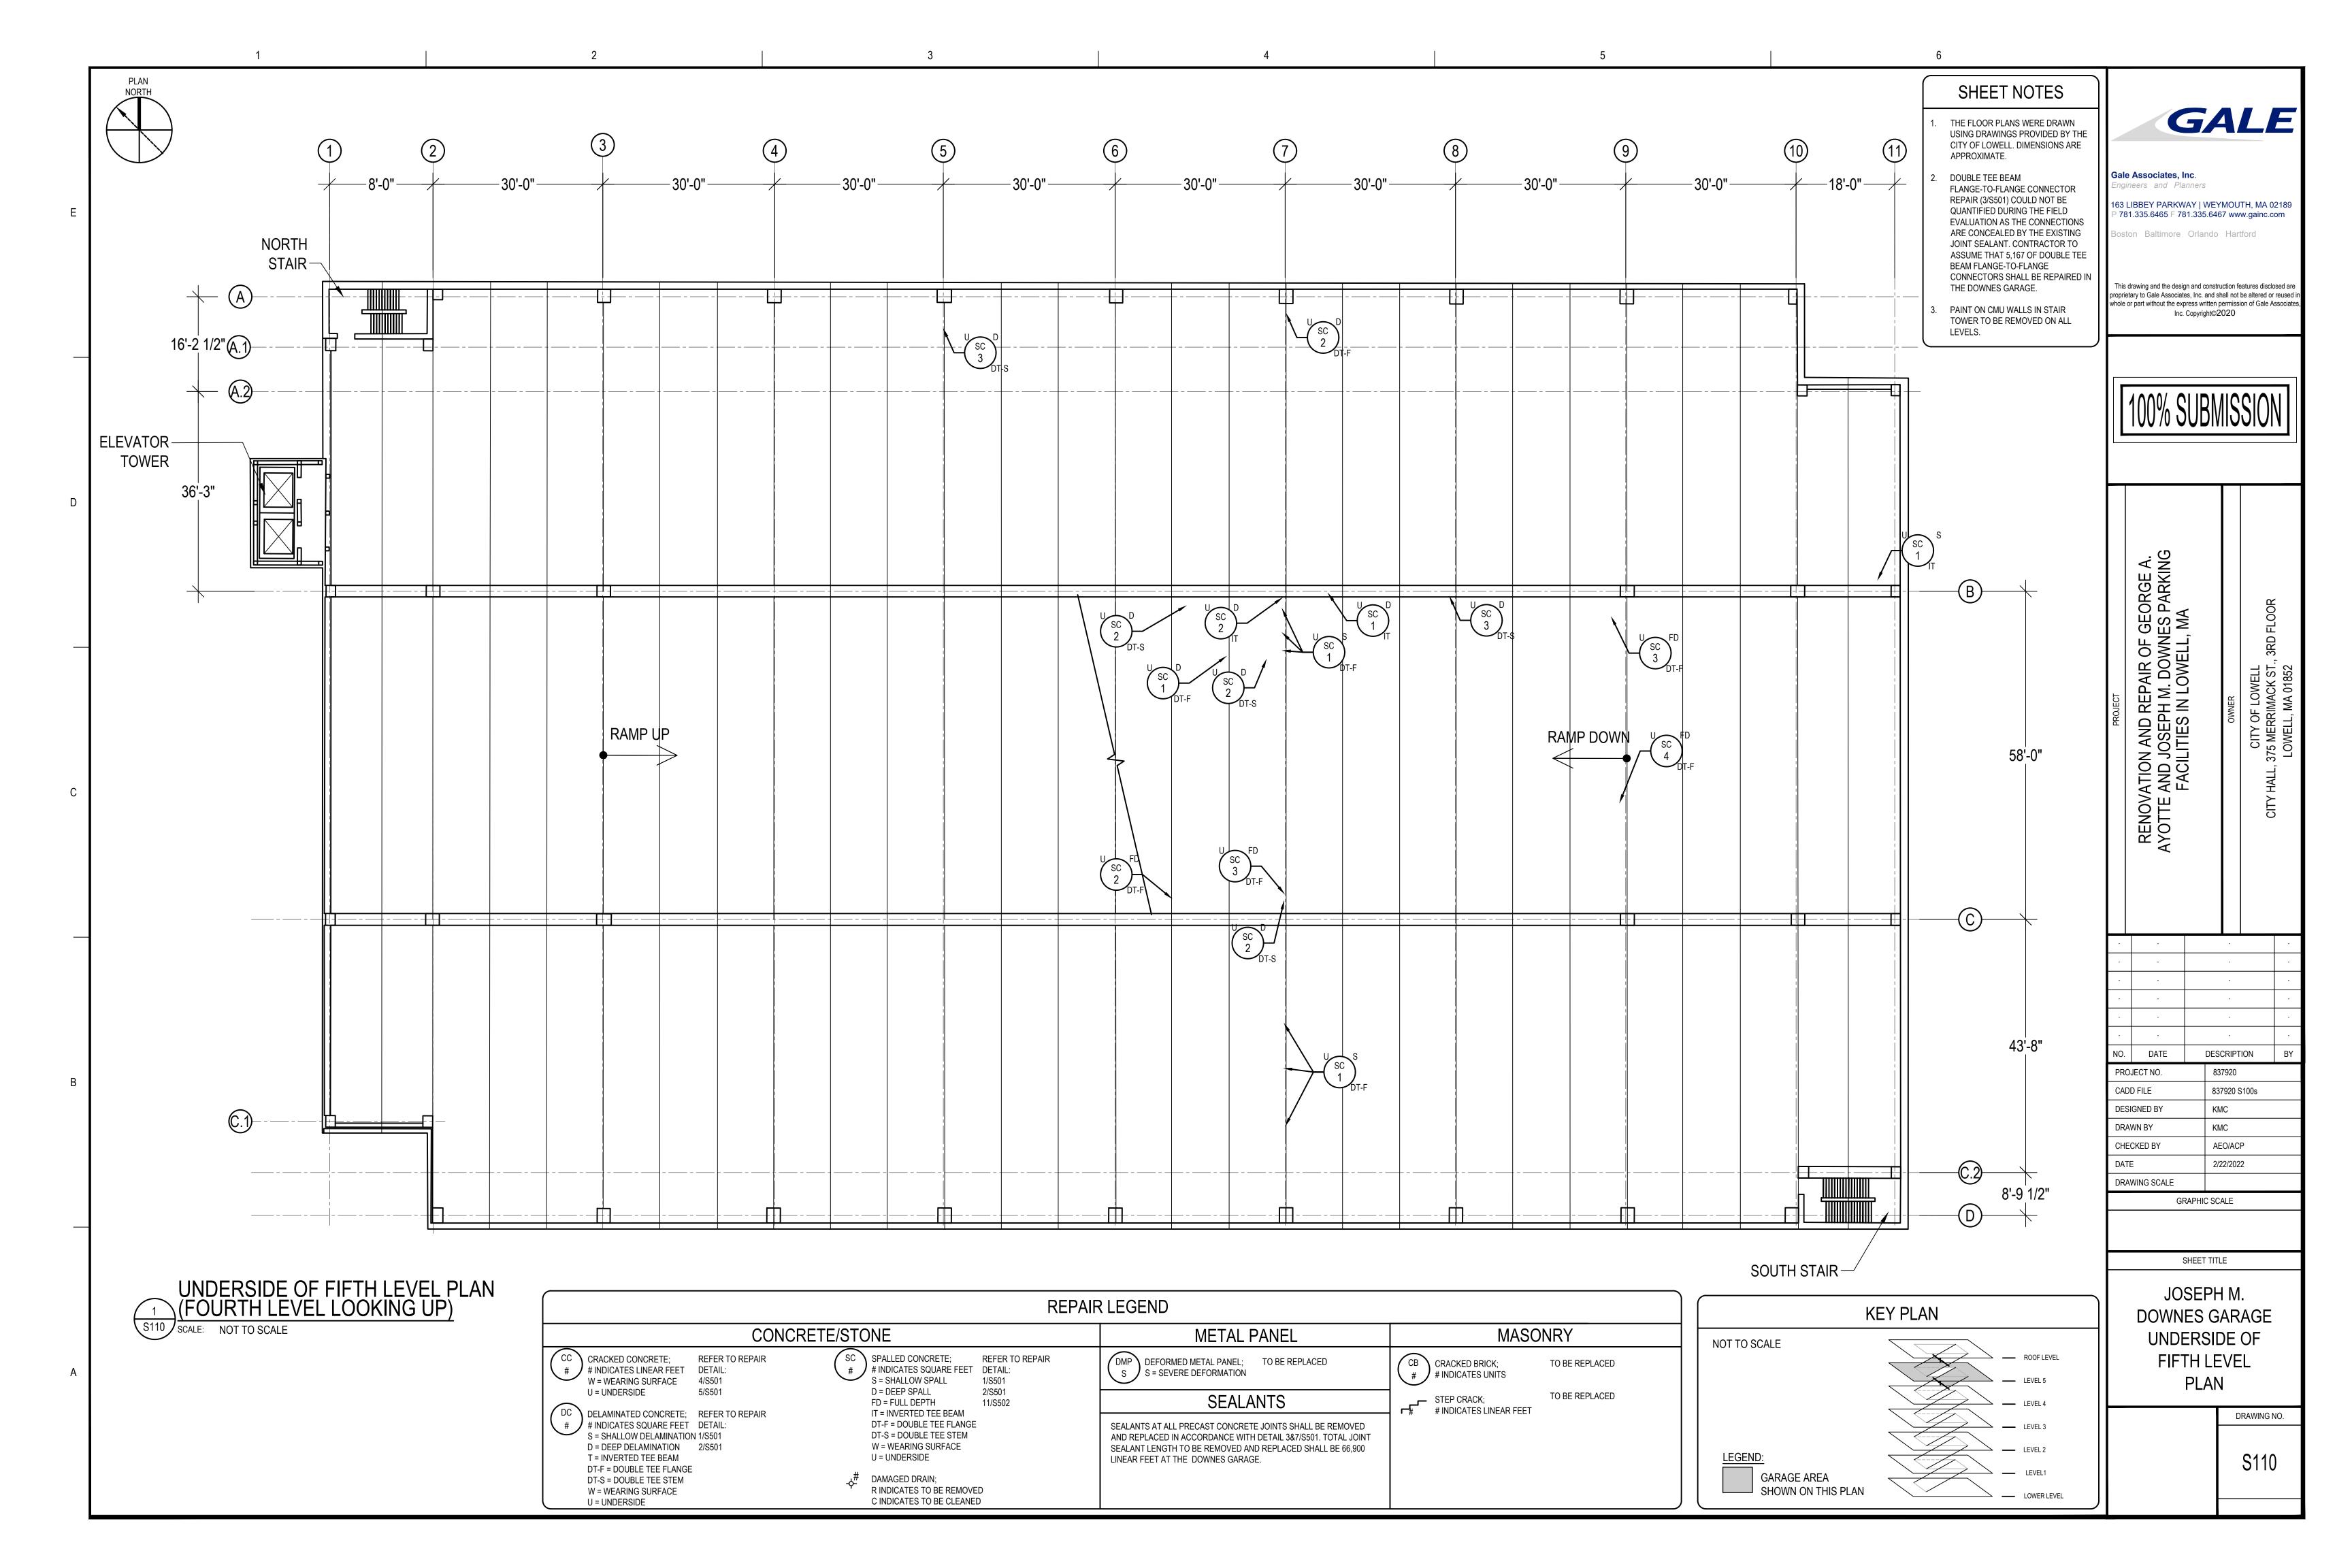


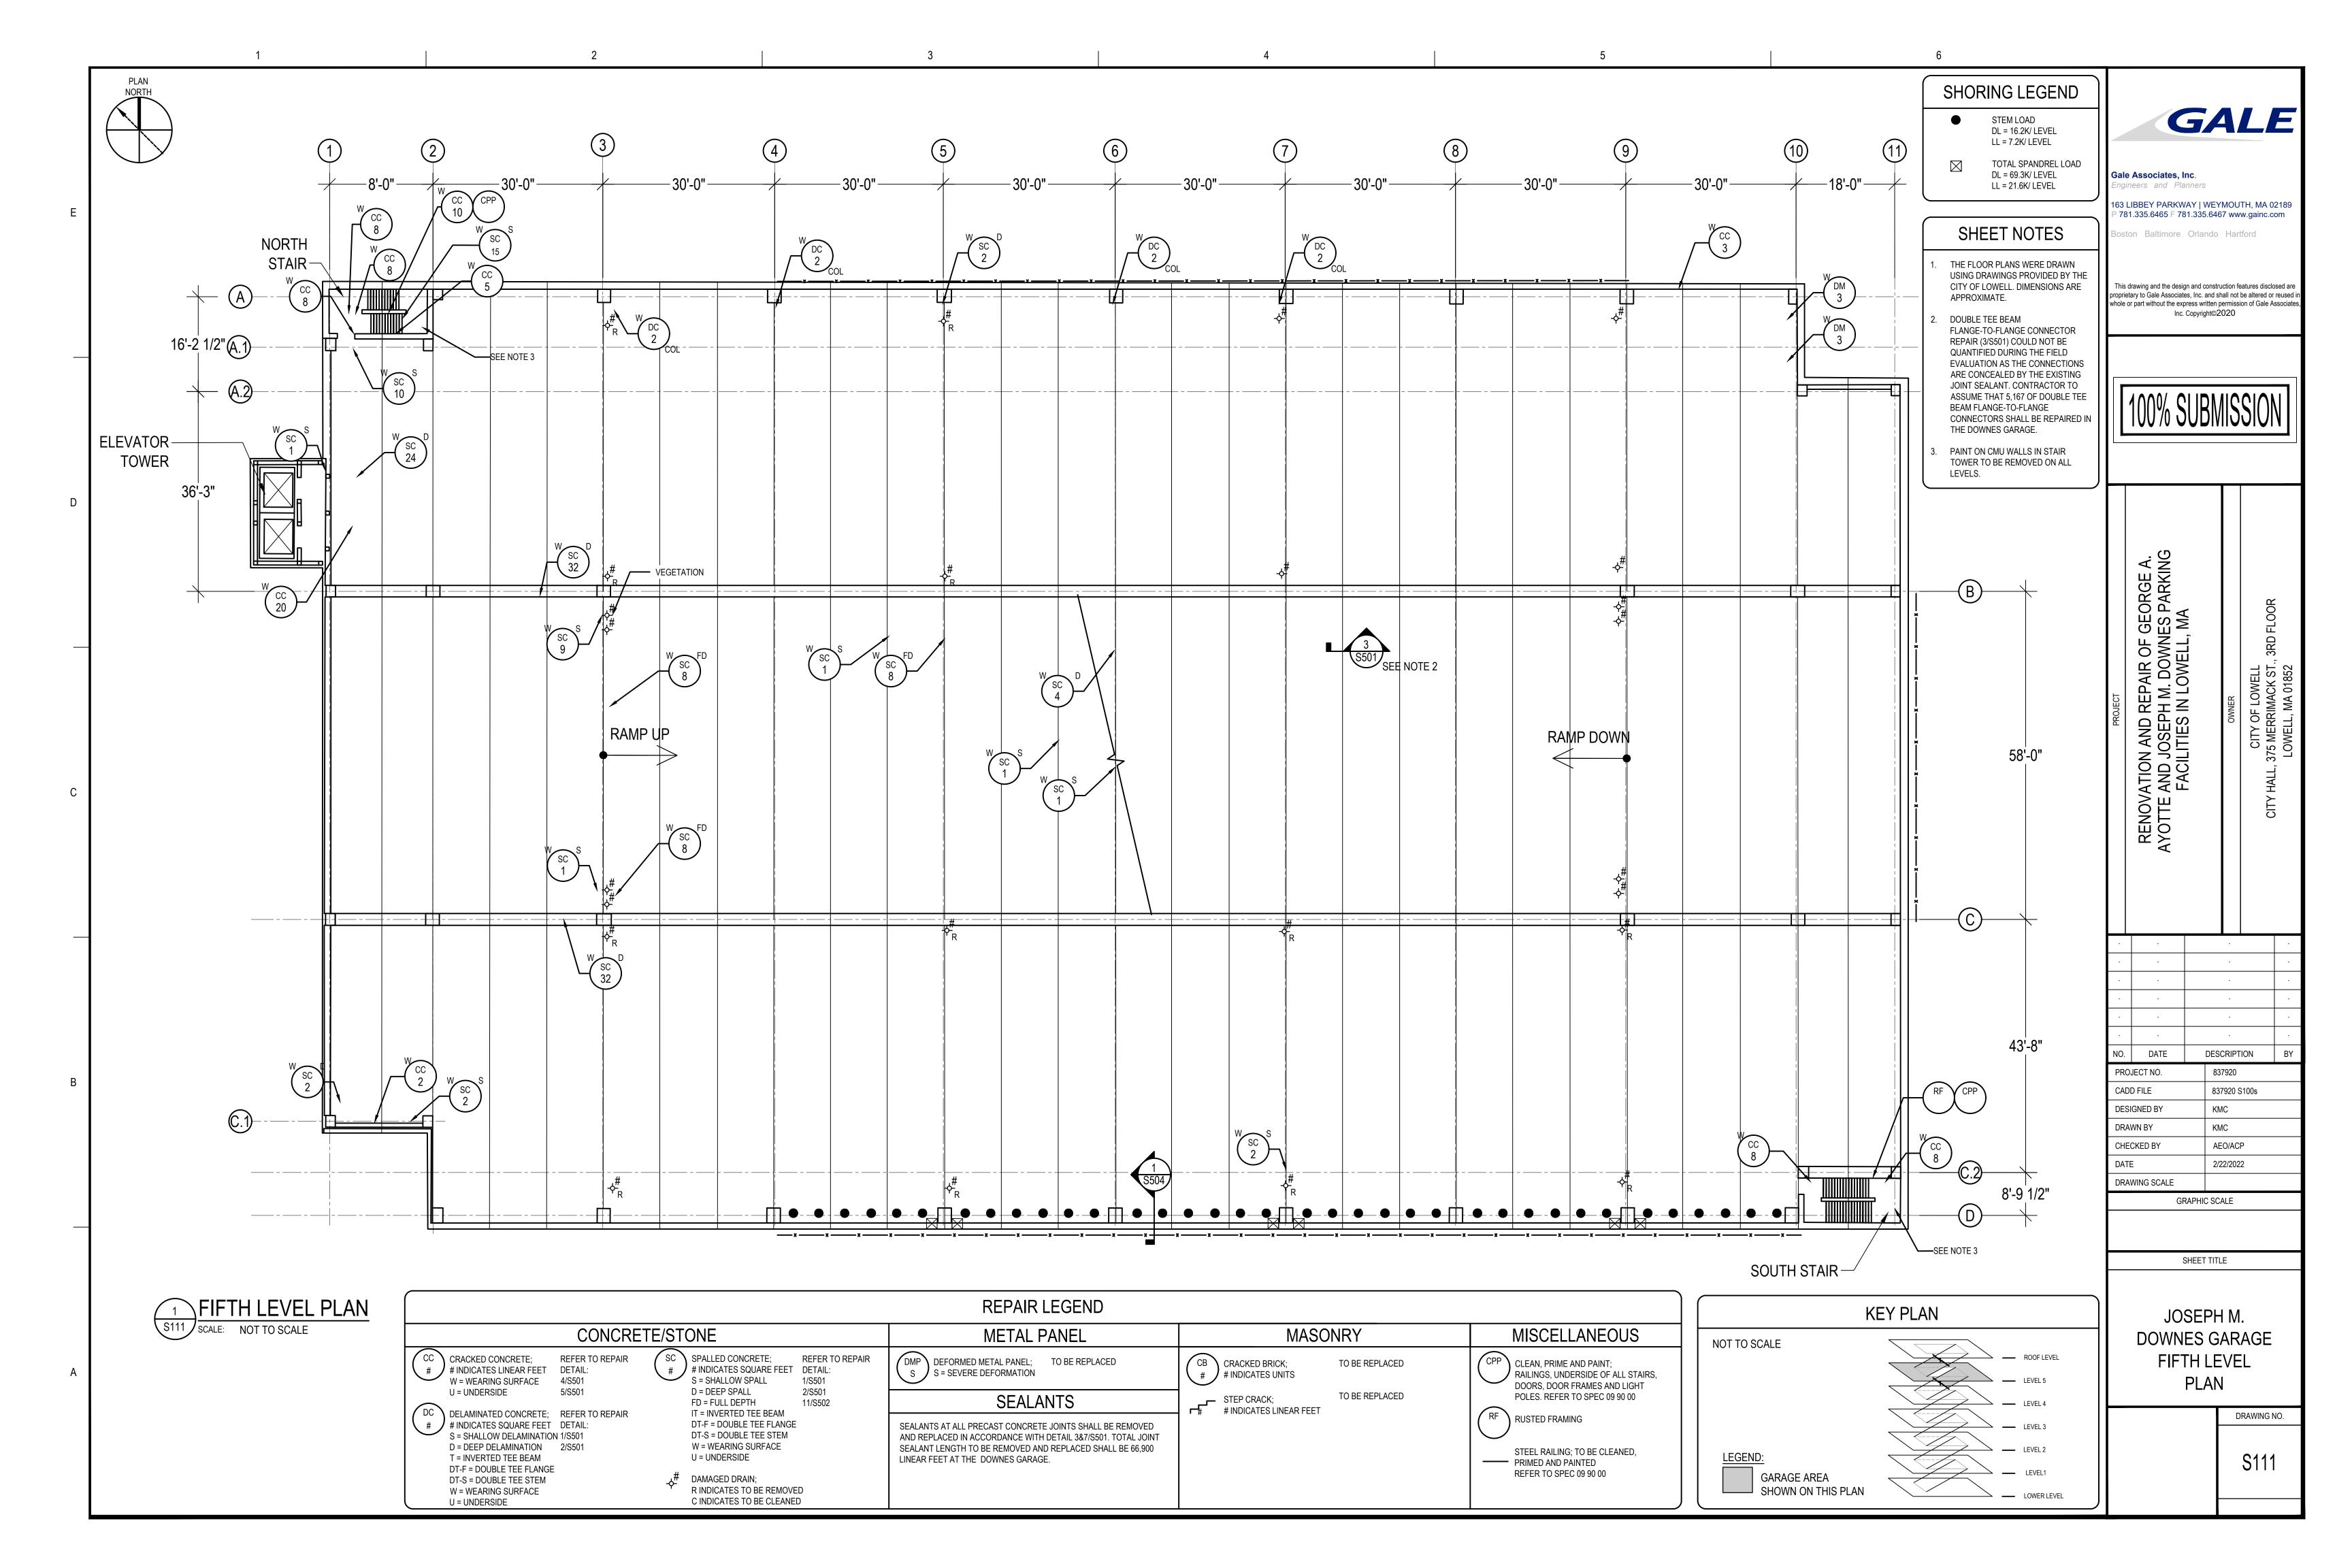


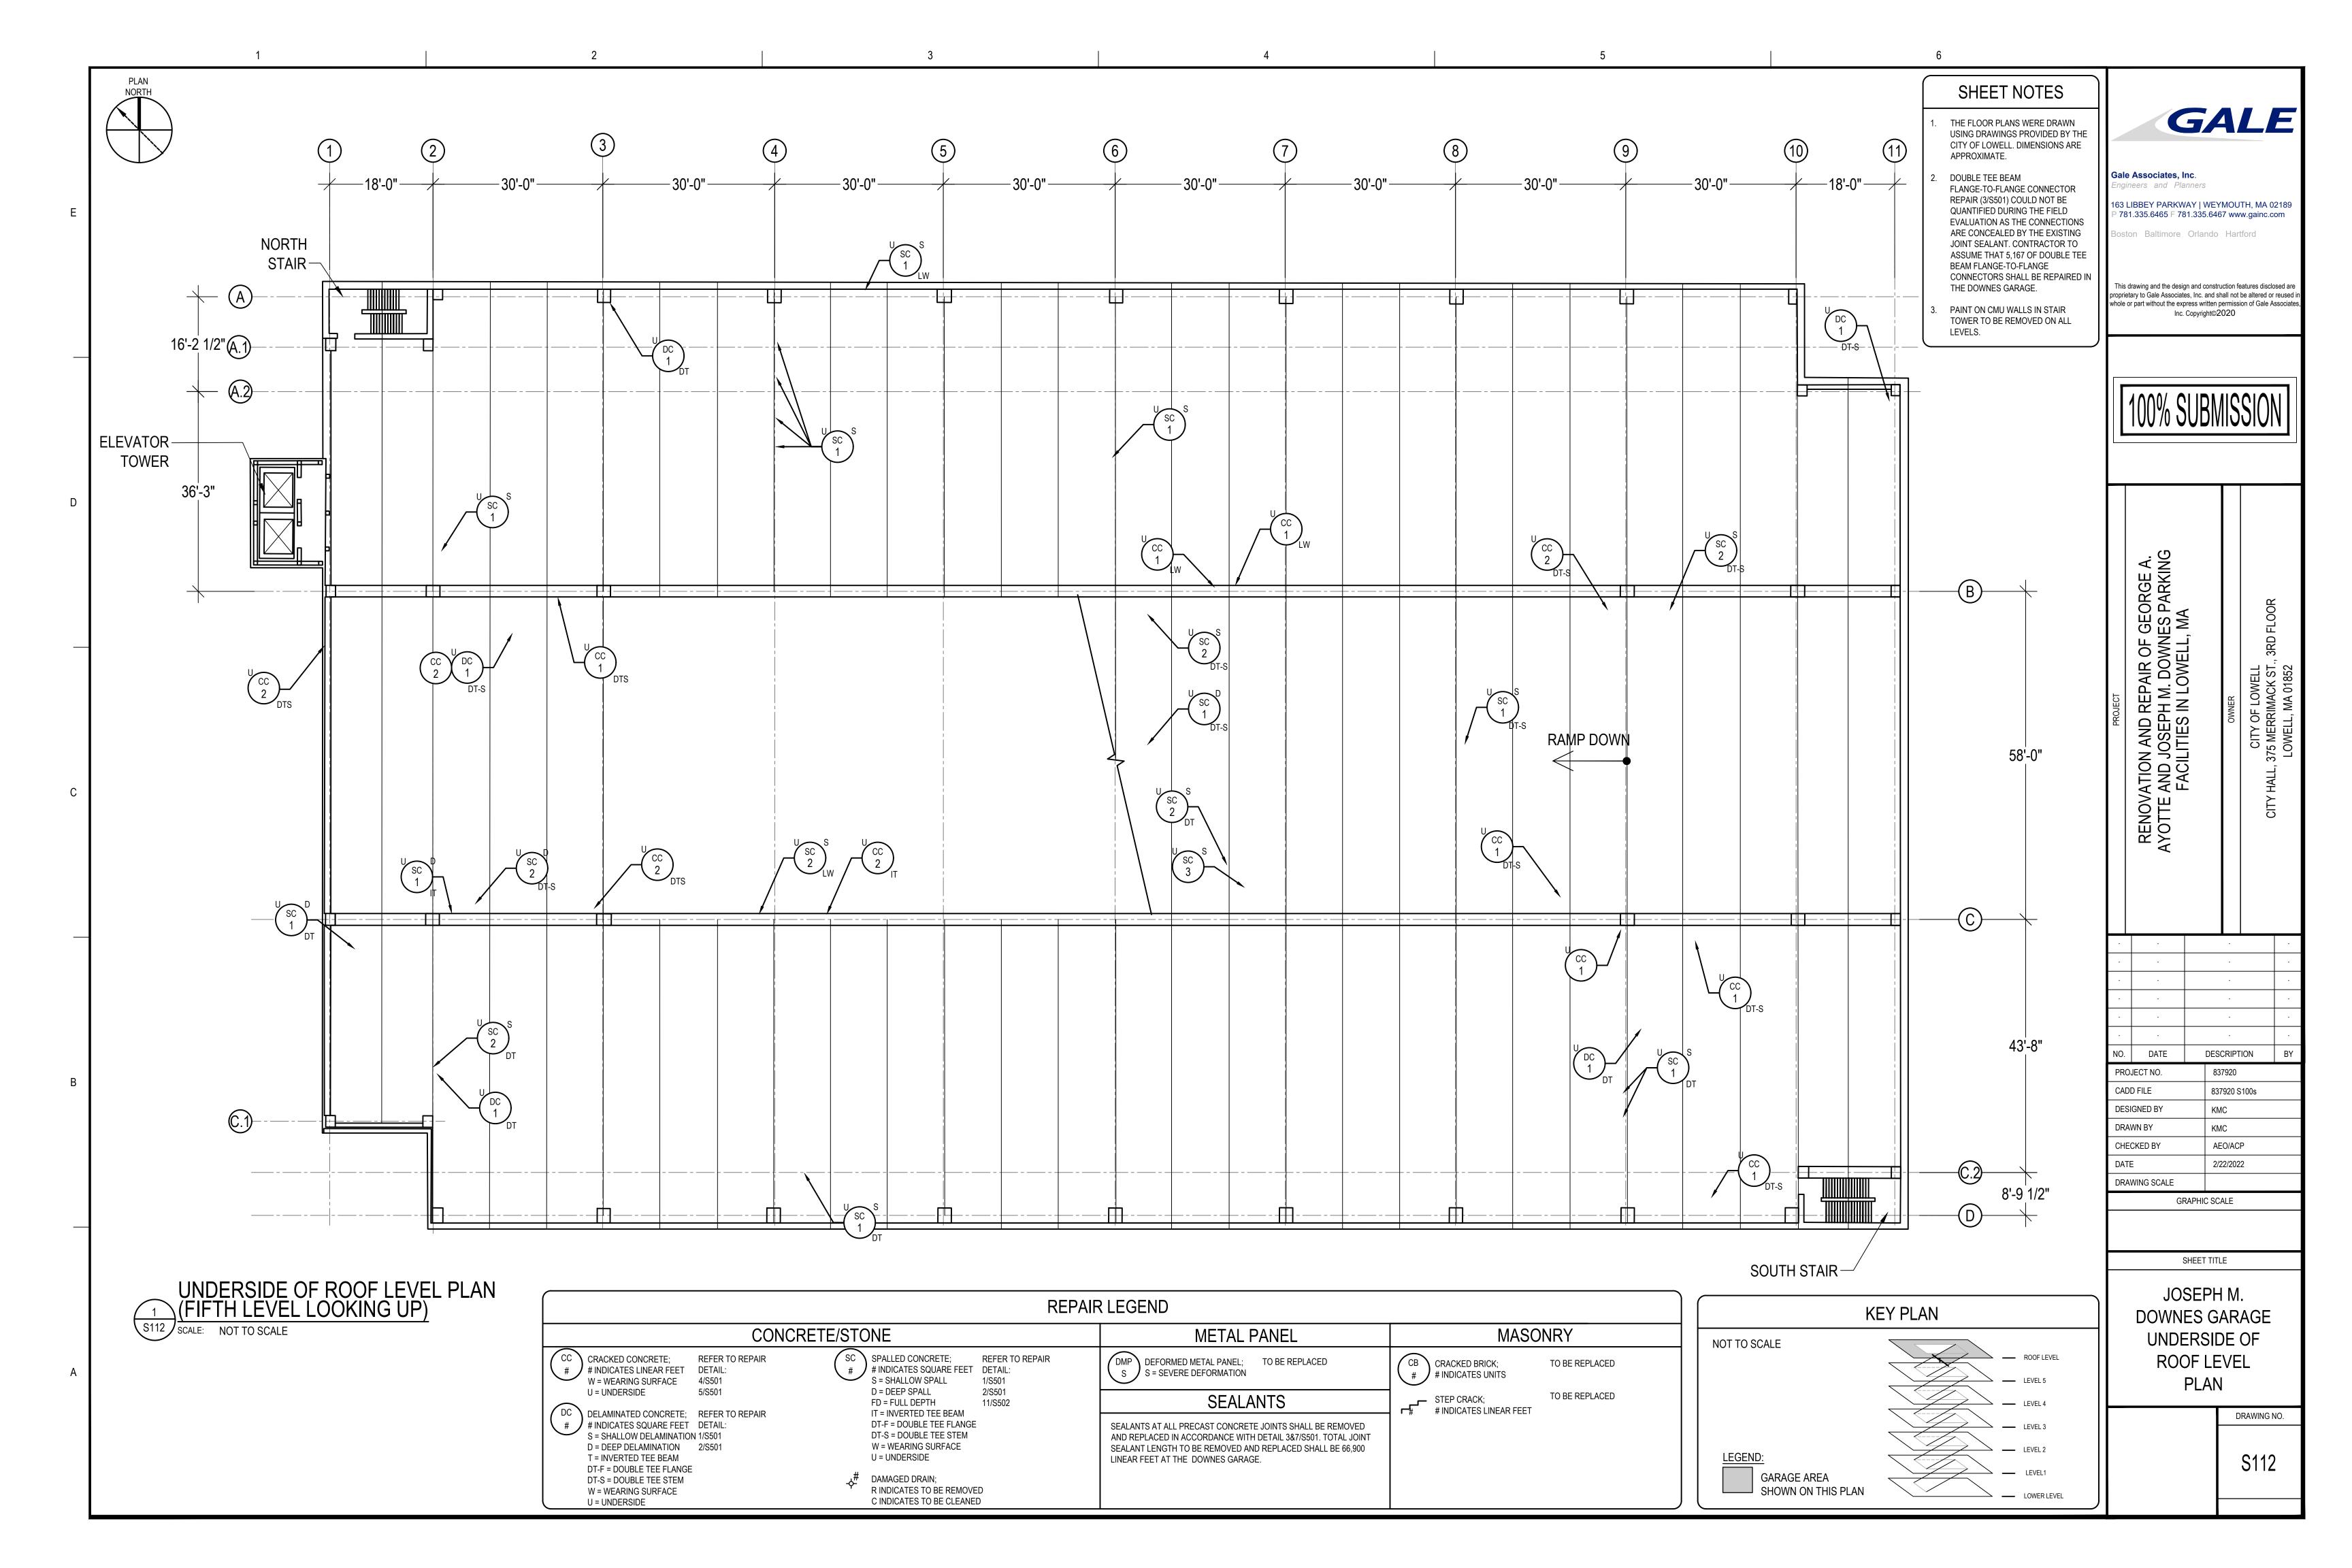


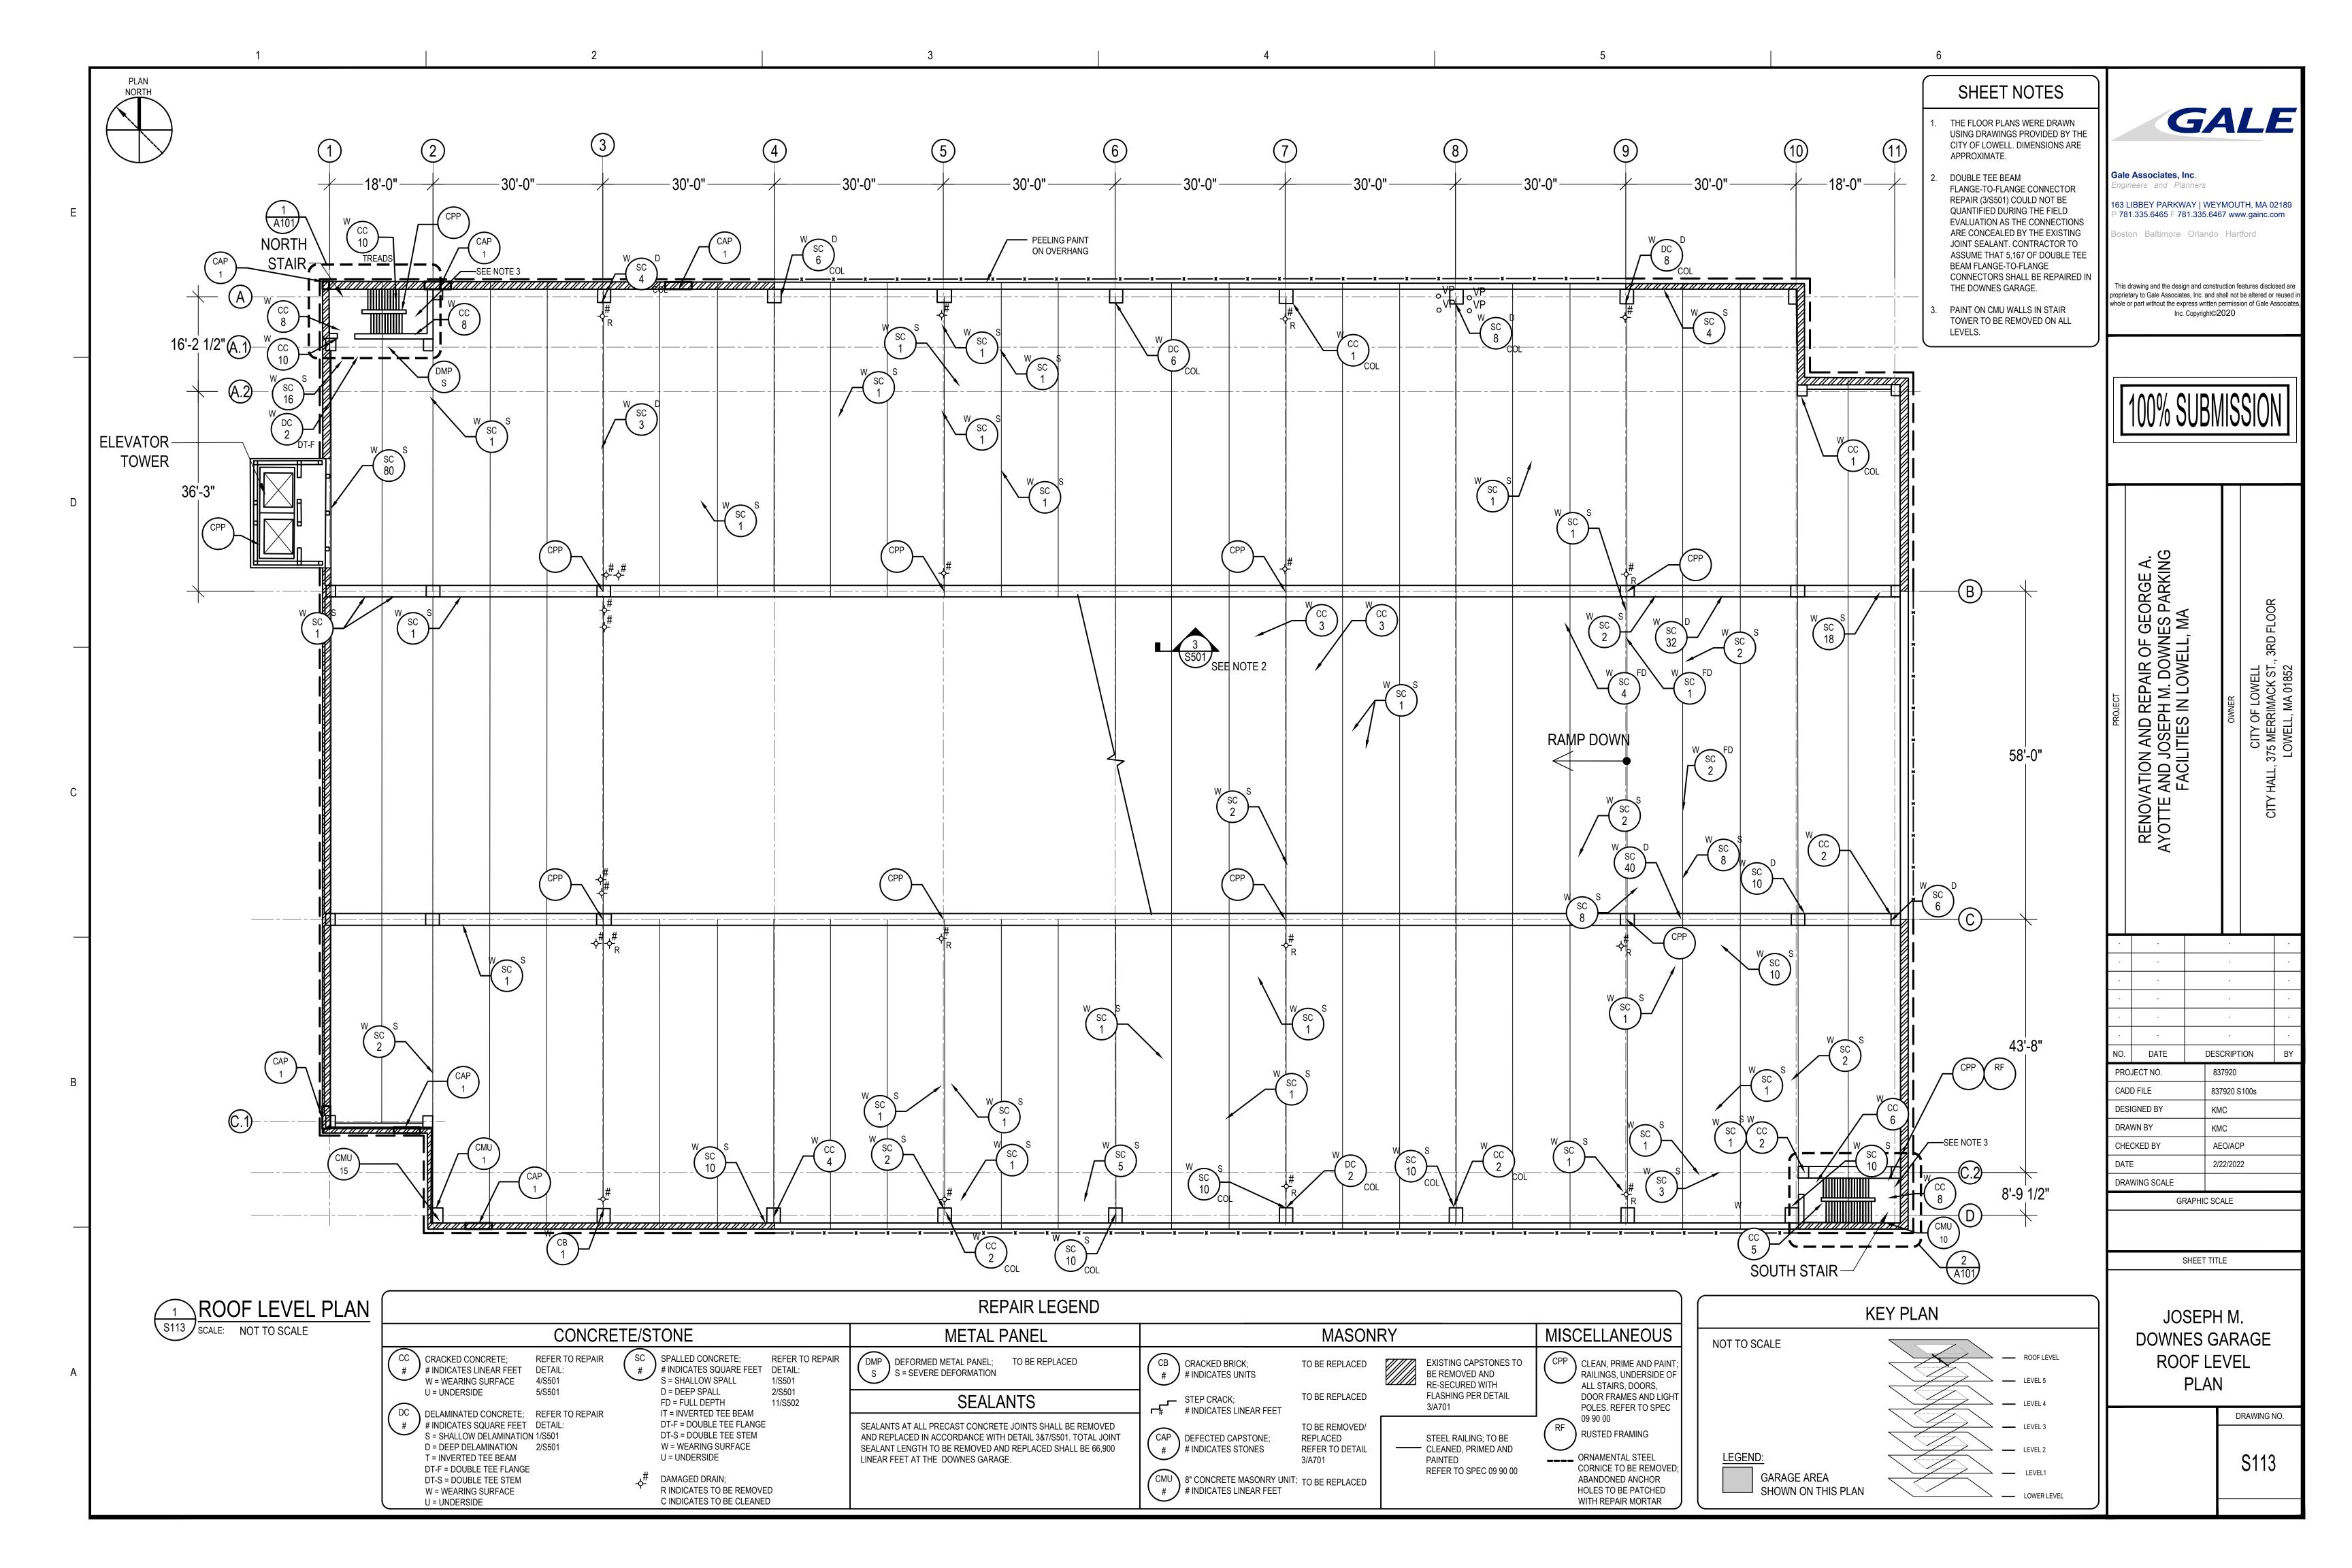


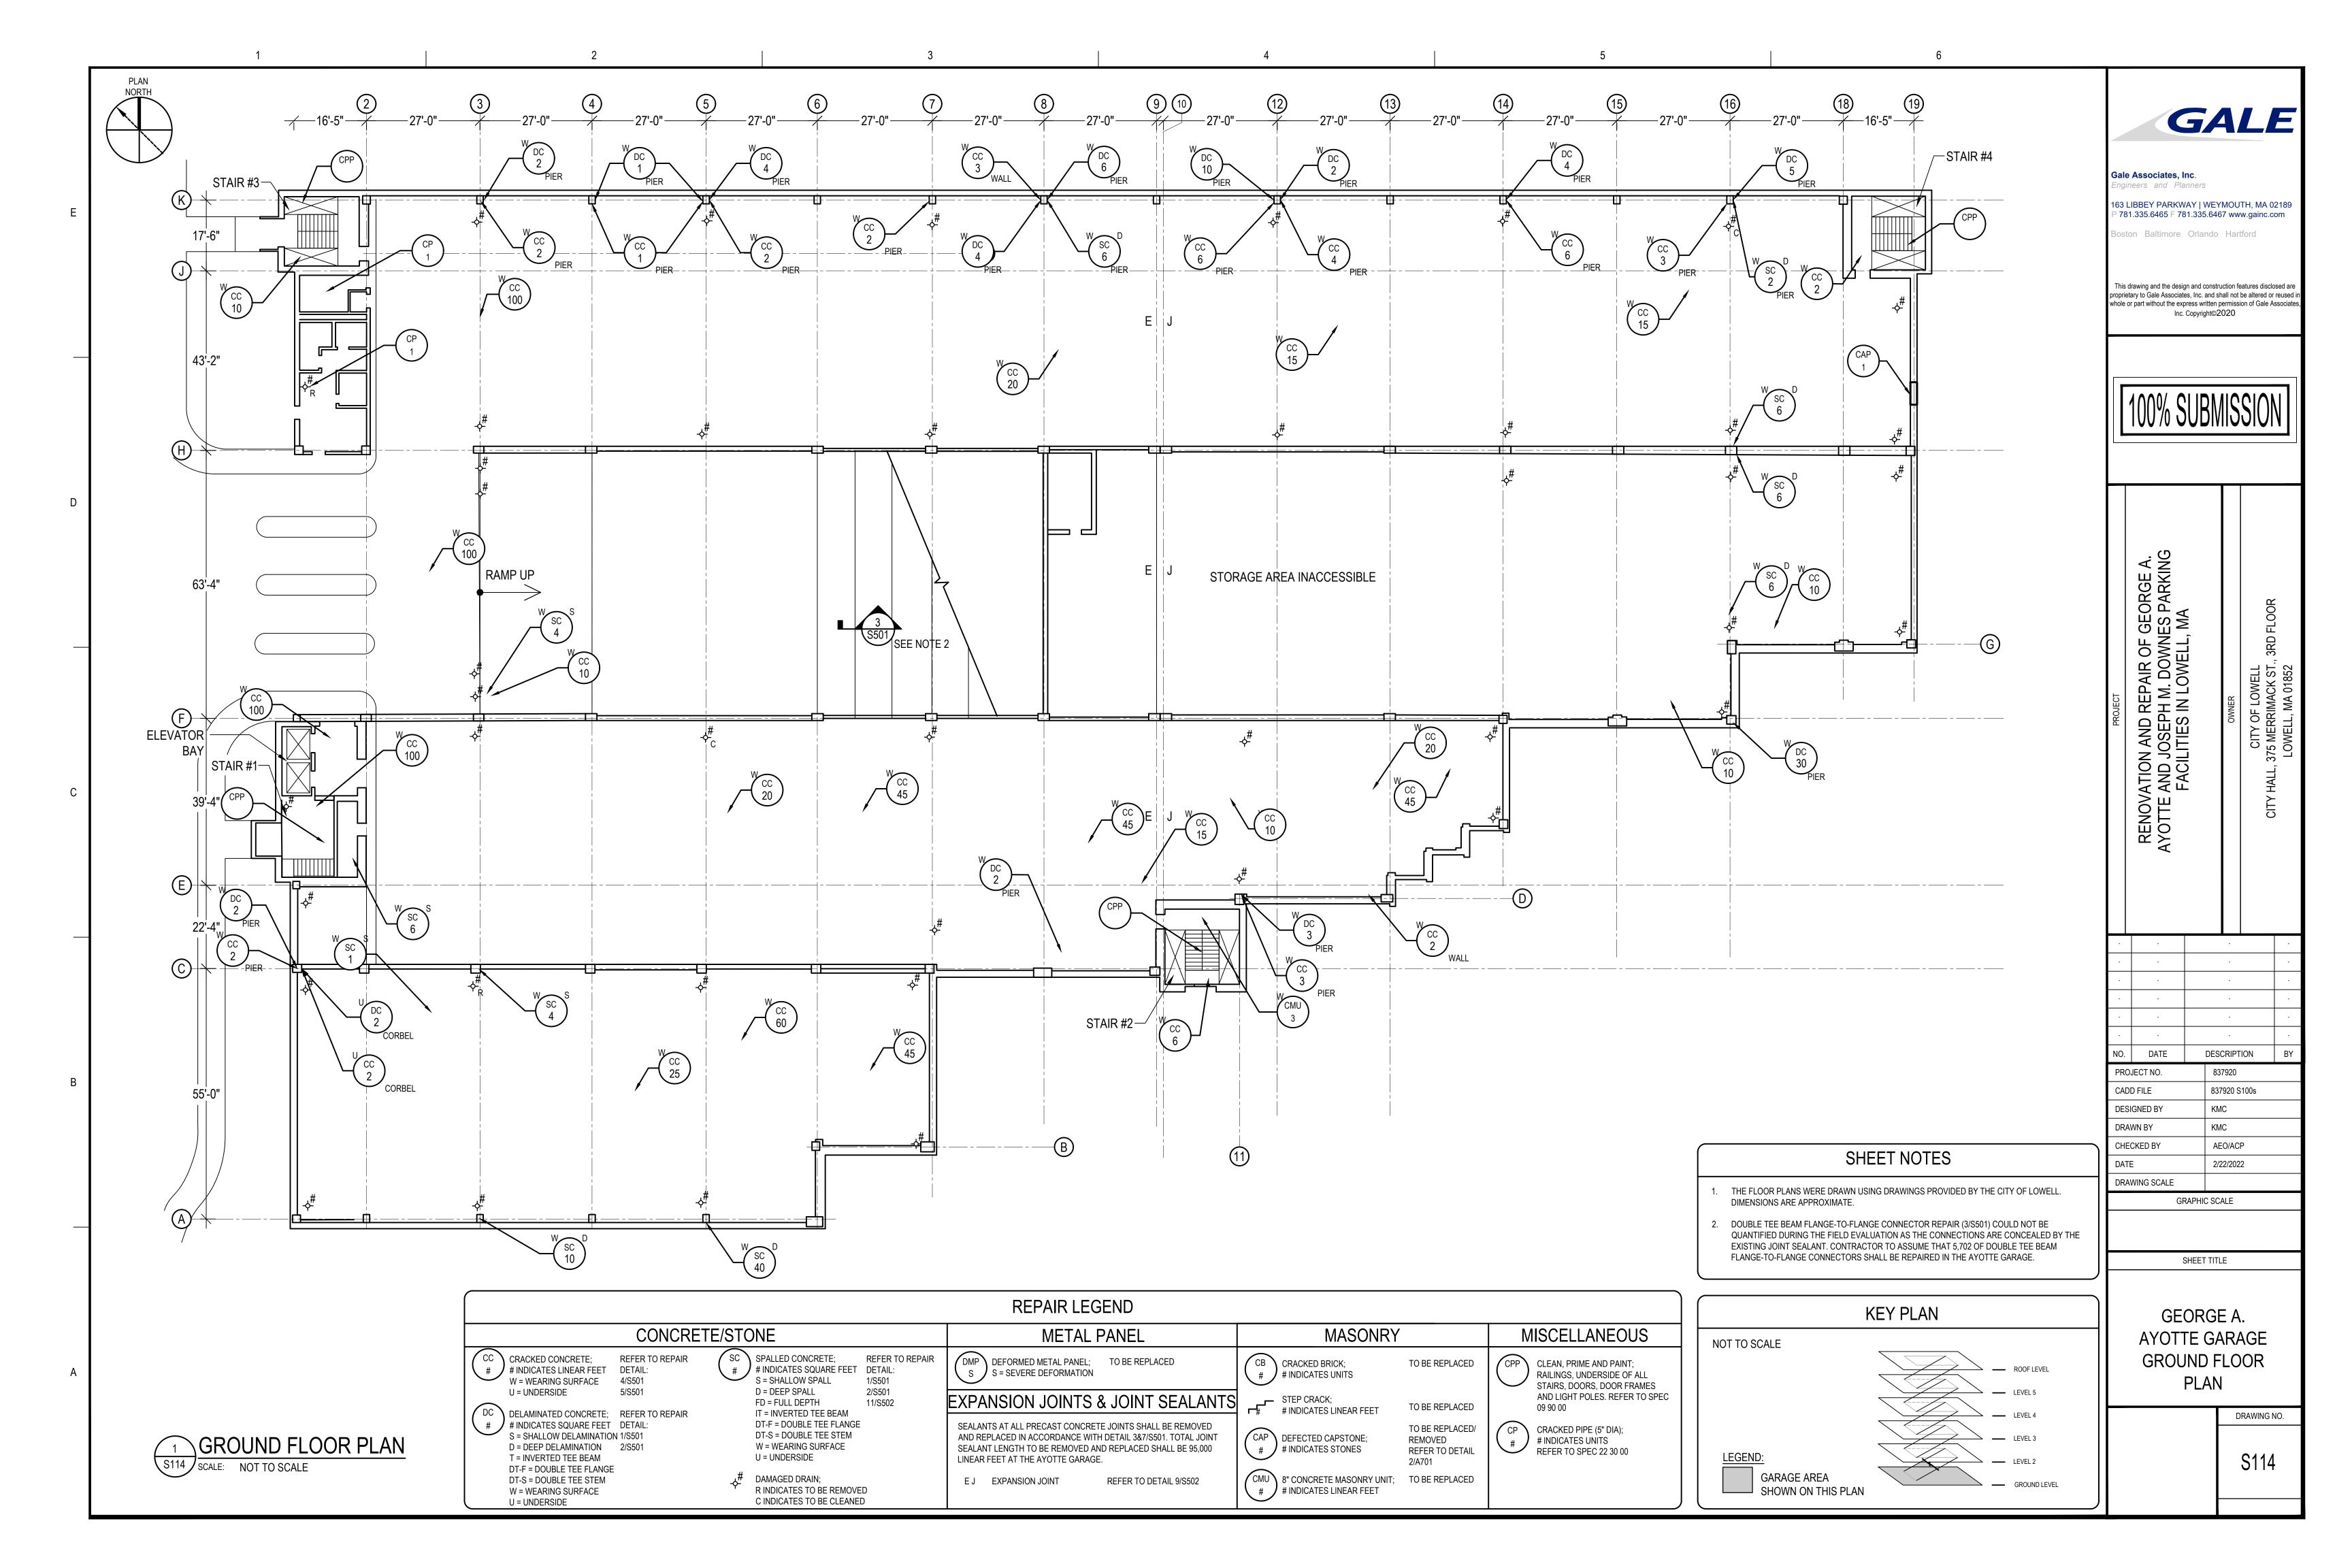


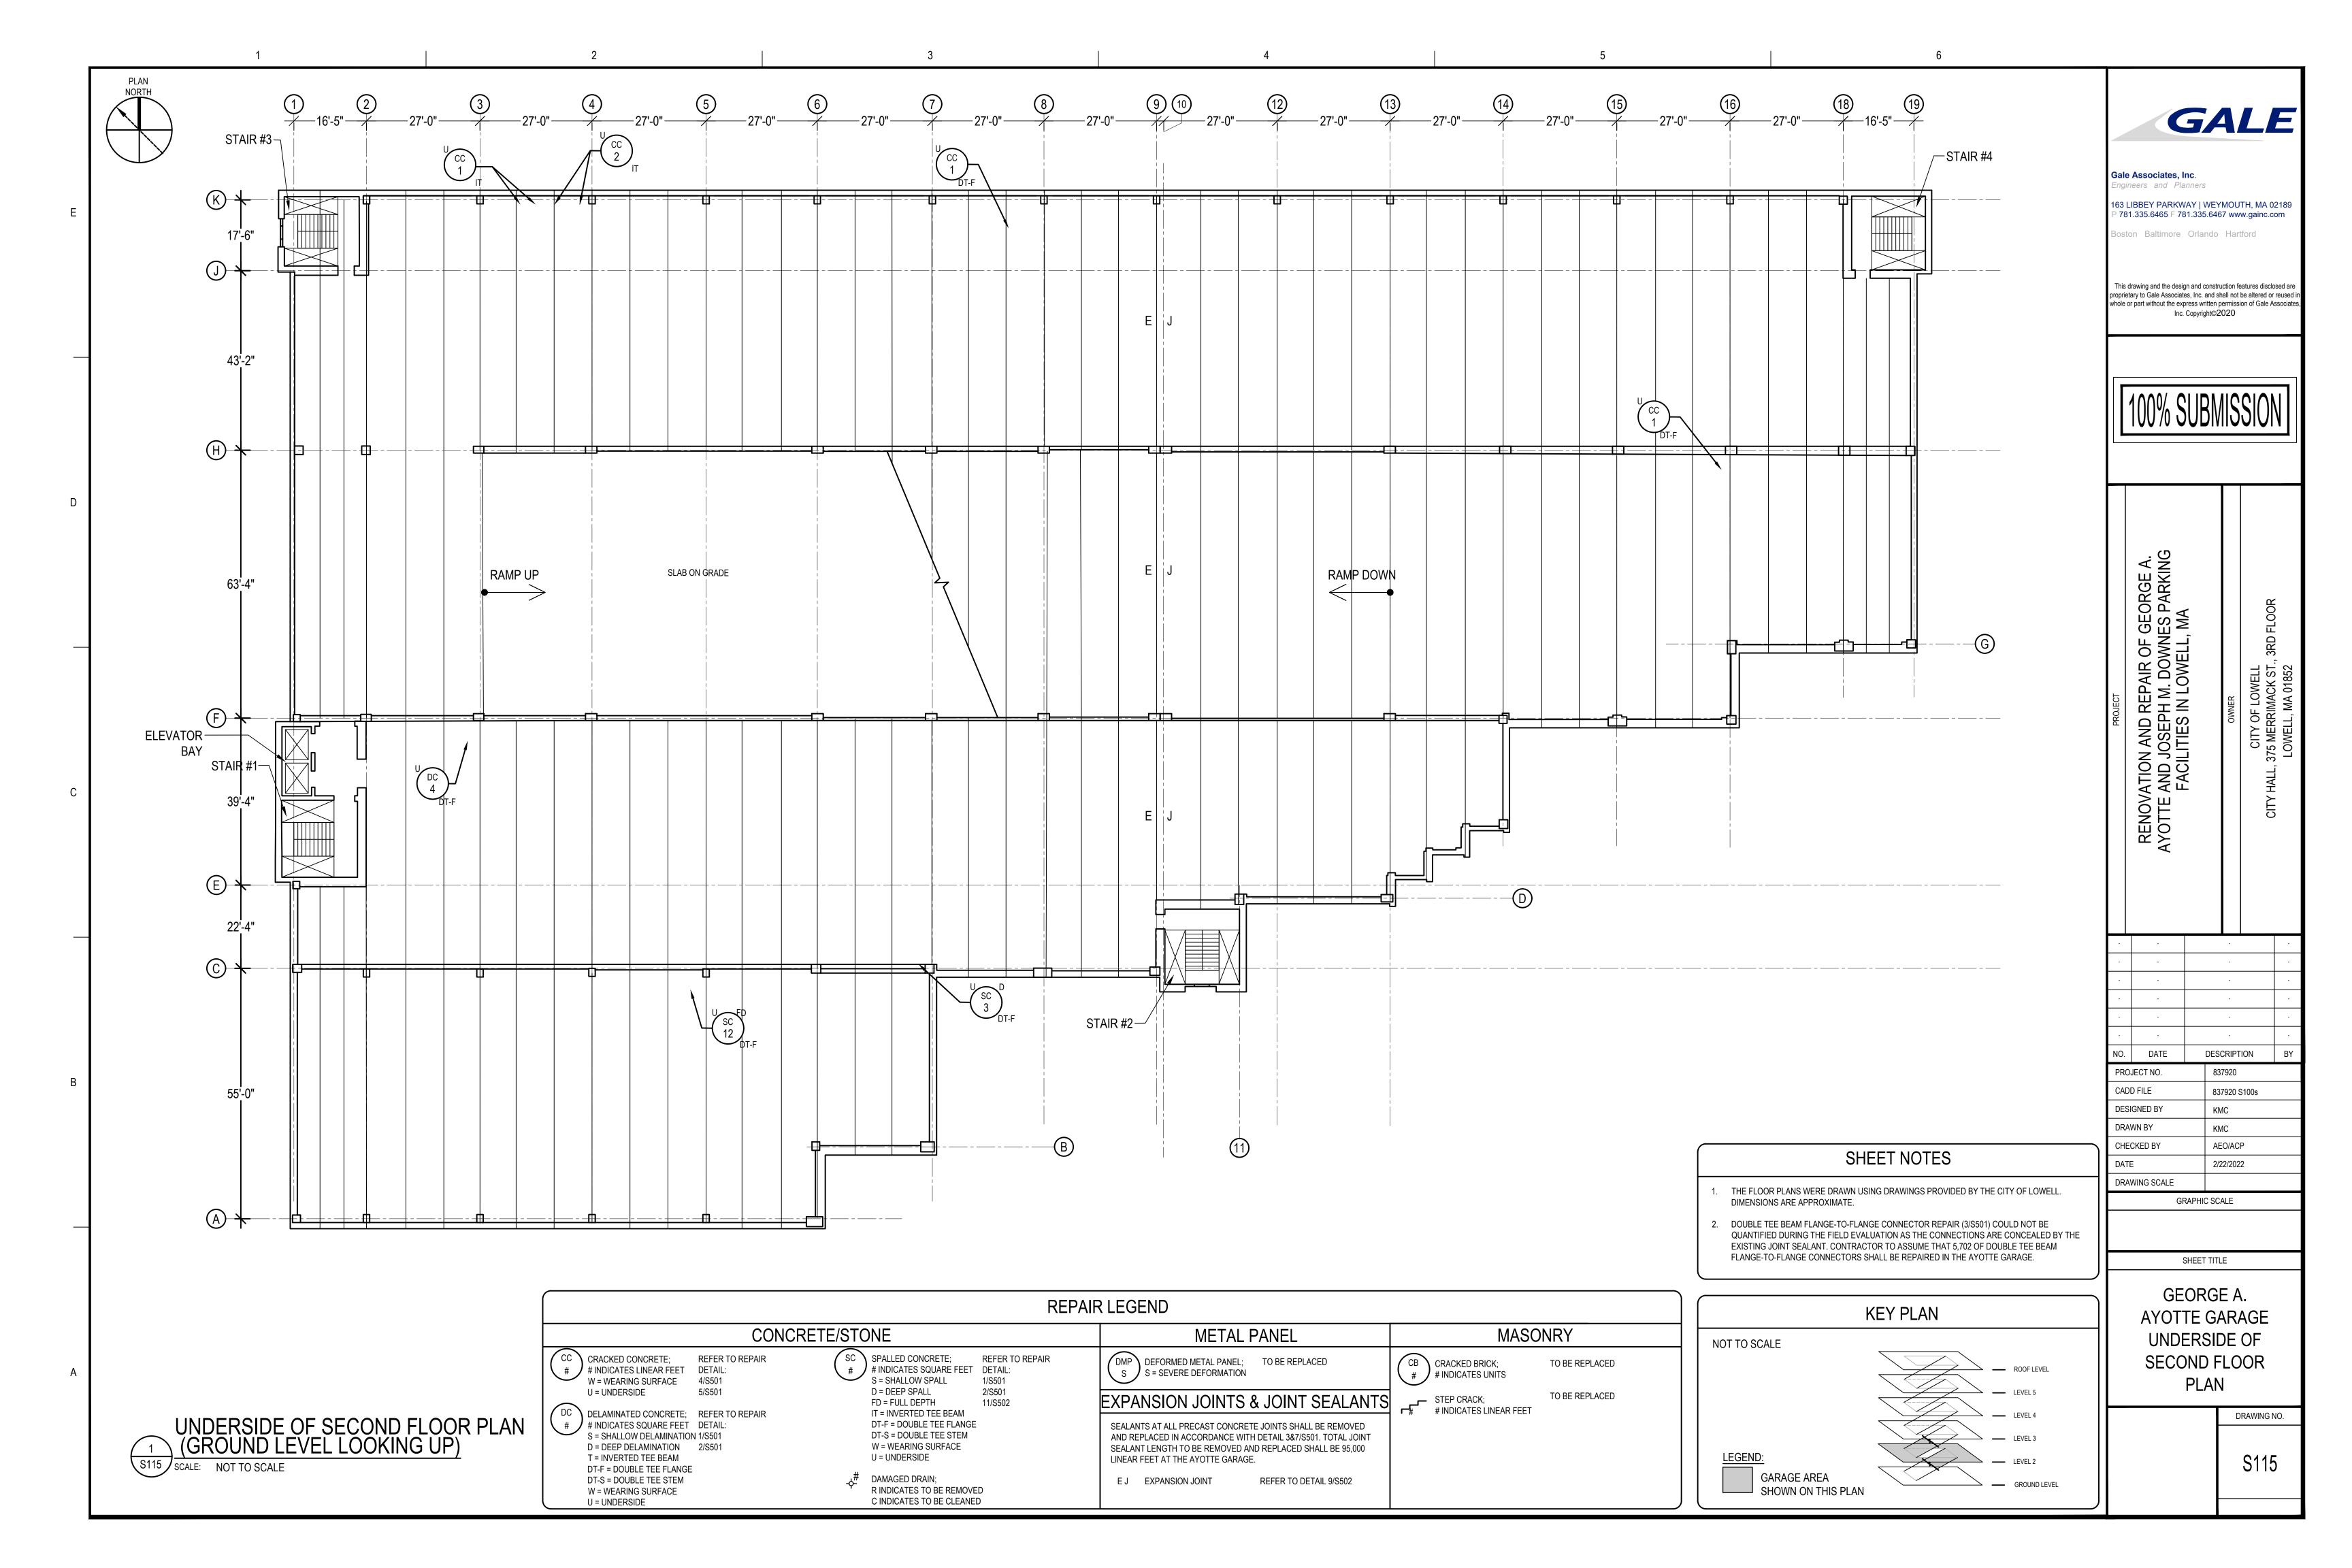


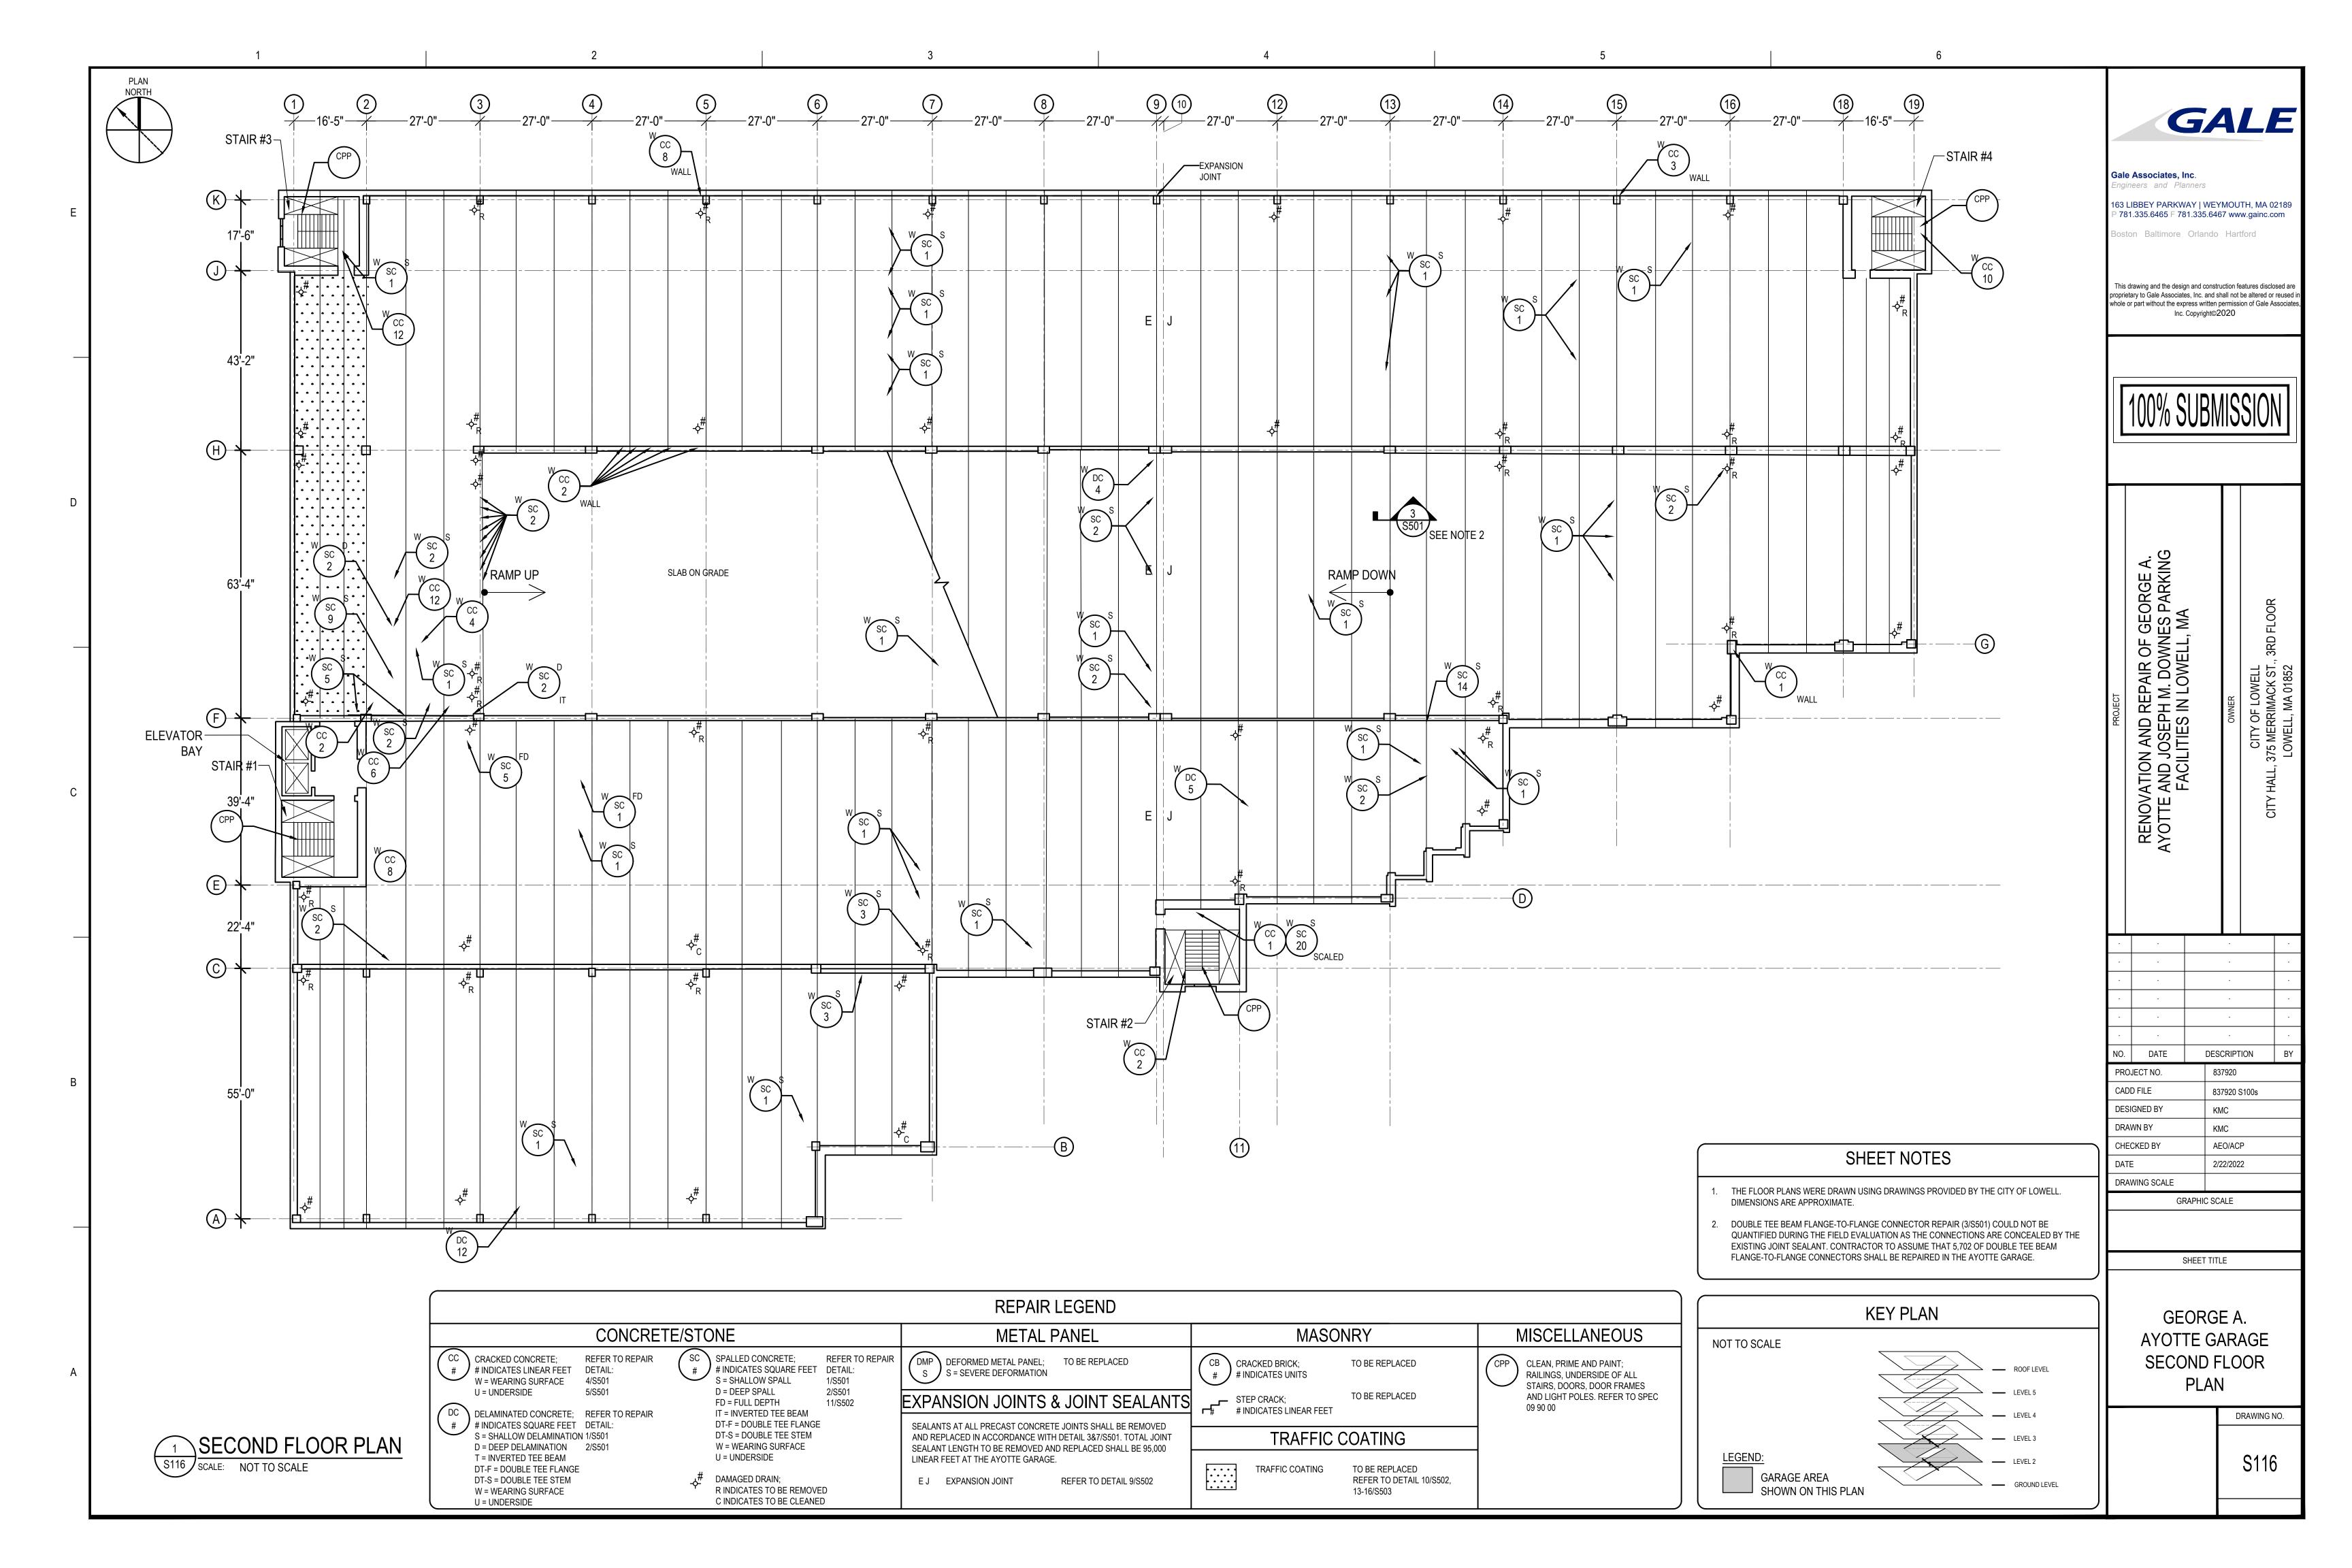


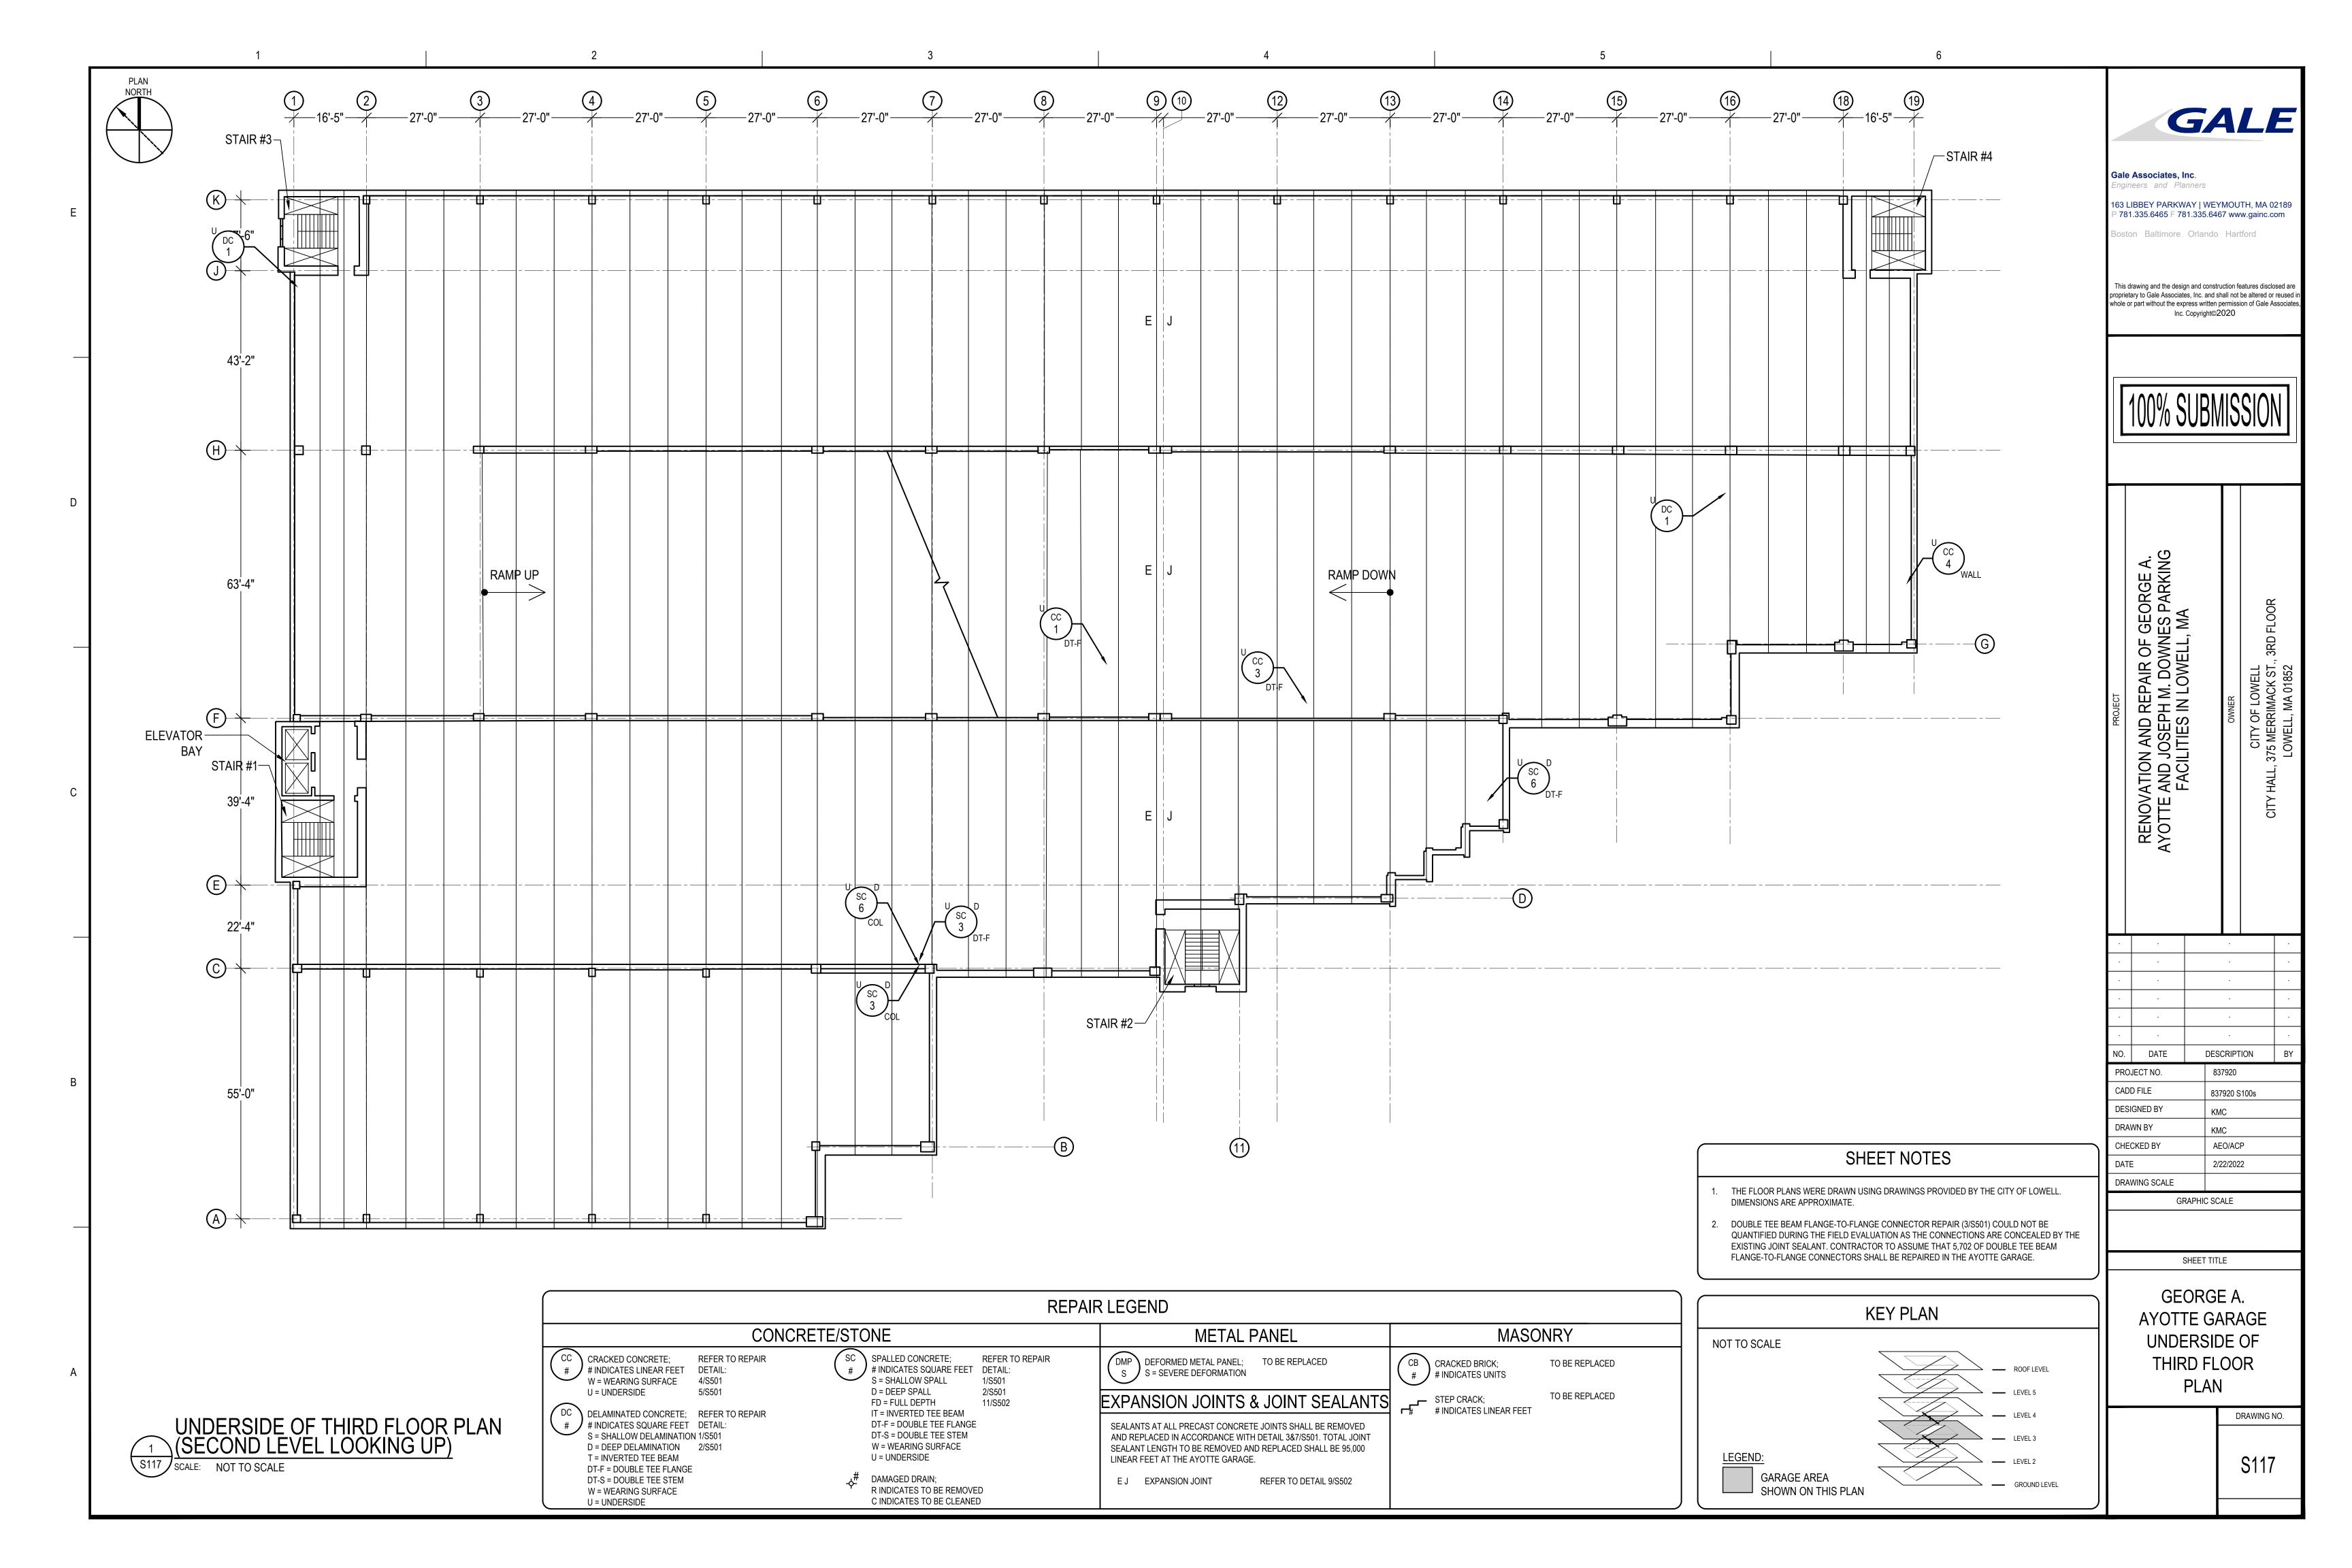


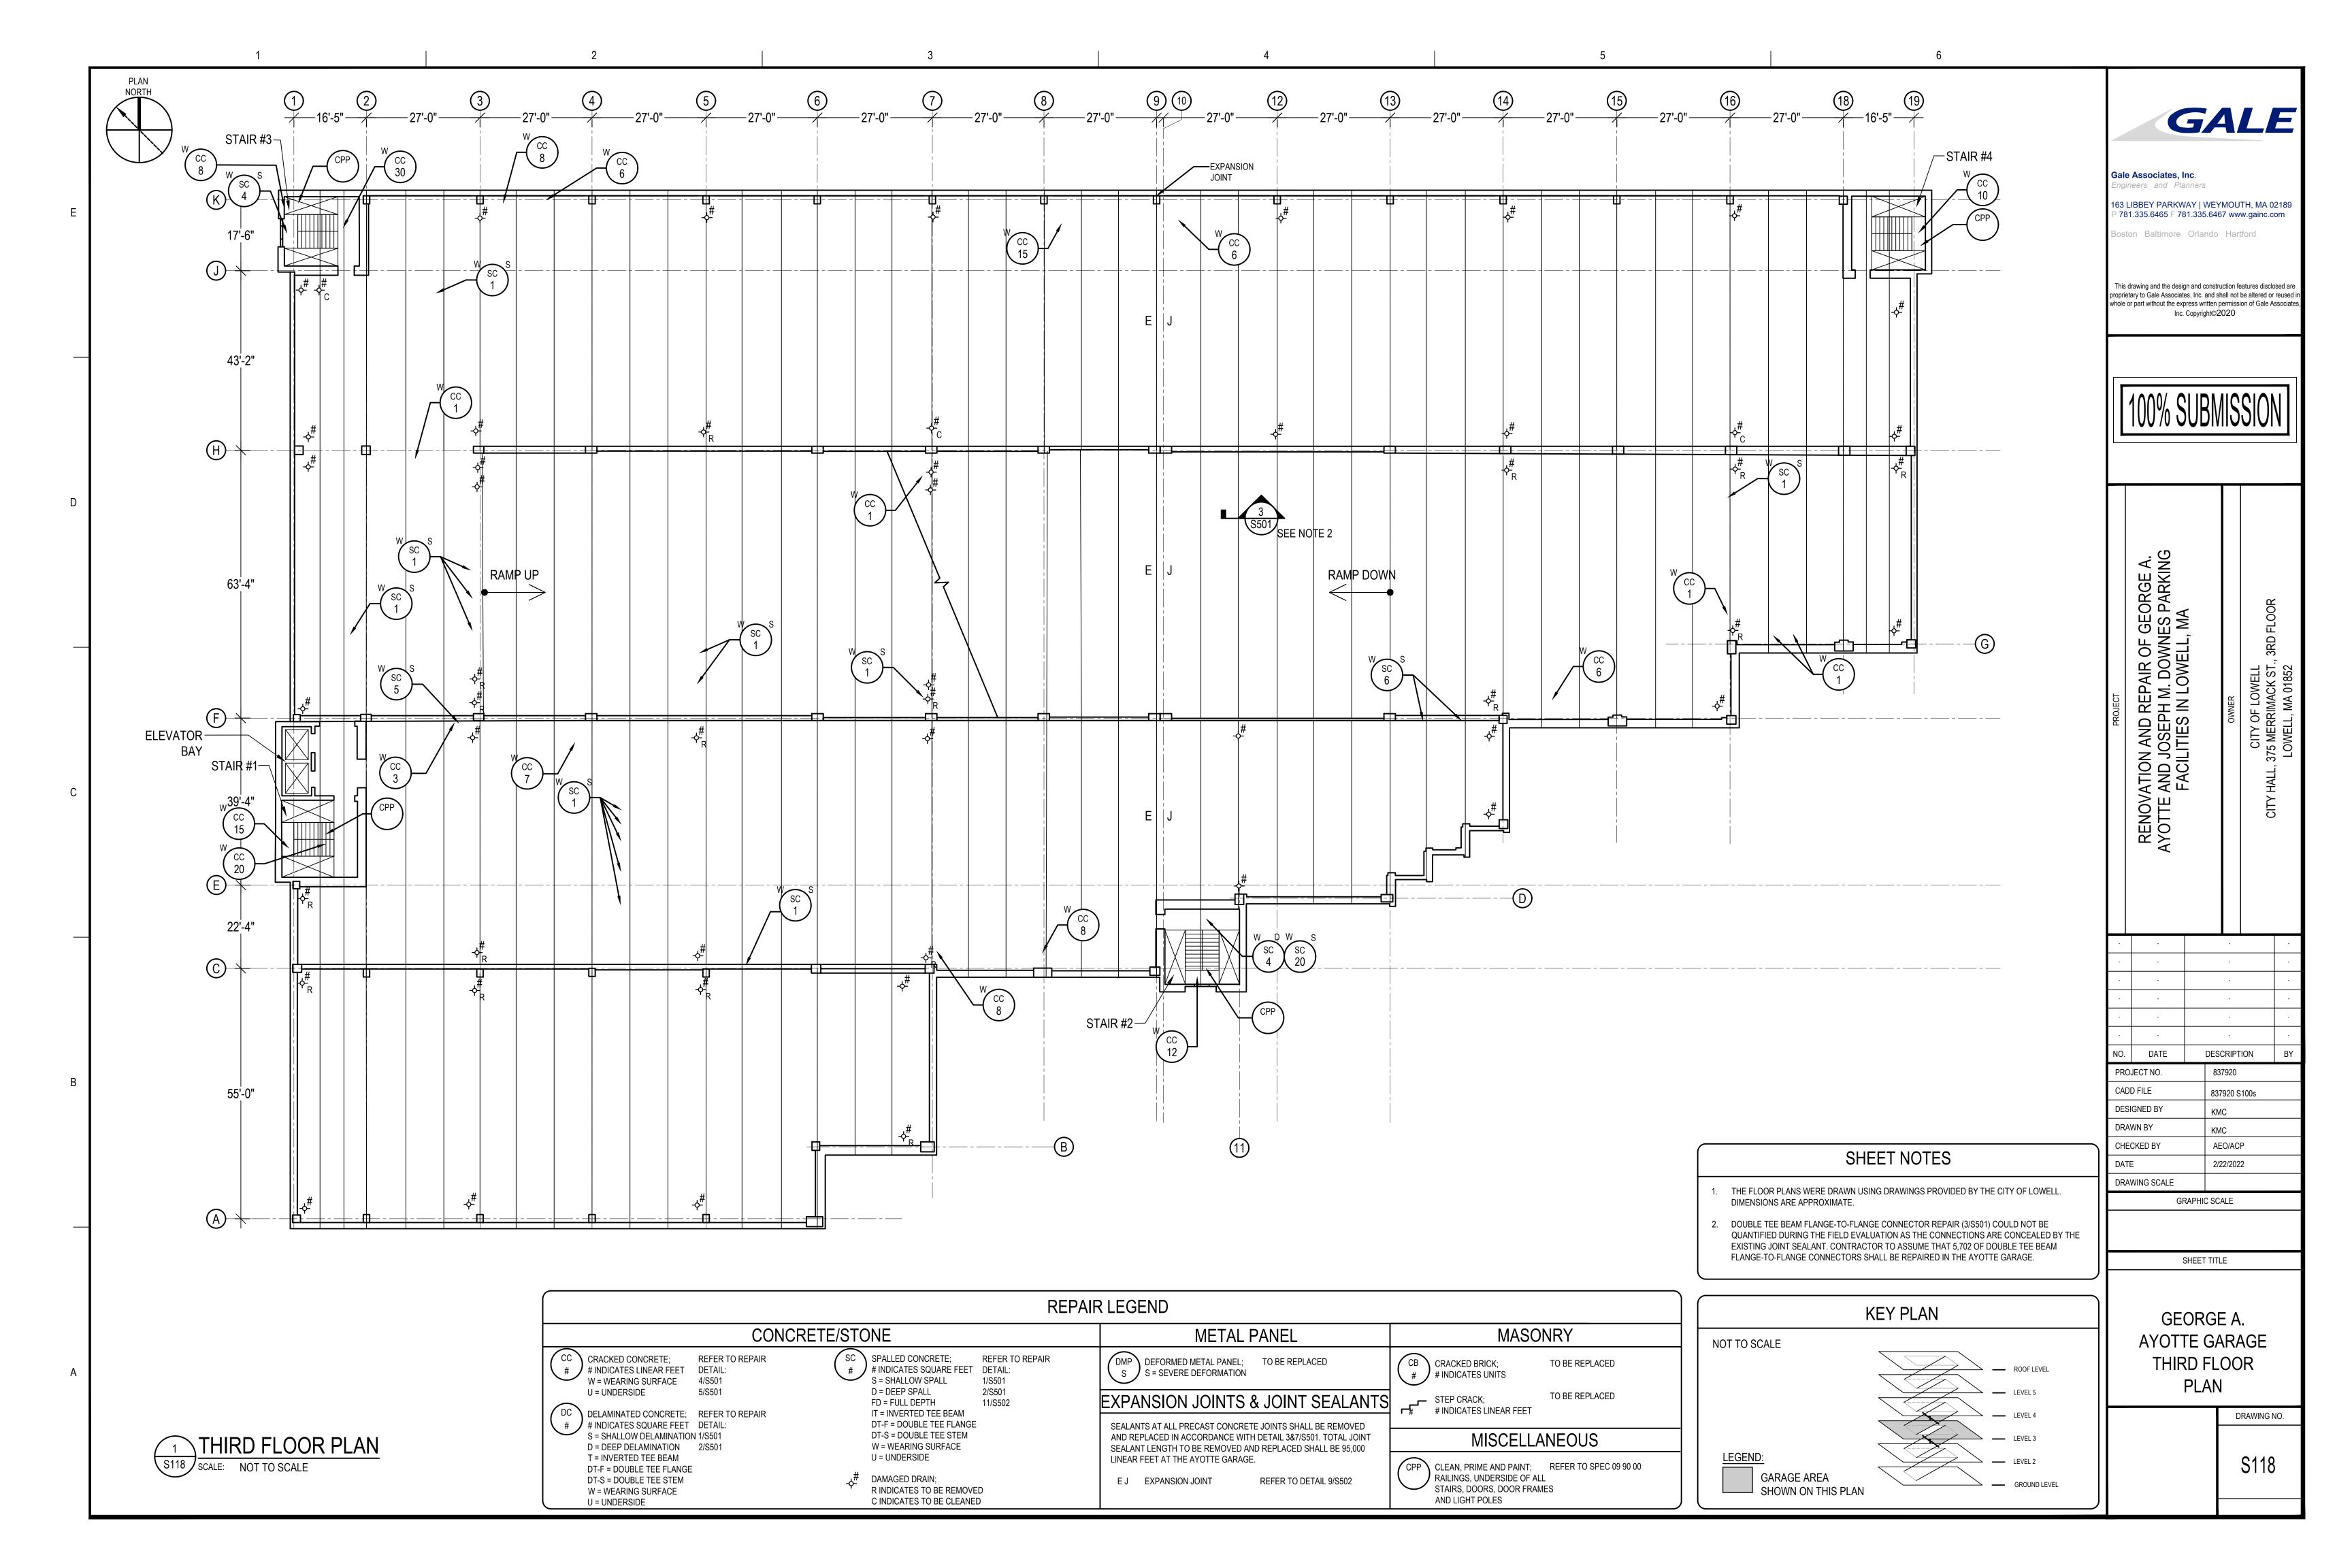


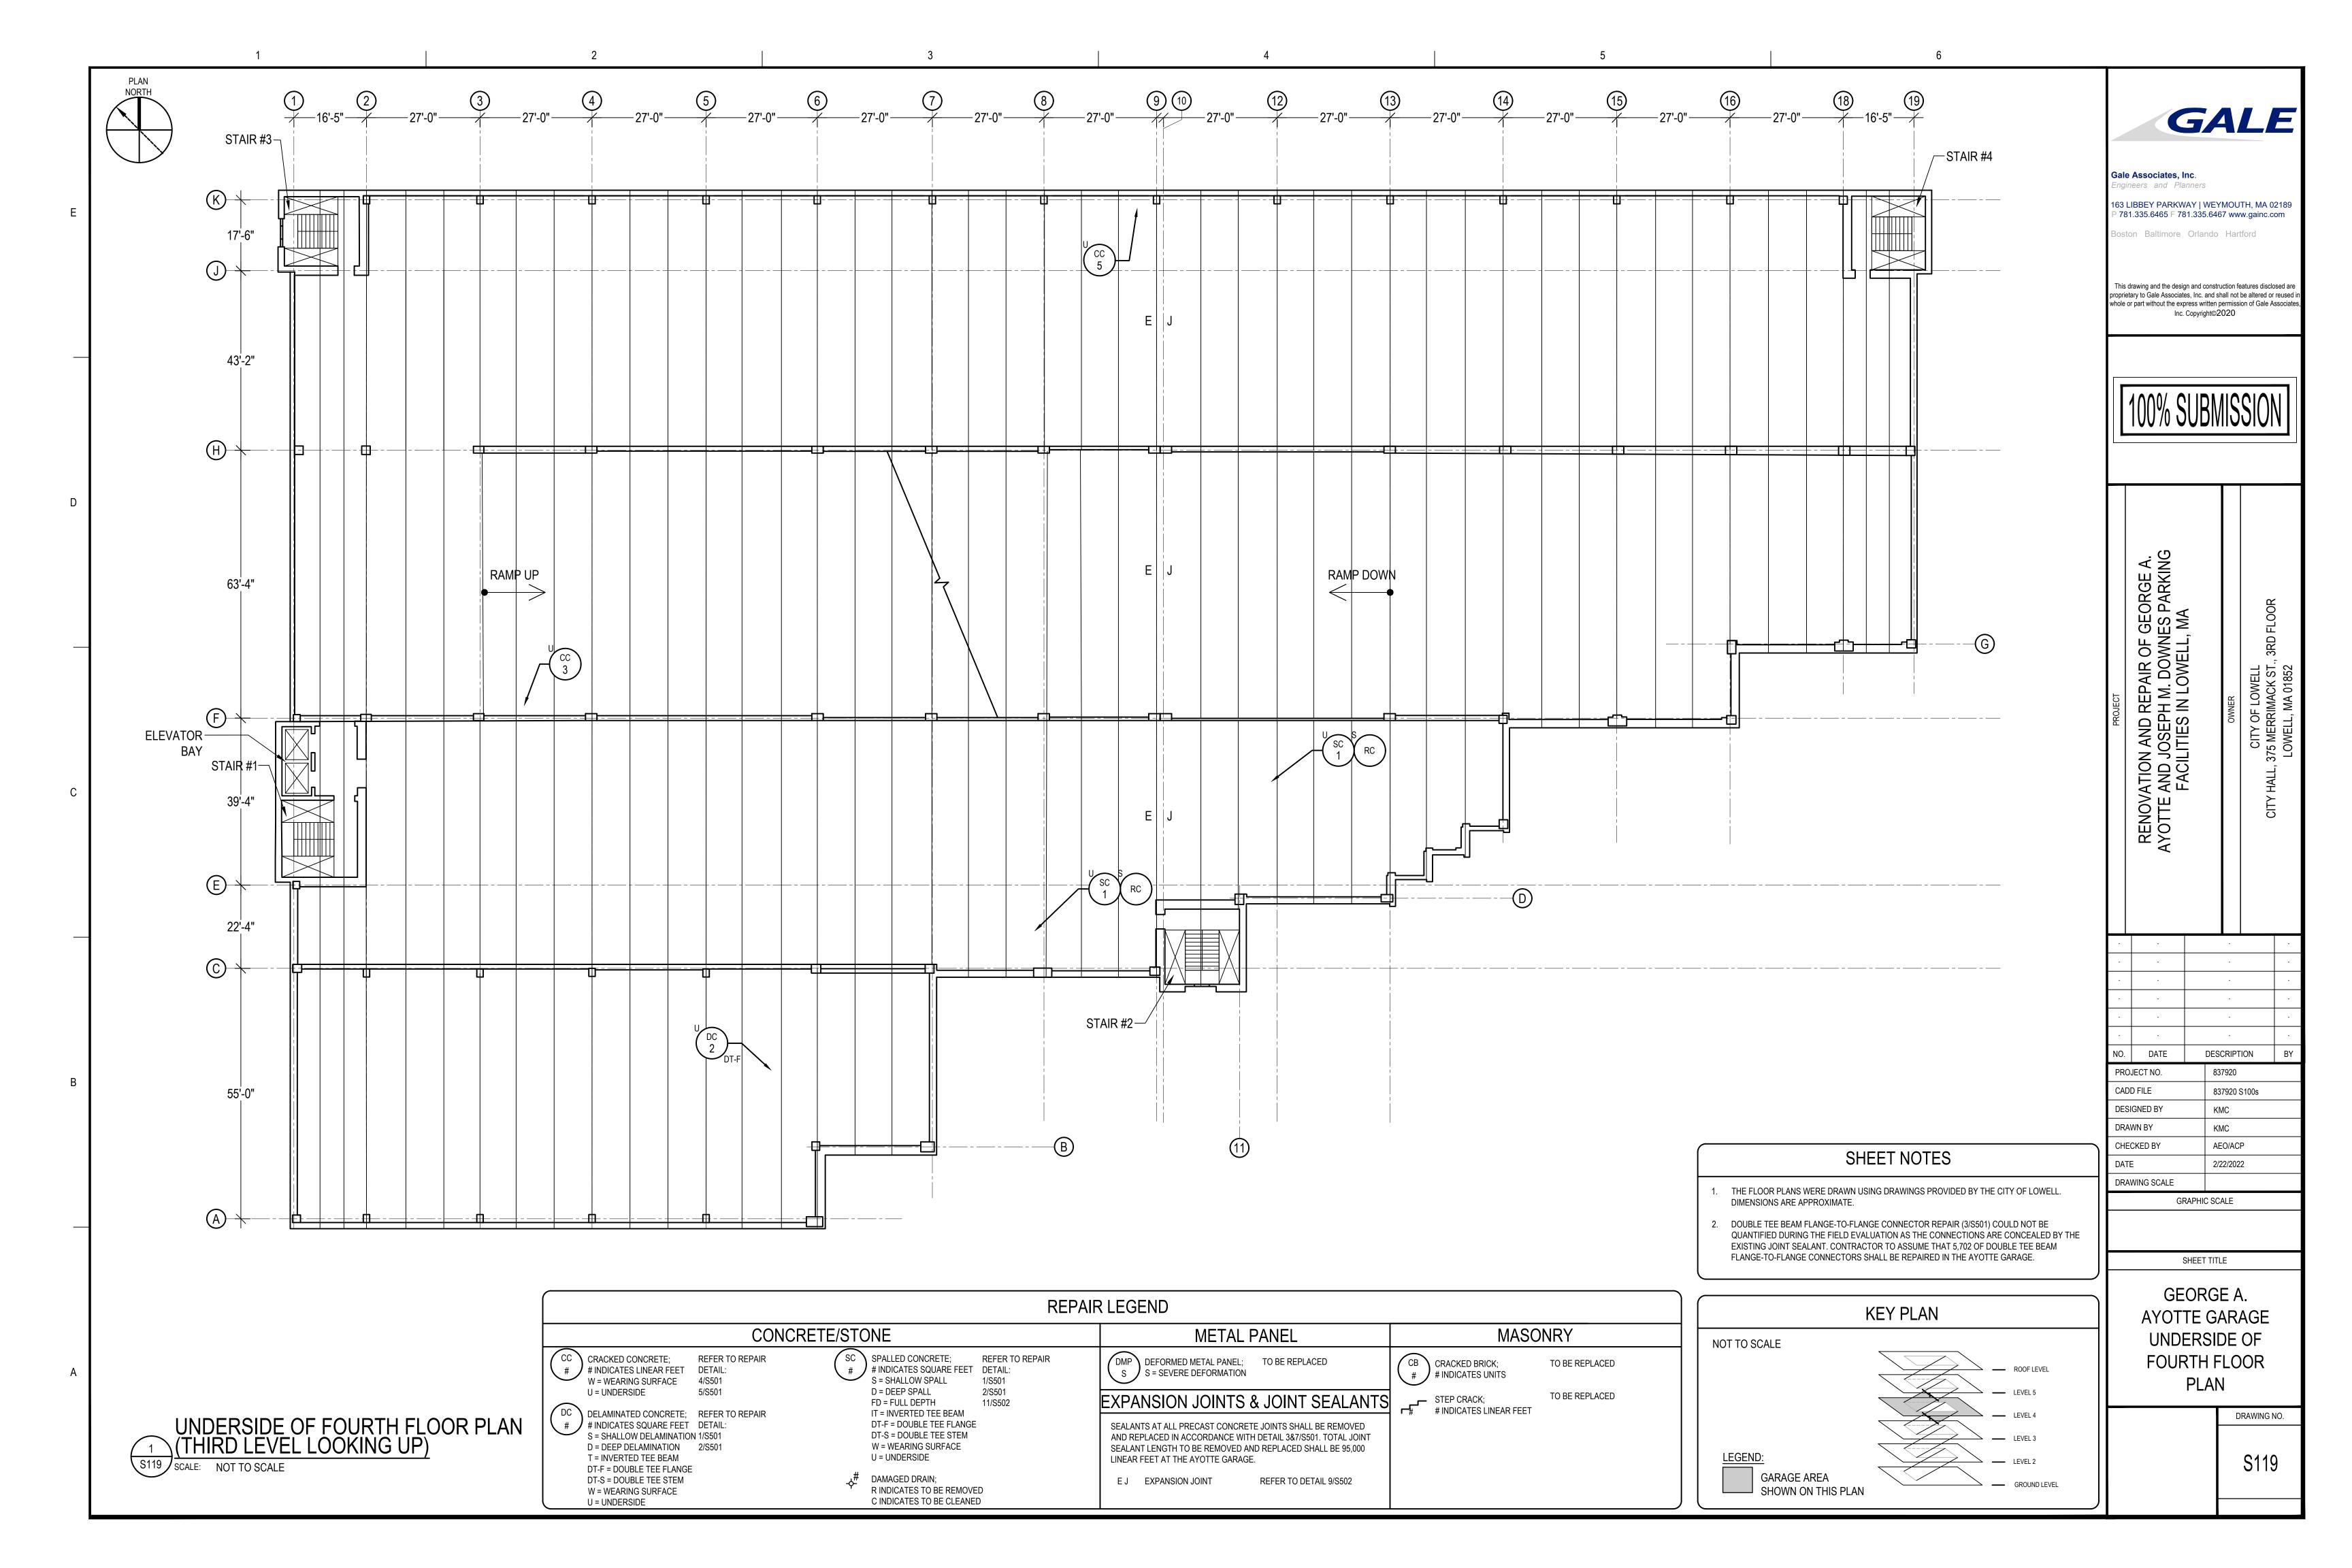


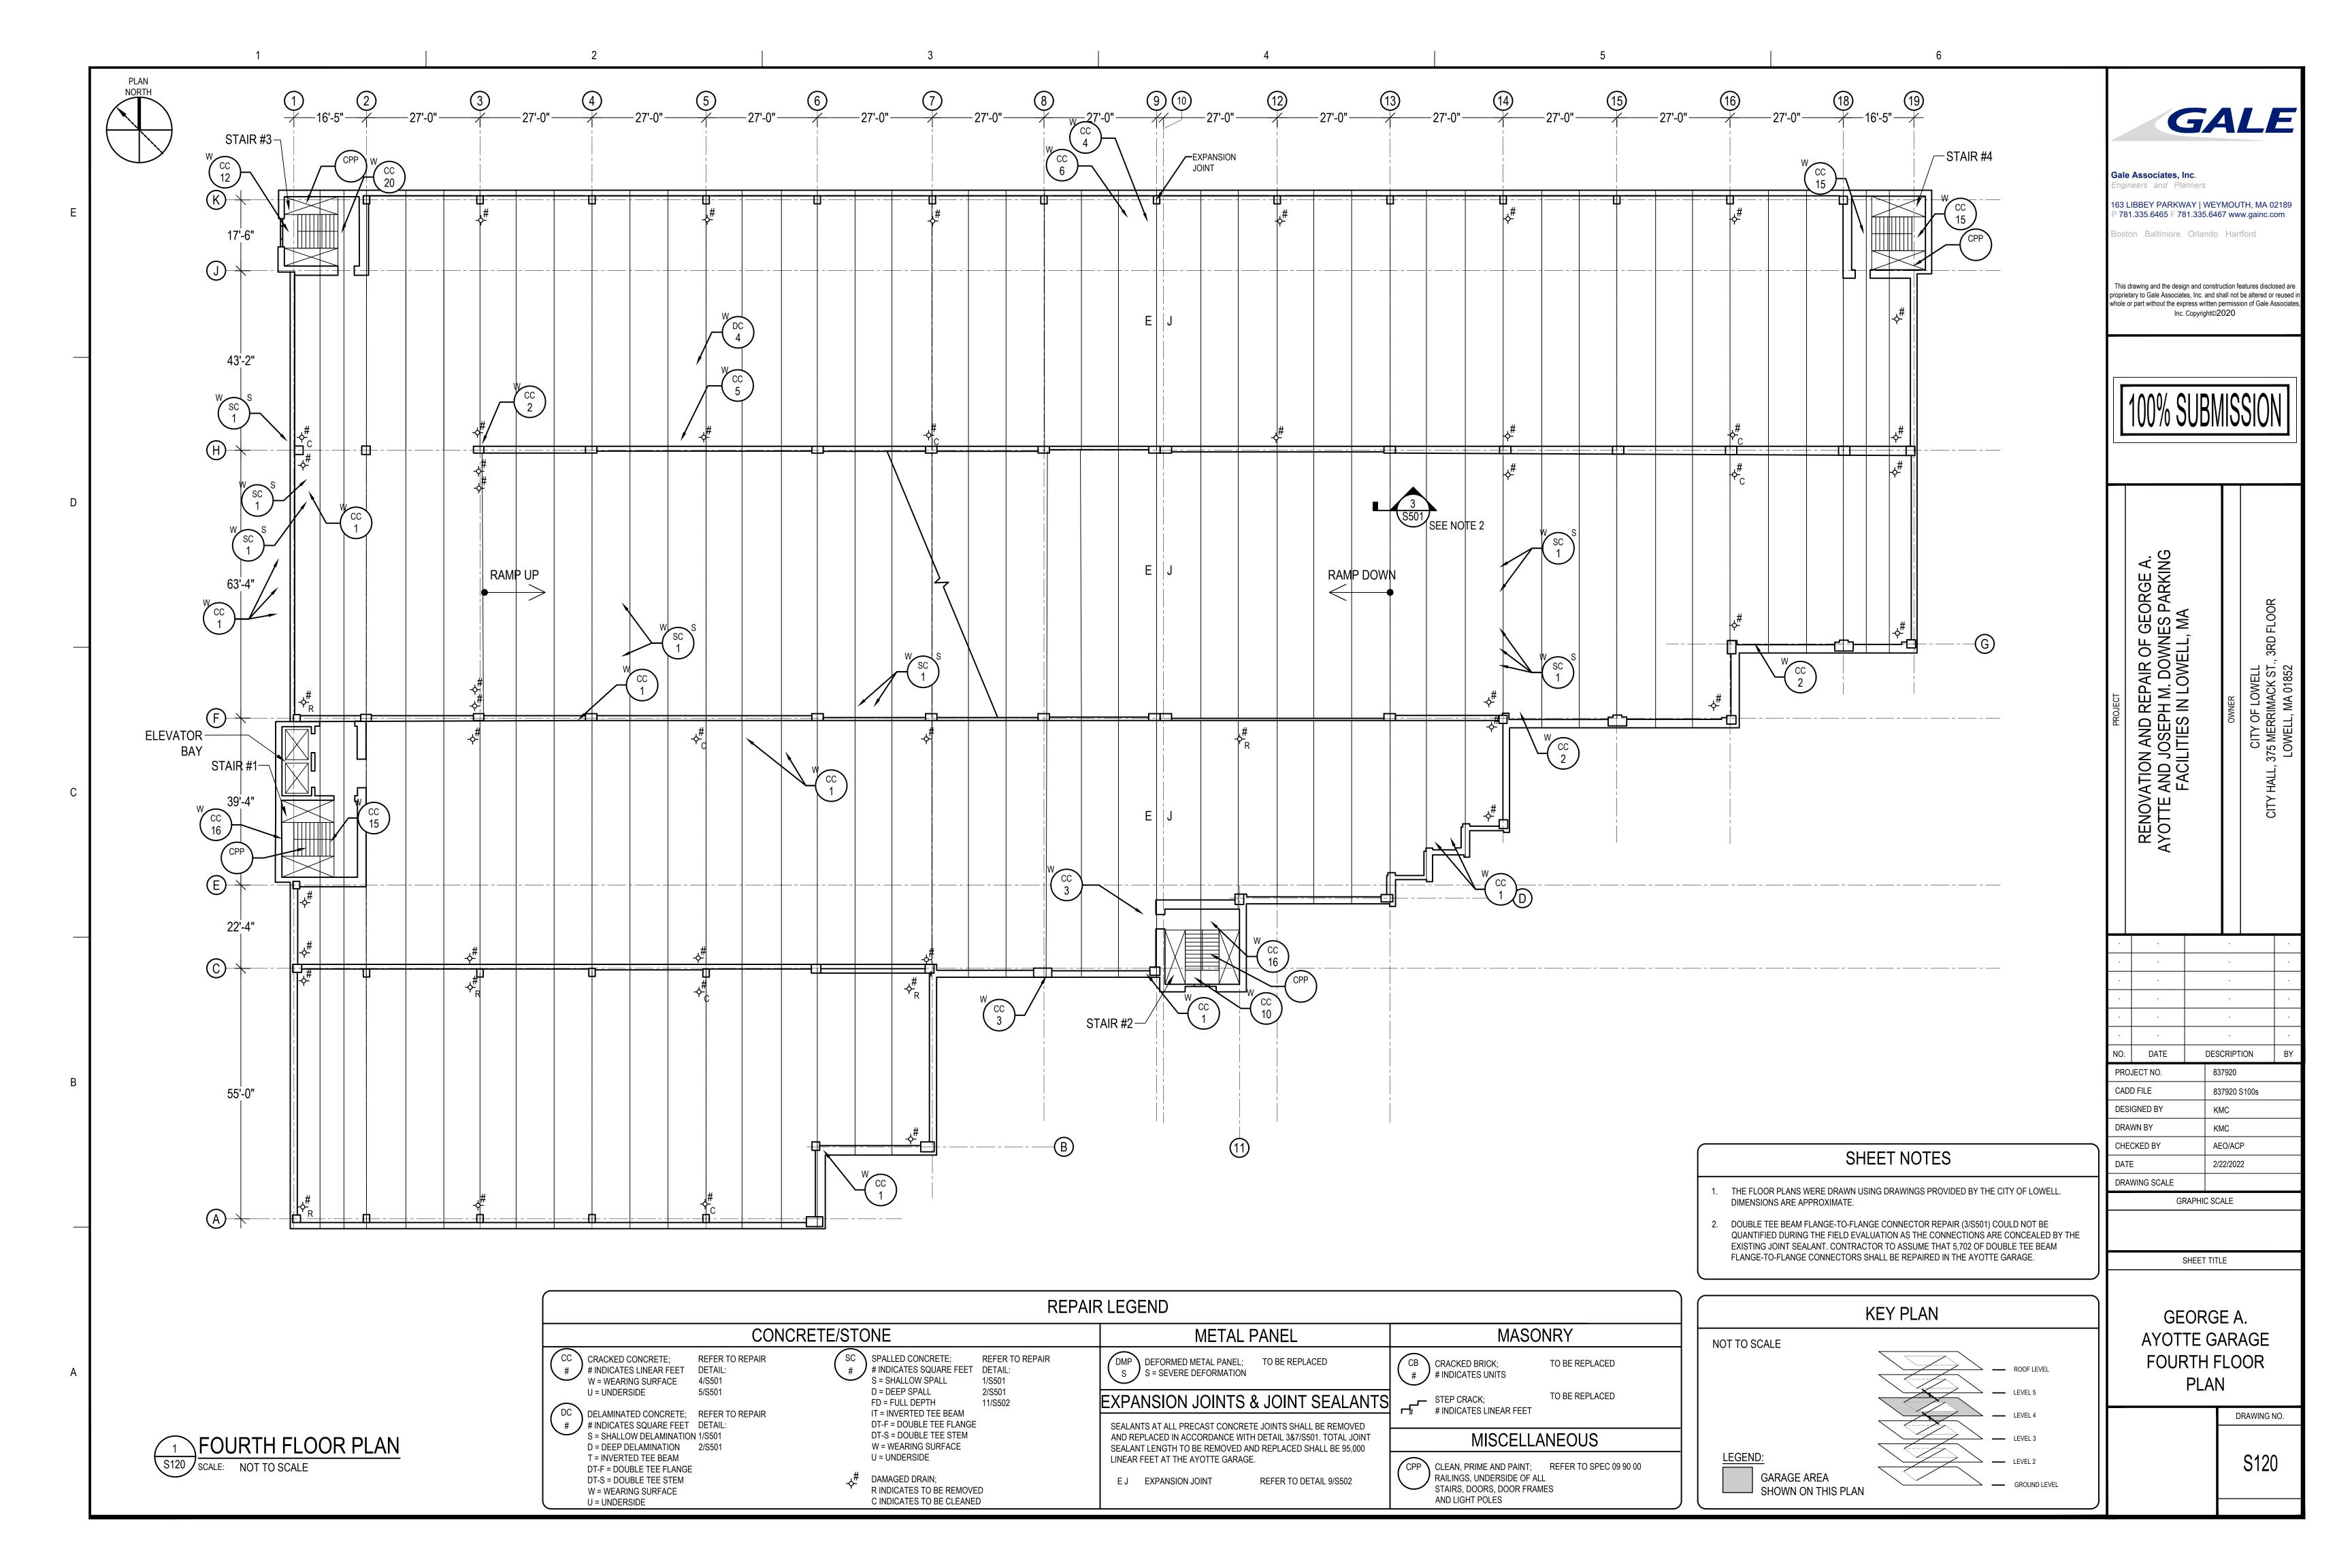


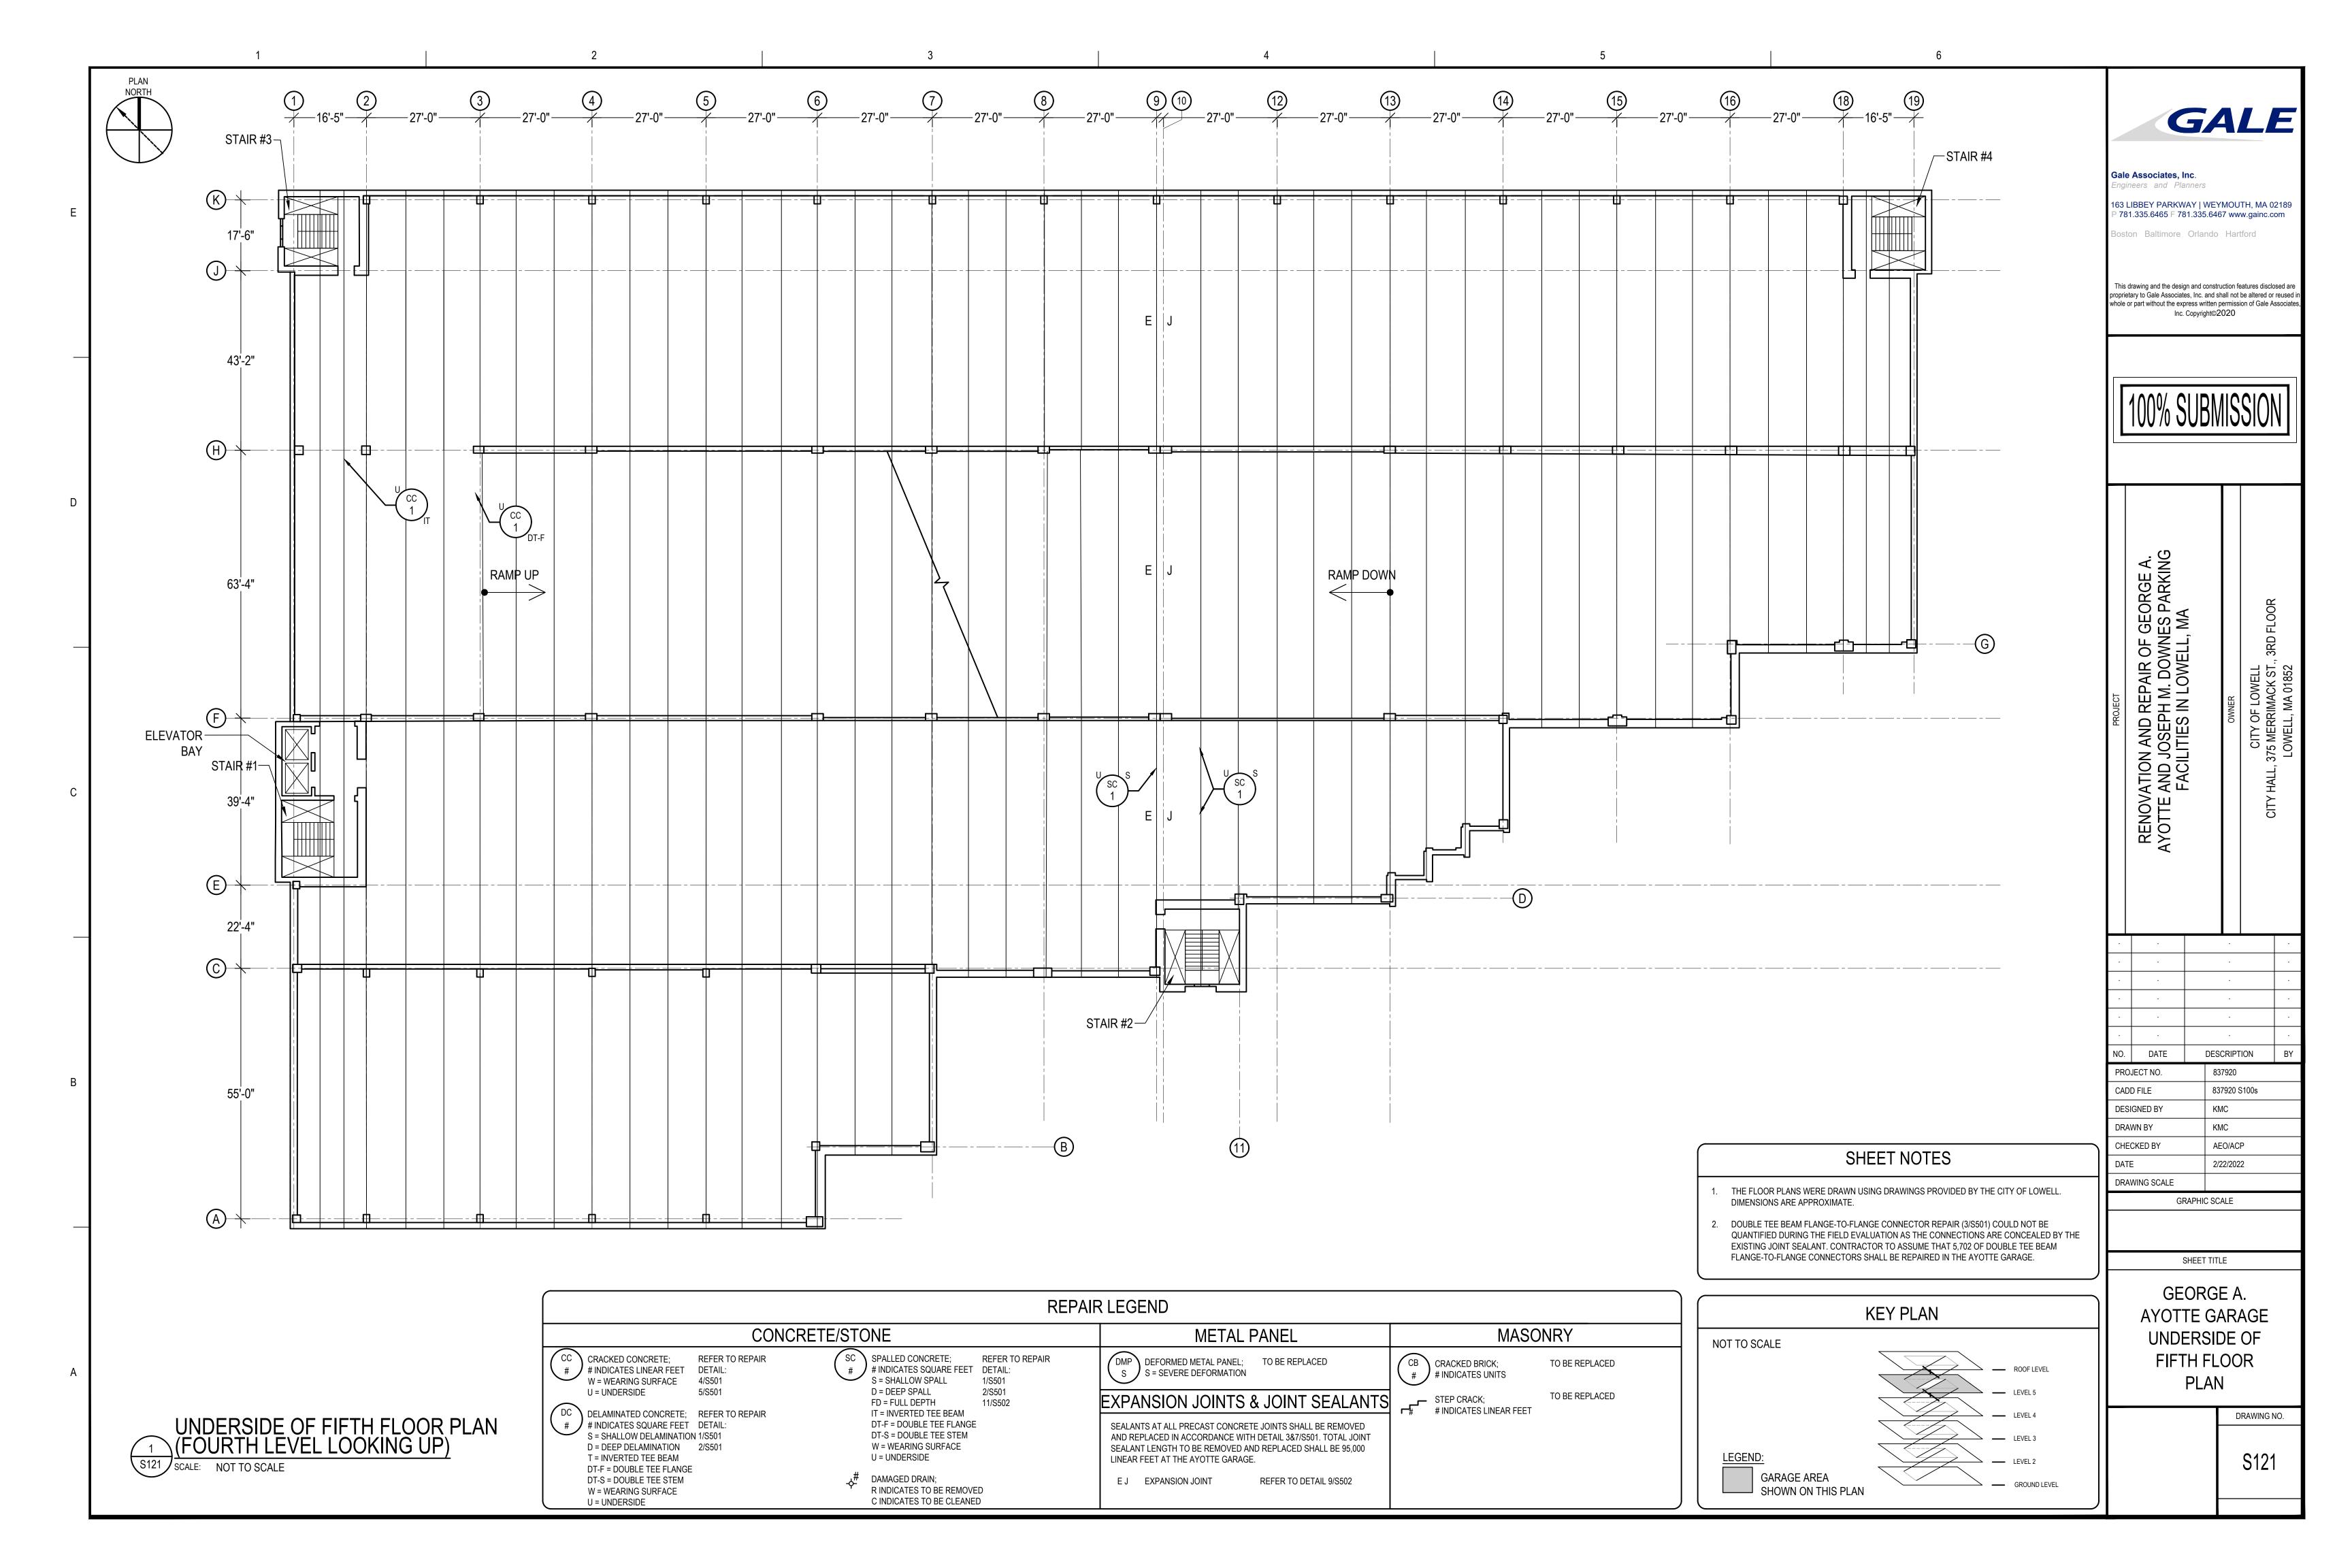


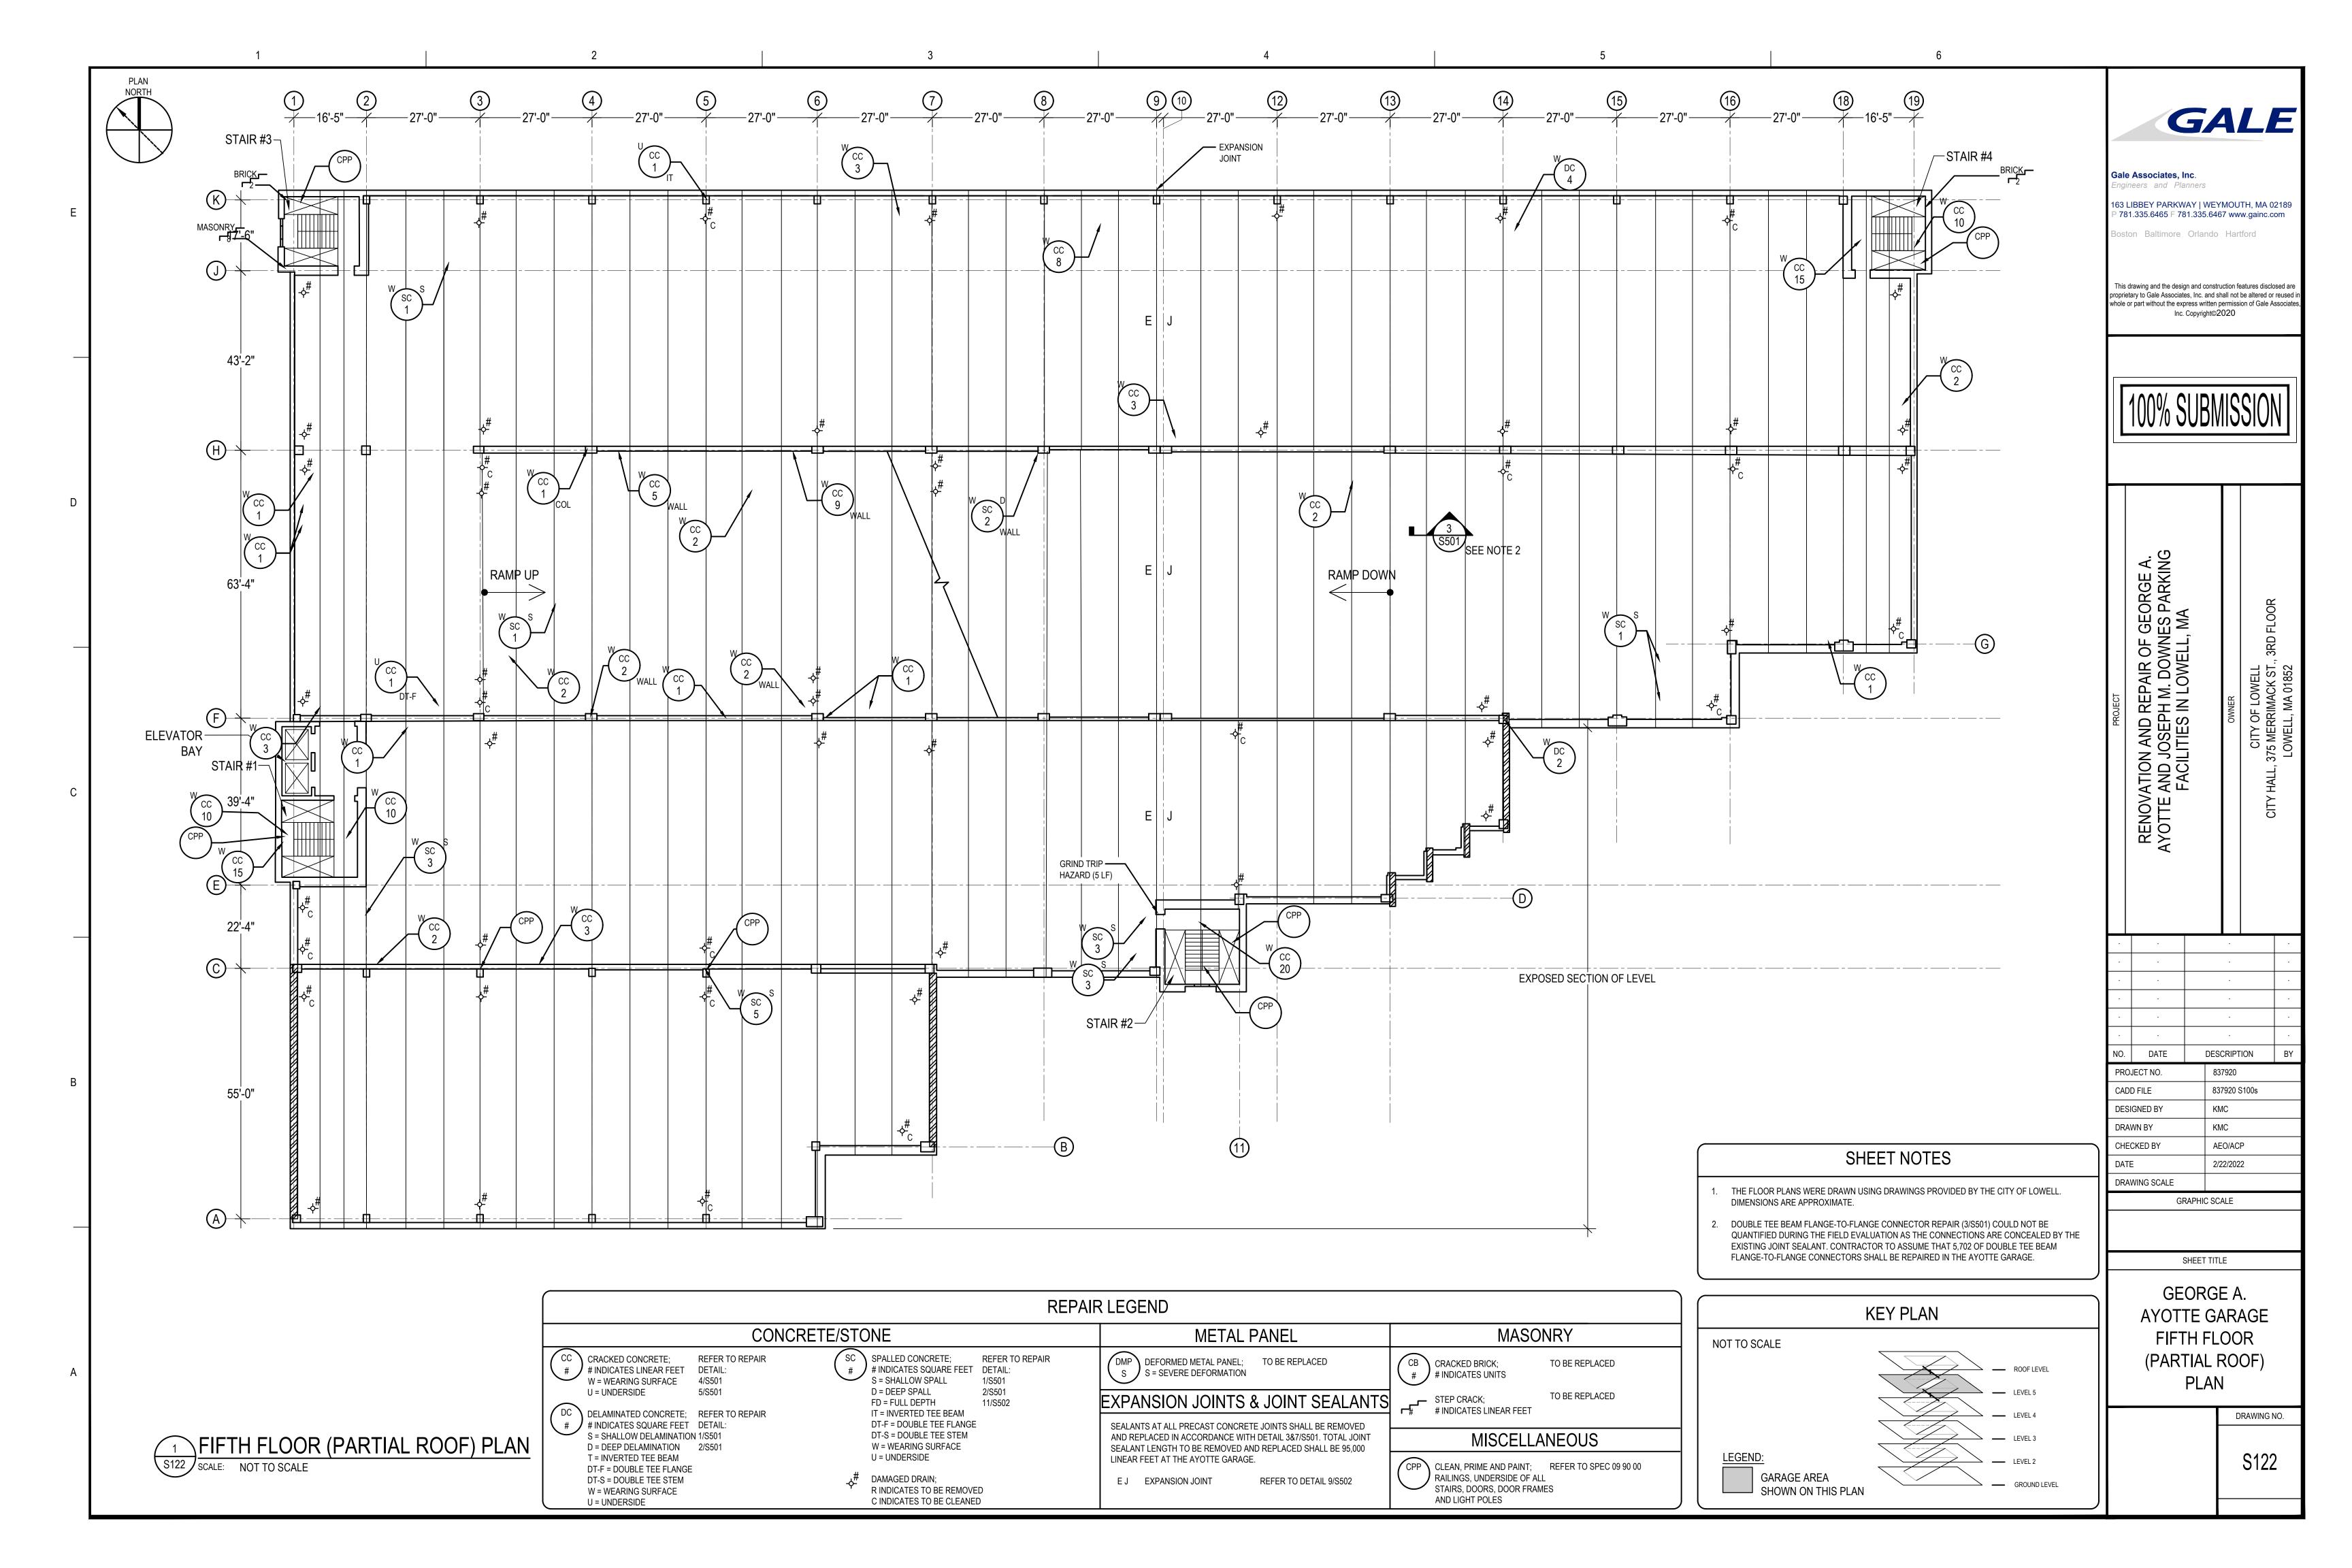


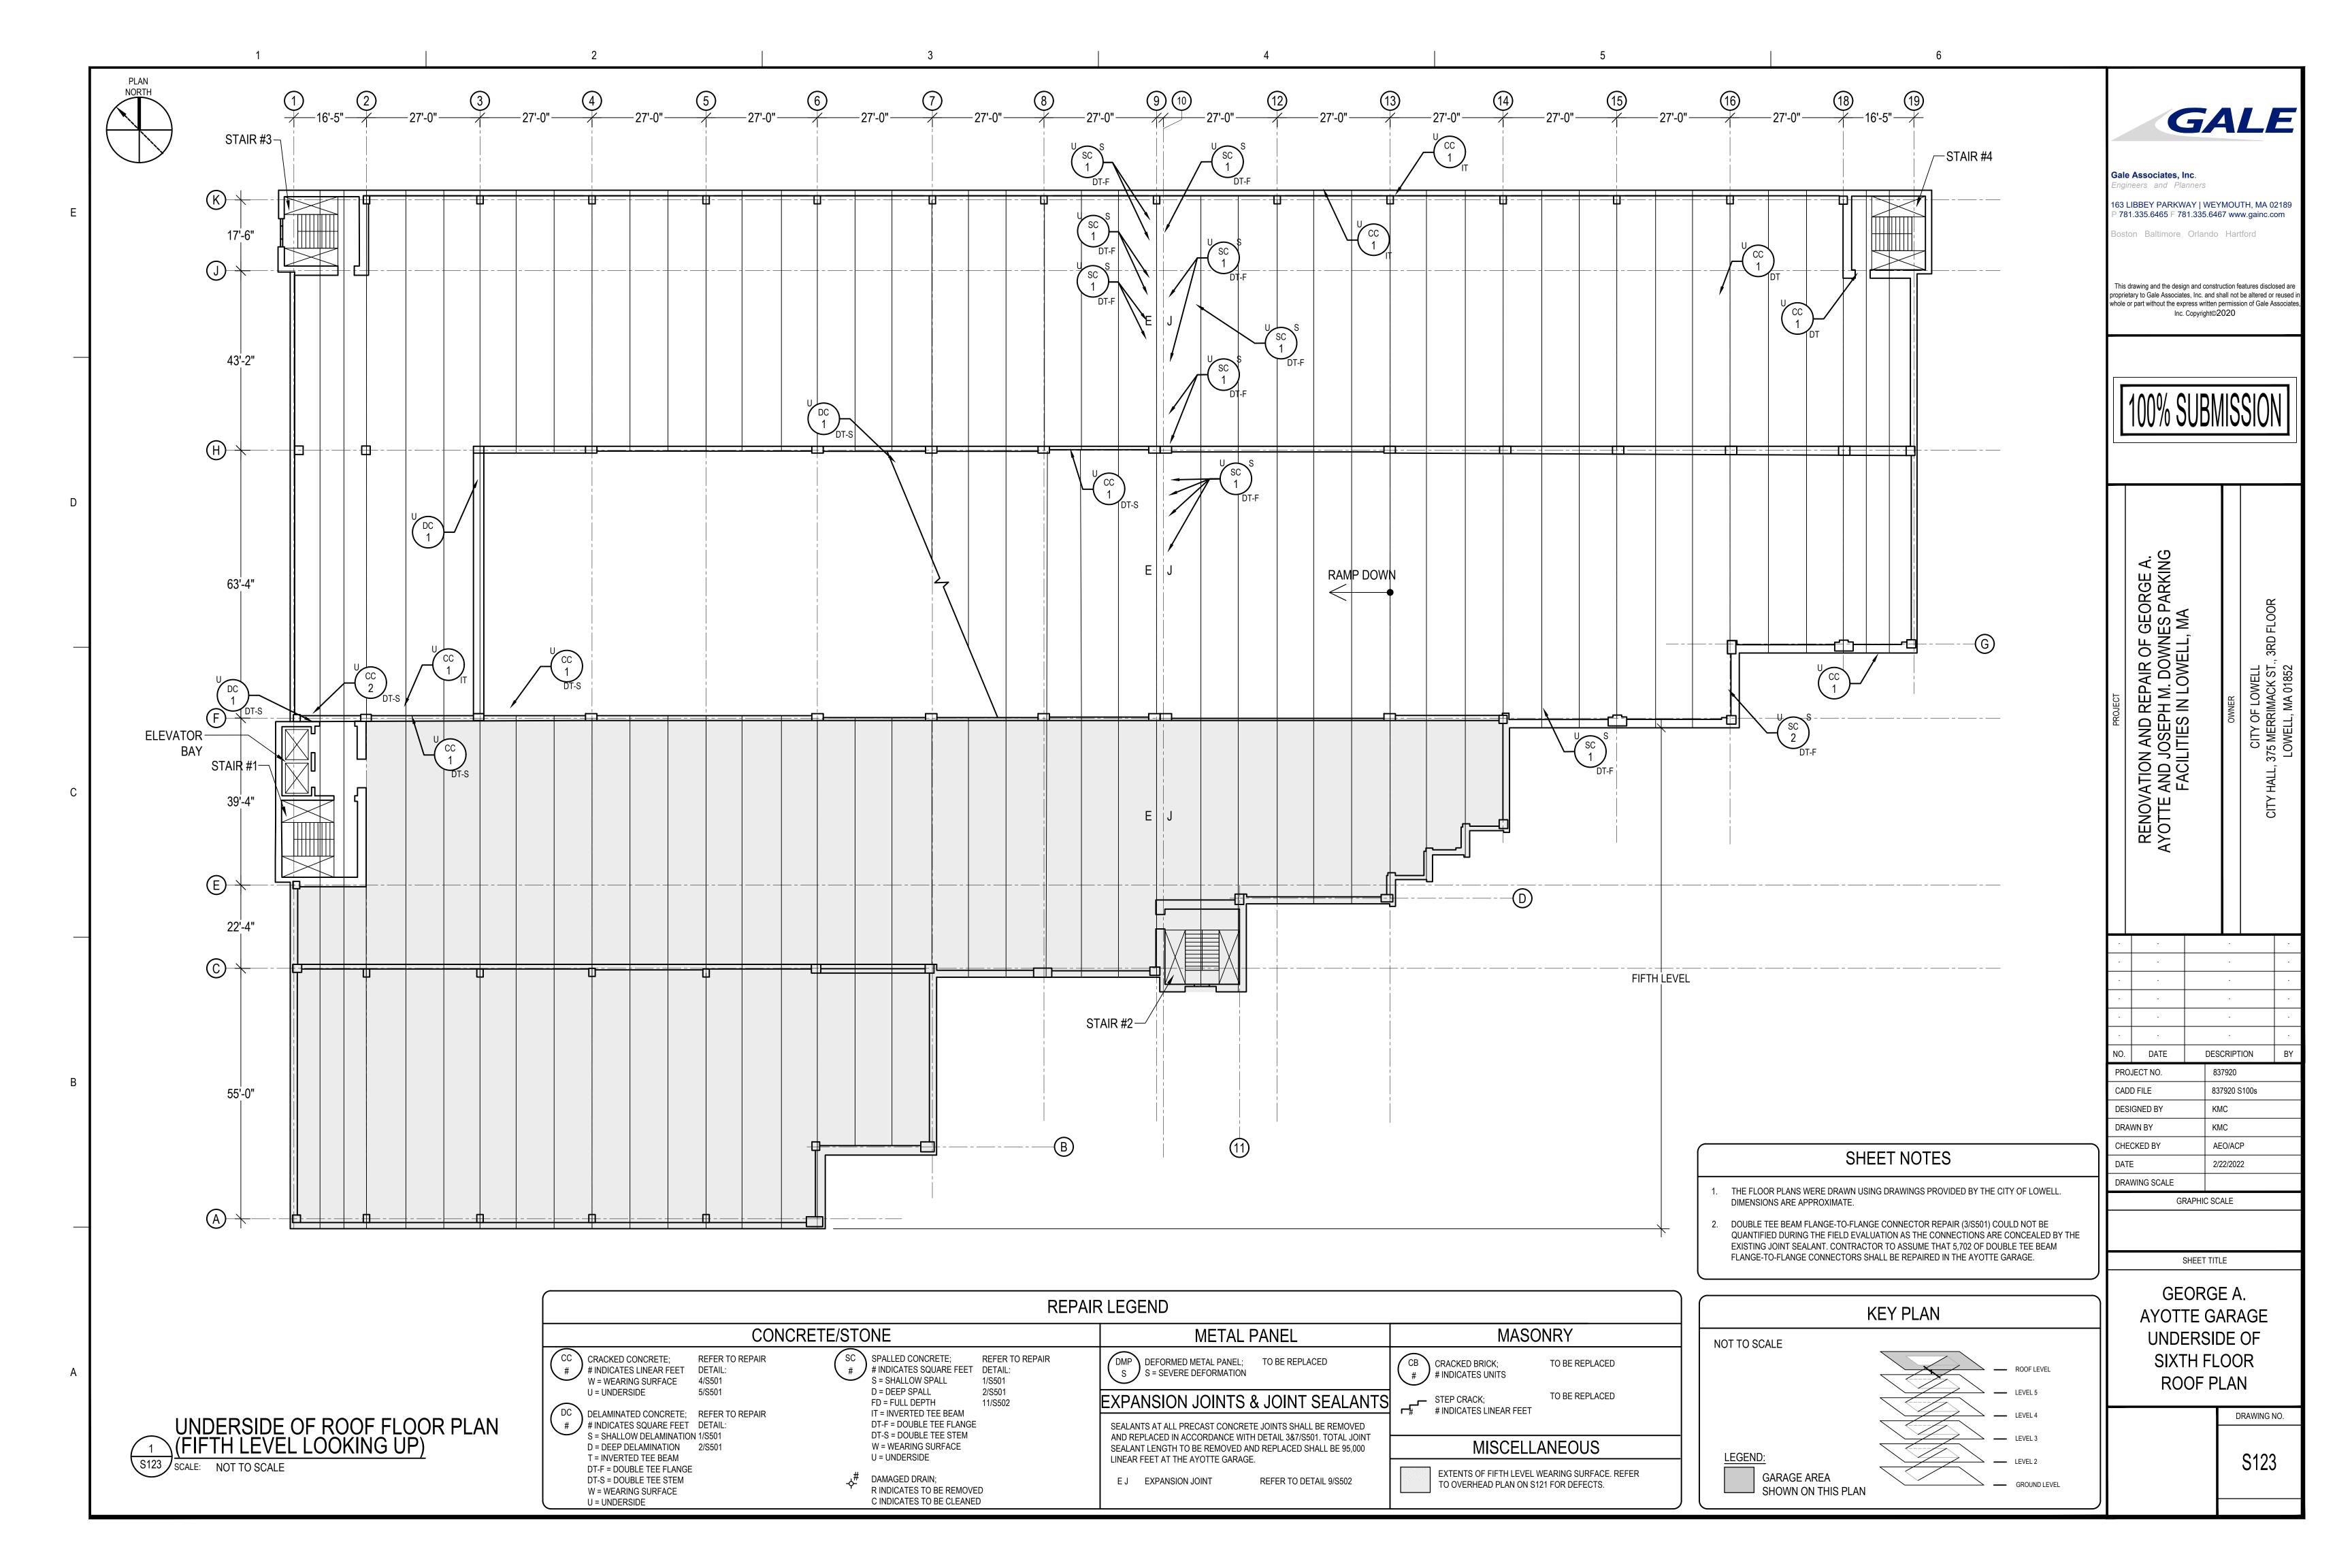

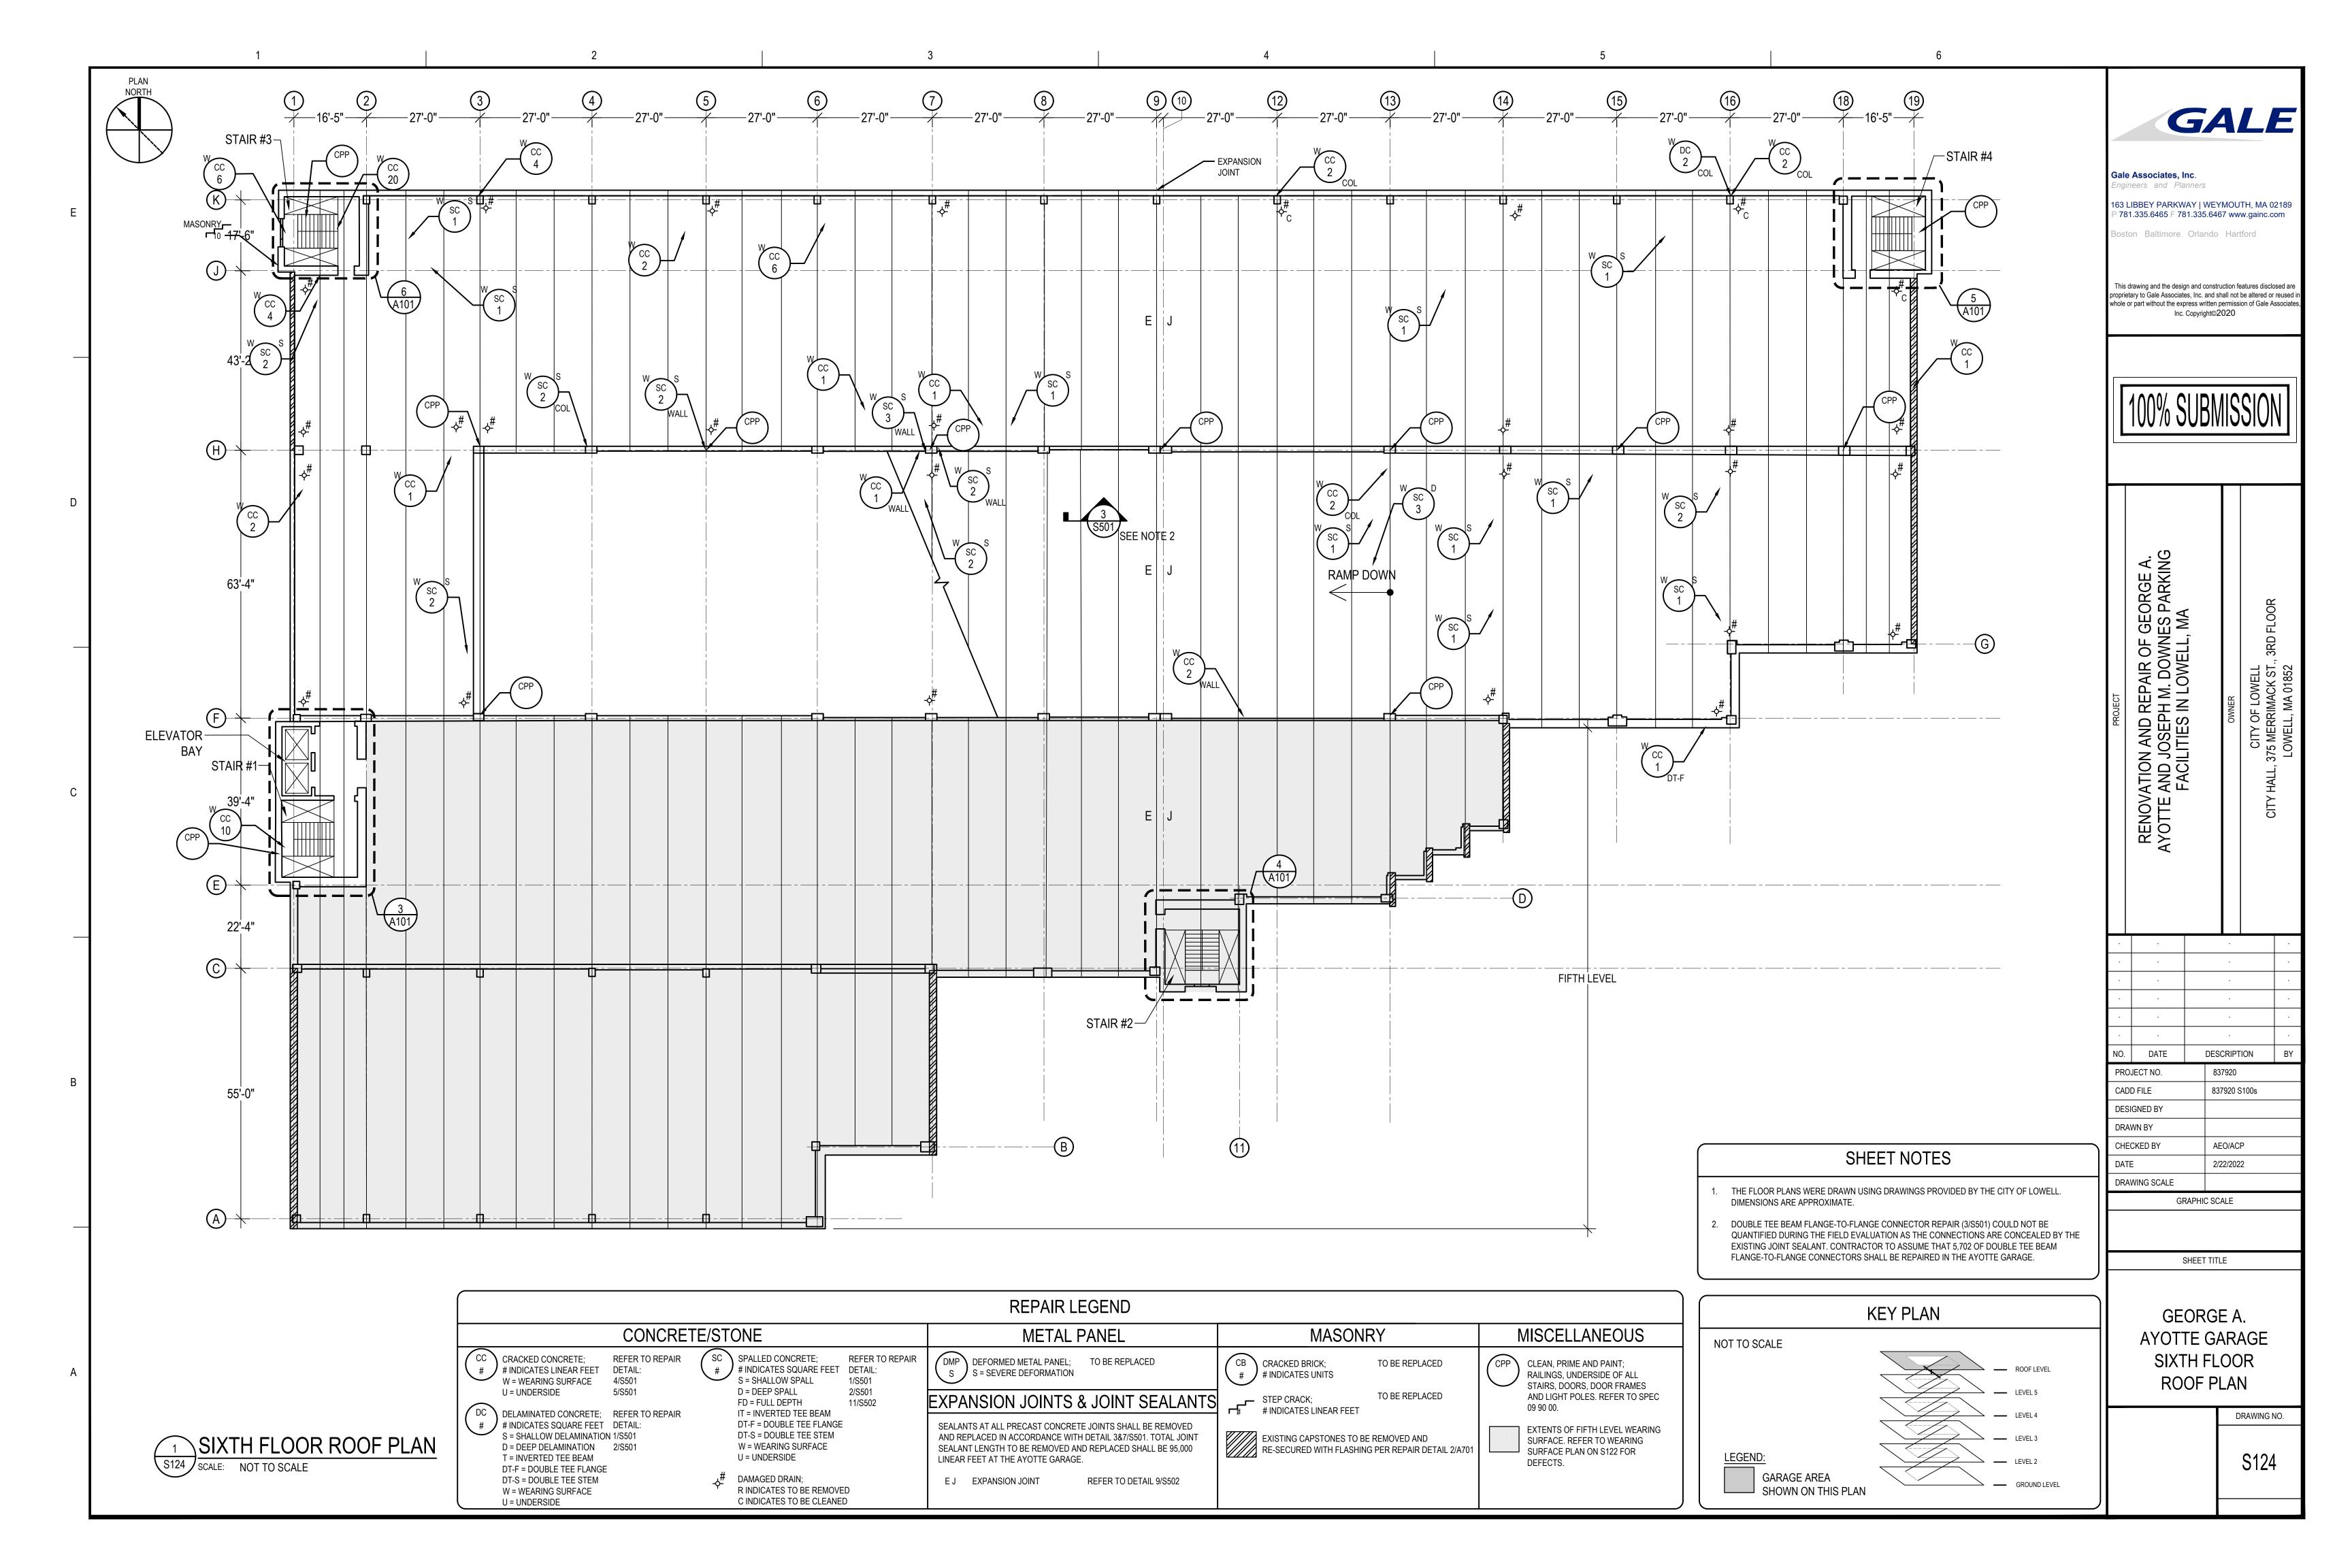

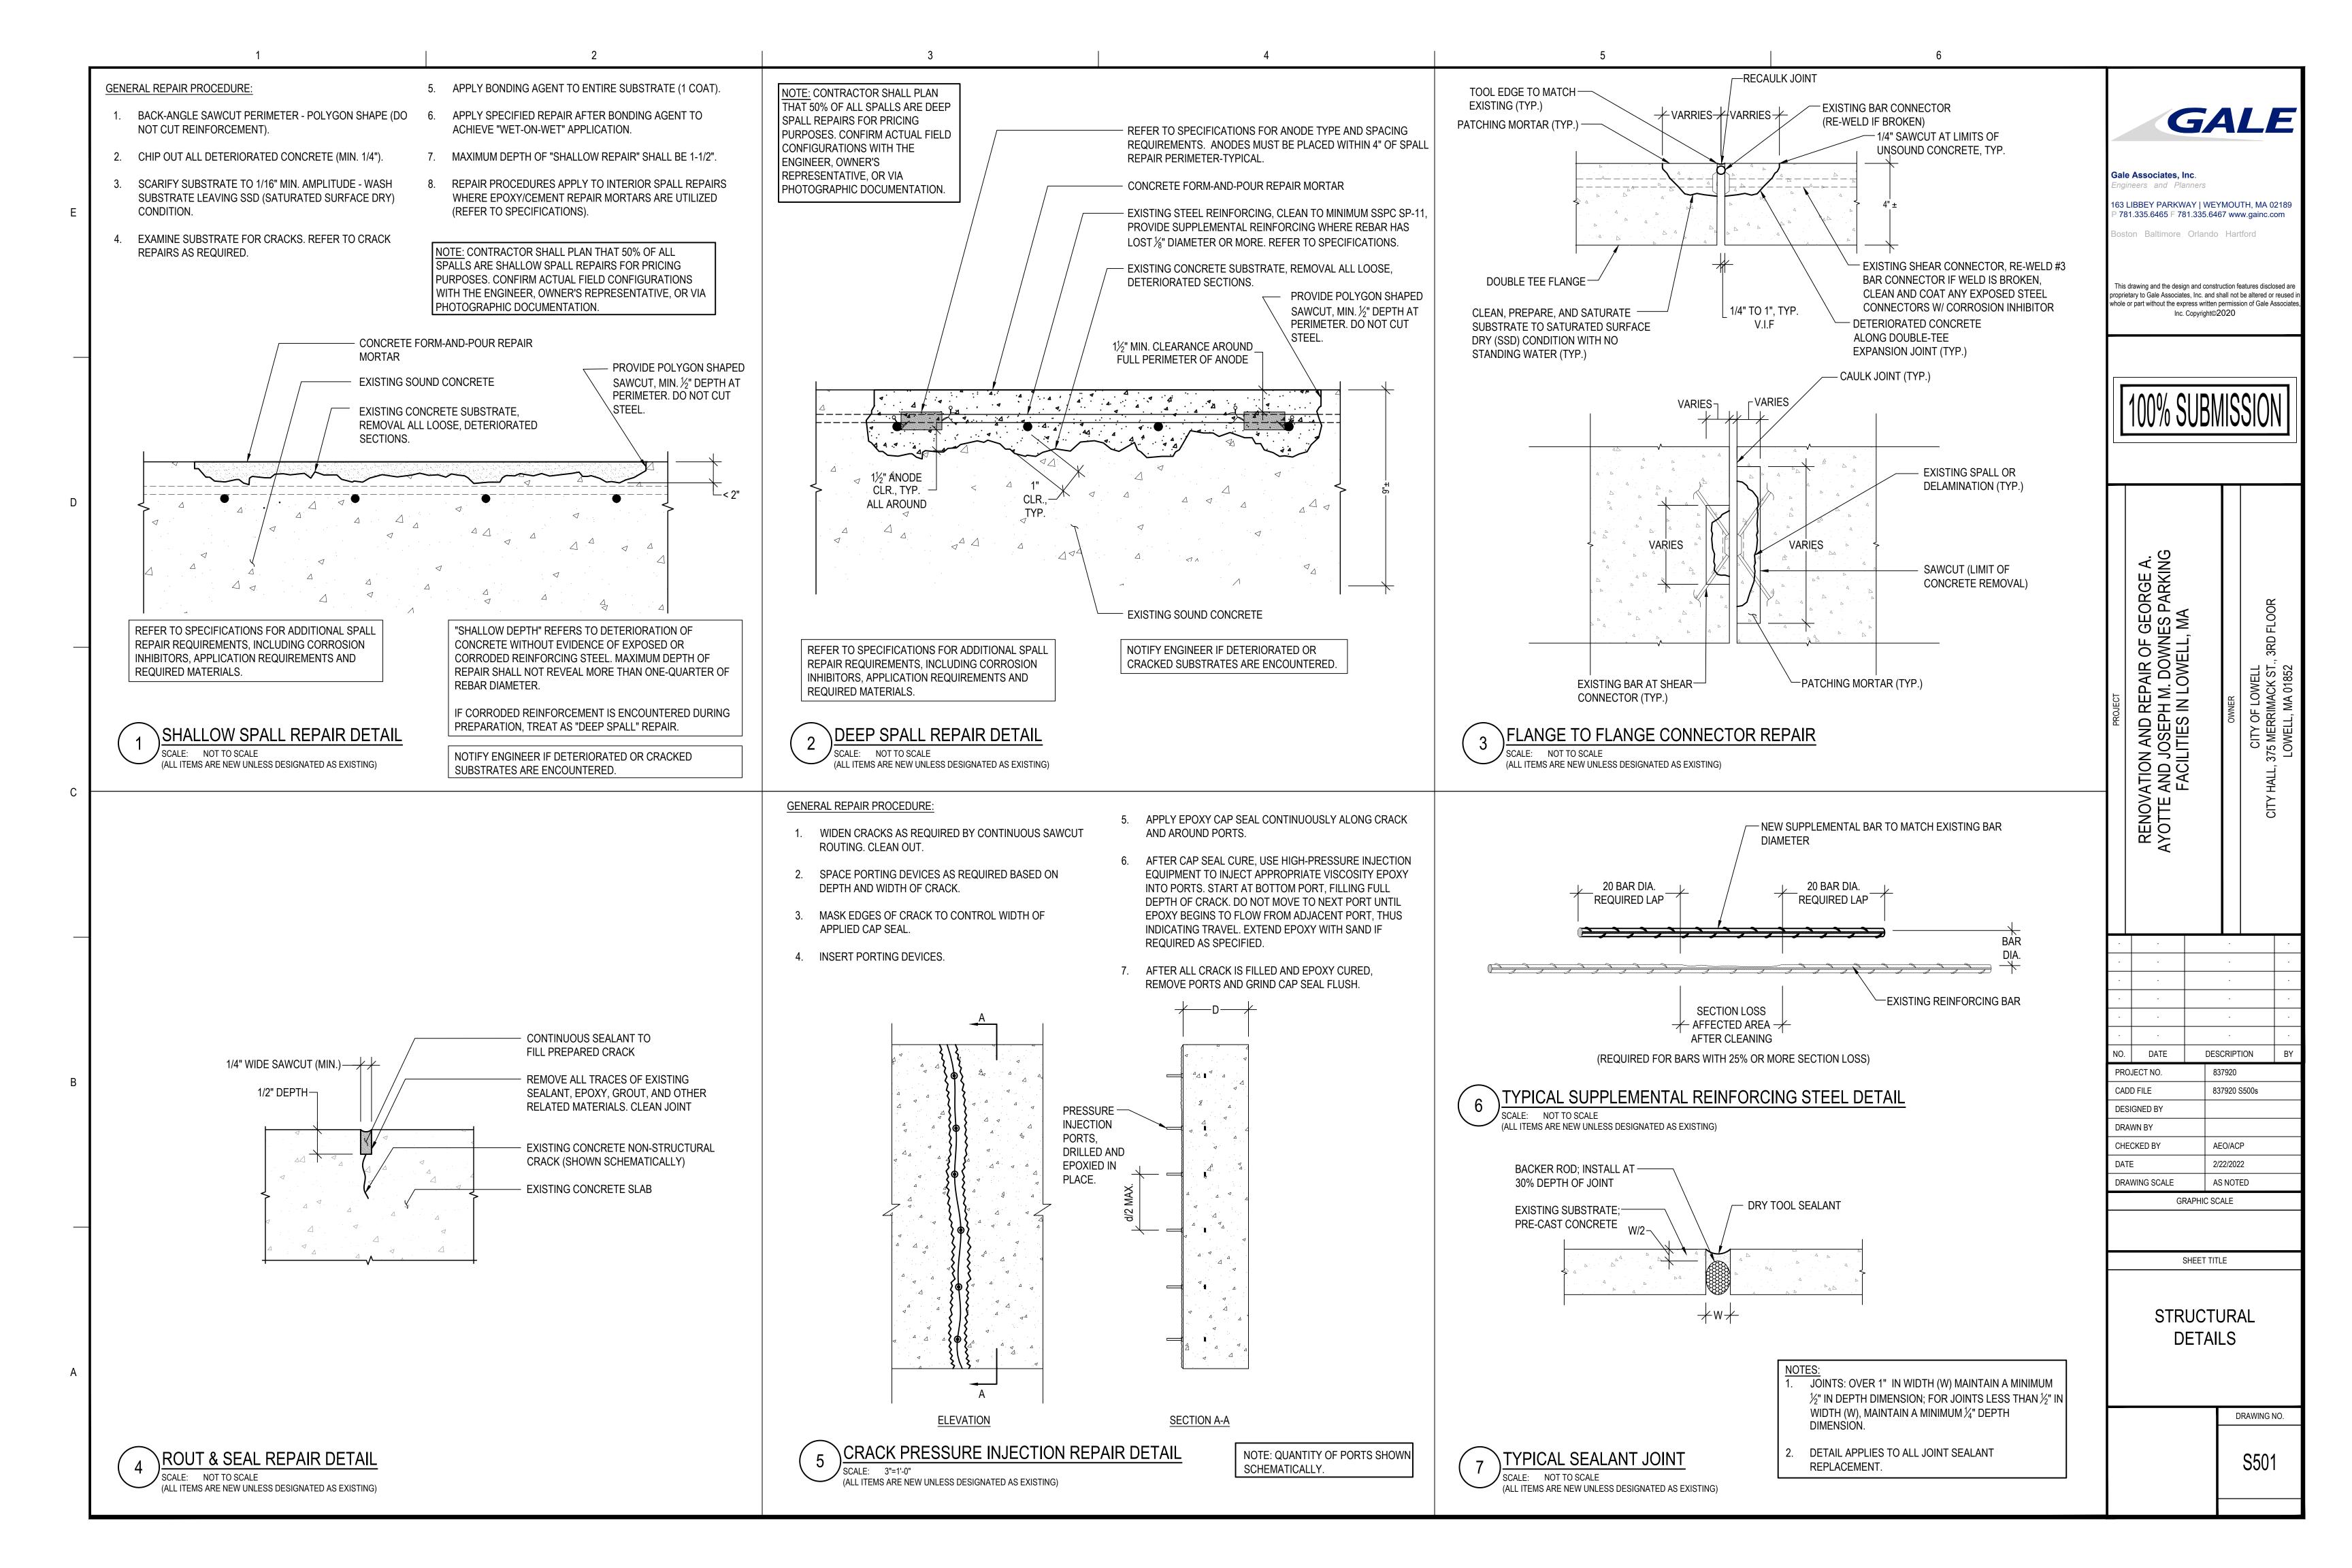

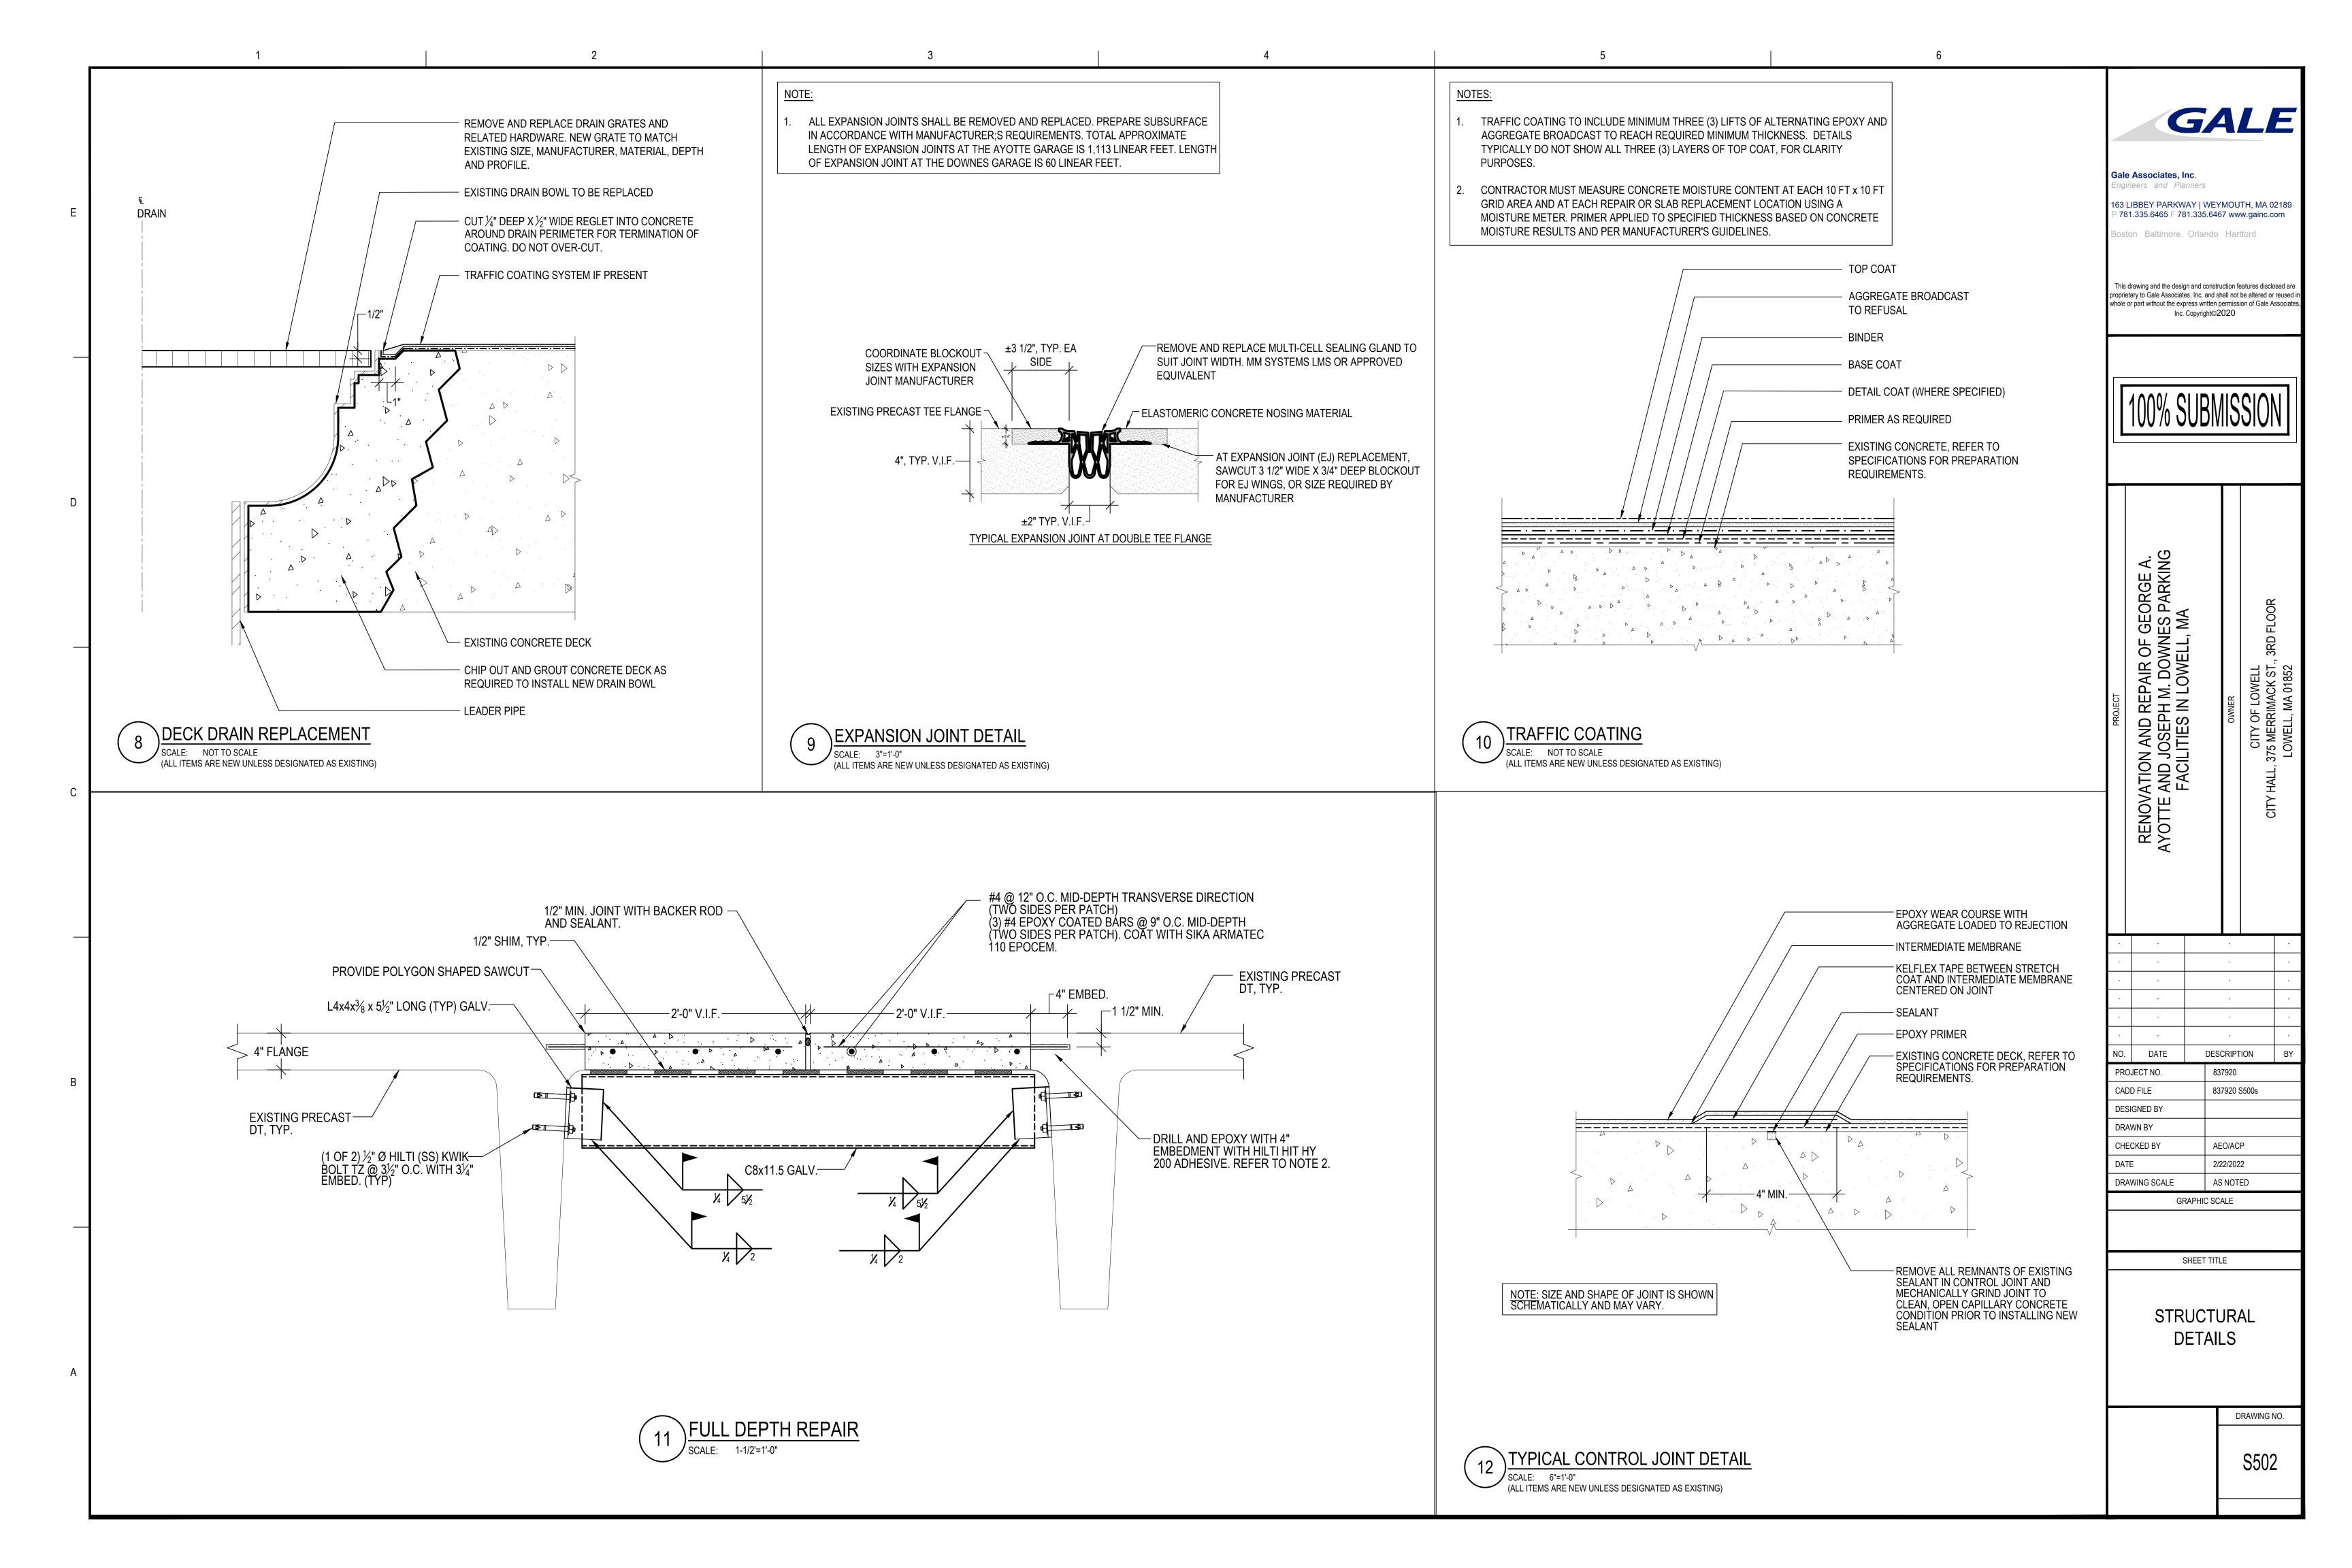

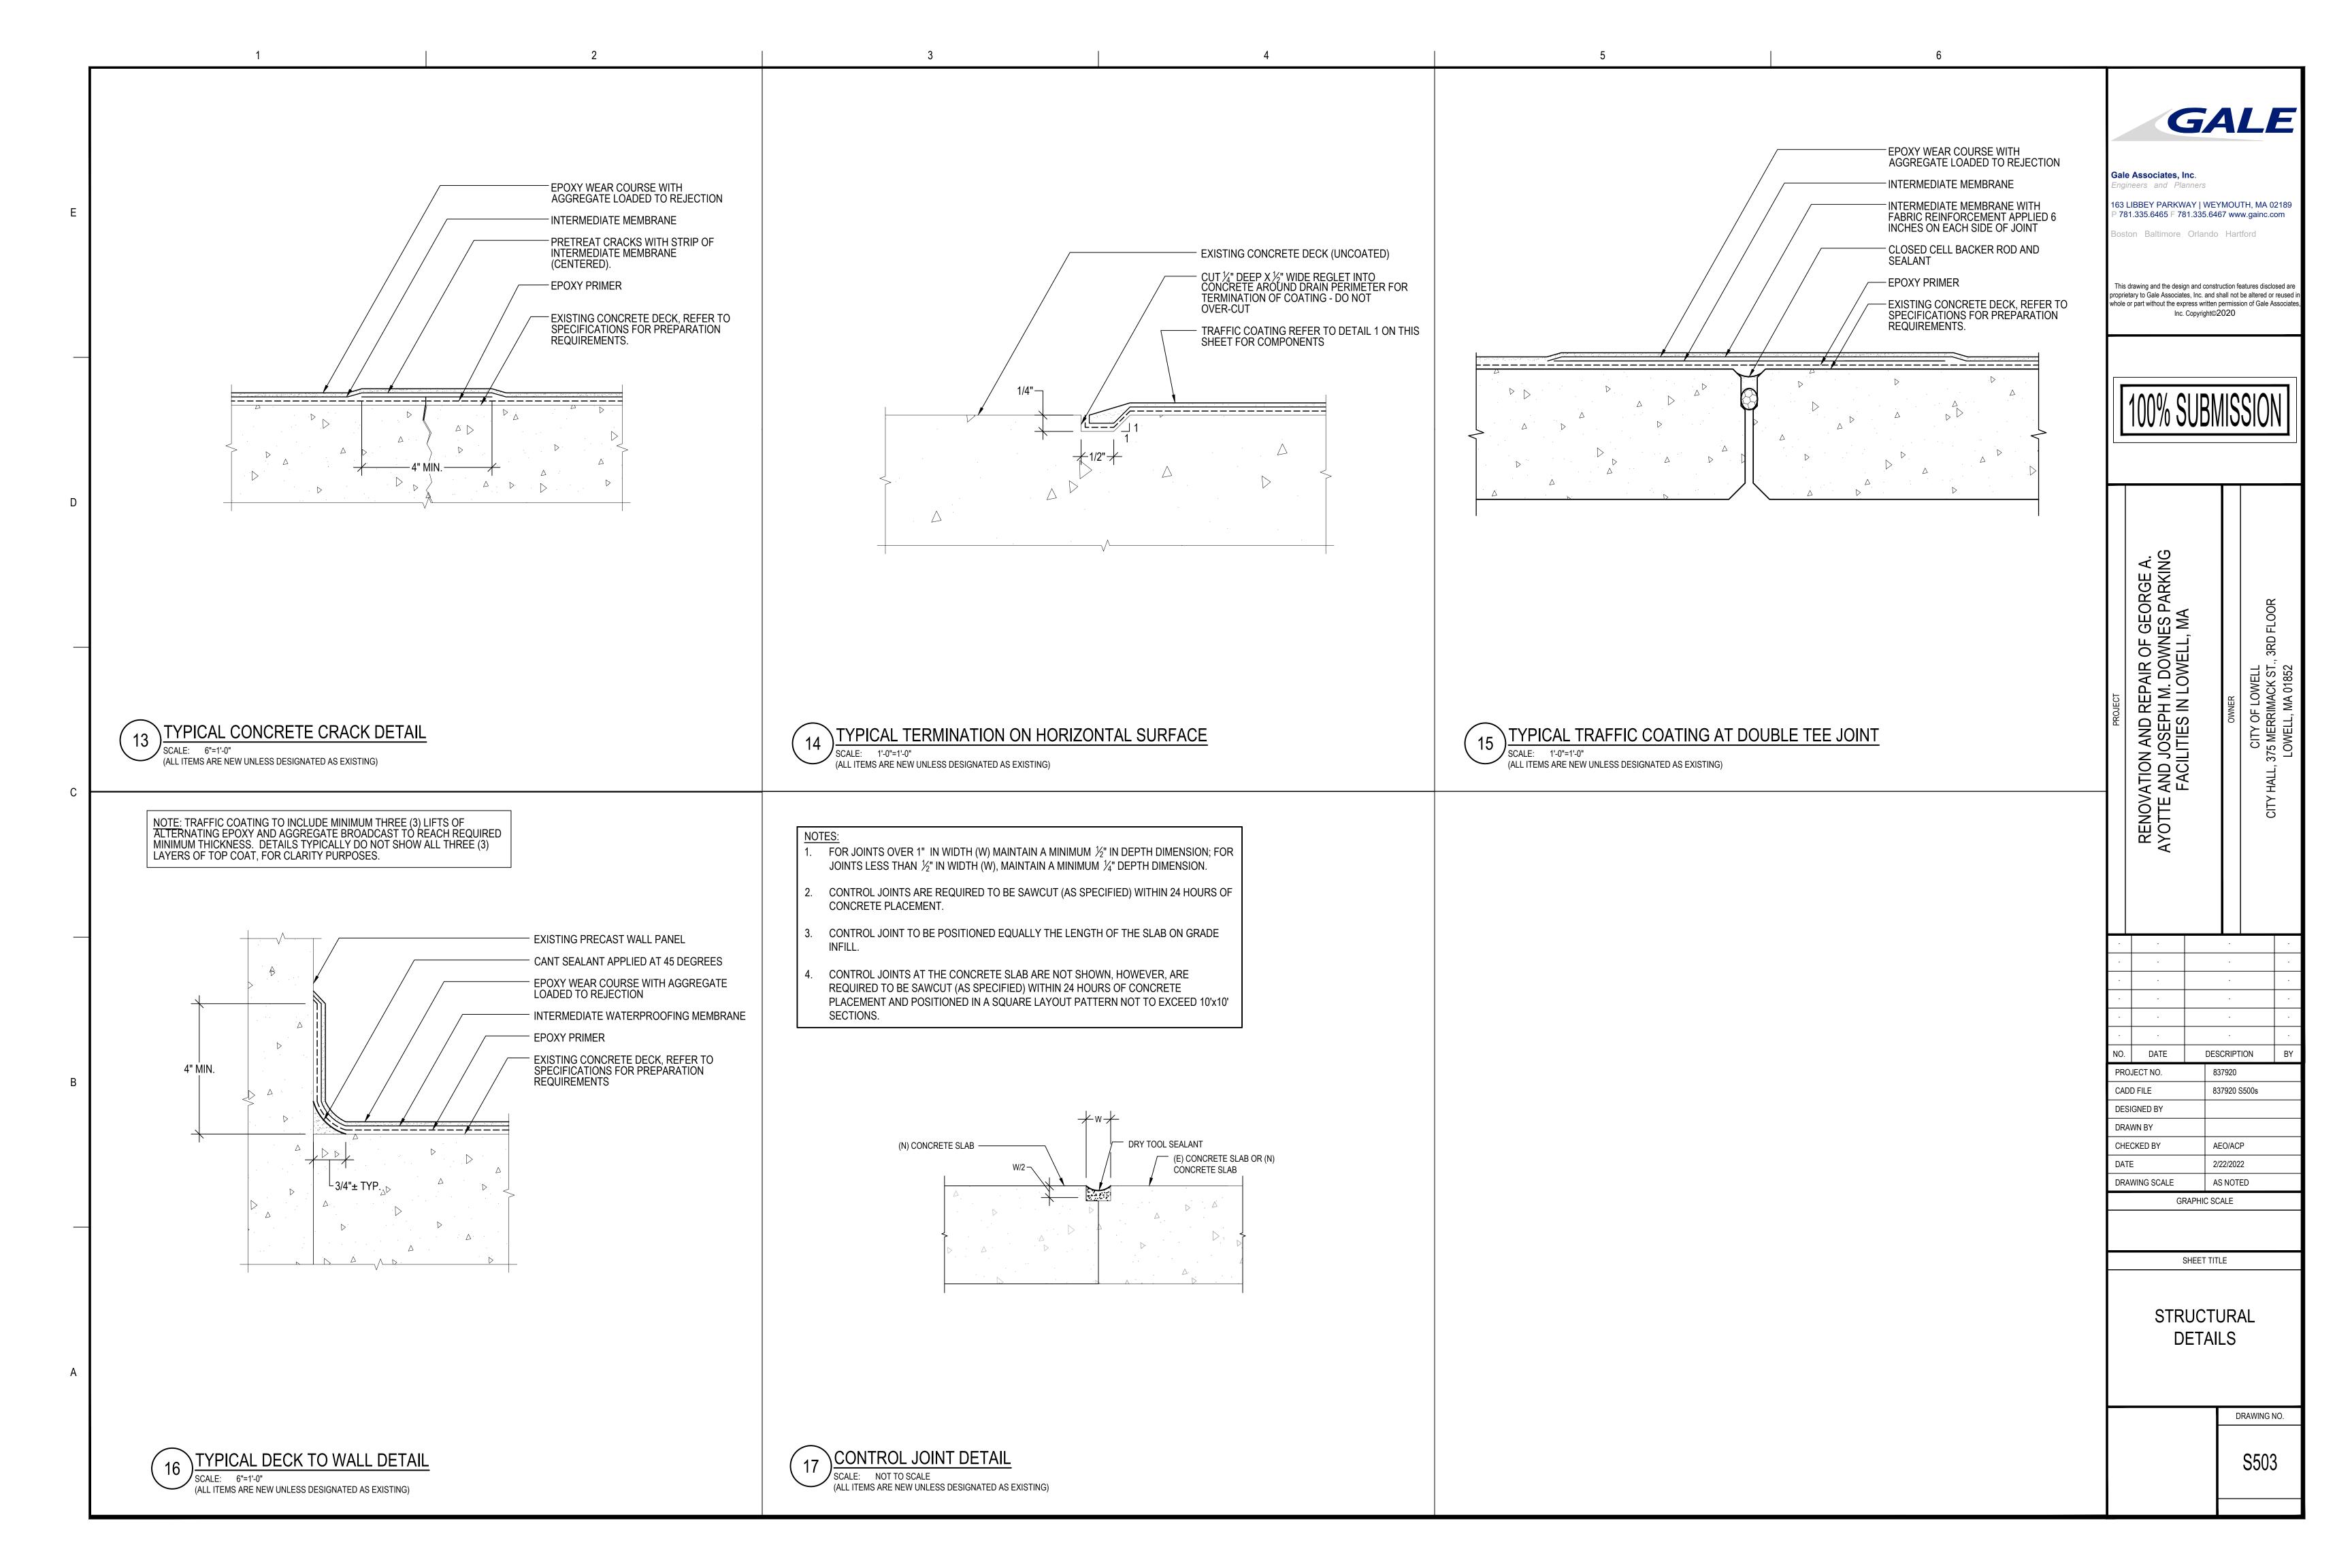

### SHORING LOADS

- 1. THE LOAD PROVIDED ARE FOR THE END REACTIONS OF THE MEMBERS AND ARE NOT THE FULL DEAD LOADS AND LIVE LOADS SUPPORTED BY THE ENTIRE MEMBER. THE LOADS PROVIDED ARE INTENDED TO BE UTILIZED BY THE SHORING CONTRACTOR, IN CONJUNCTION WITH A FACTOR OF SAFETY INCORPORATED BY THE SHORING CONTRACTOR, TO TEMPORARILY SUPPORT THE PARKING STRUCTURE DURING CONSTRUCTION.
- 2. THE LOADS PROVIDED ARE SERVICE LEVEL LOADS AND ARE NOT FACTORED.
- 3. VEHICLE LIVE LOADS ARE INCLUDED SEPARATELY FROM THE DEAD LOADS. THE CITY OF LOWELL HAS INDICATED THAT THE CONTRACTOR SHALL MAKE EVERY EFFORT TO KEEP THE GARAGE OPEN FOR PARKING PATRONS, SO LIVE LOAD SHALL BE USED FOR THE SHORING DESIGN.
- SNOW LOADS ARE NOT INCLUDED. IF SHORING TO REMAIN IN PLACE DURING A SNOW EVENT, THERE SHALL BE NO PARKING ALLOWED AT THE ROOF LEVEL TO ACCOUNT FOR THE INCREASE IN LOADING IMPOSED BY SNOW.
- 5. THE DOUBLE TEE BEAM STEM LOADS AND INVERTED TEE BEAM GIRDER LOADS ARE PROVIDED IN TWO DIFFERENT WAYS FOR THE SHORING CONTRACTOR TO UTILIZE IN THE SHORING DESIGN. IN SOME CASES, DOUBLE TEE BEAMS MAY BE SHORED DIRECTLY, FLOOR TO FLOOR, DOWN TO THE GROUND LEVEL. IN OTHER CASES, THE INVERTED TEE BEAMS MAY BE SHORED DIRECTLY FROM FLOOR TO FLOOR WHILE SUPPORTING THE DOUBLE TEE BEAMS.

DOUBLE TEE STEM LOADS (LOADS PER STEM PER LEVEL):

DEAD LOAD: DL<sub>DTSTEM</sub> = 15,100 LB/LEVEL

LIVE LOAD: LL<sub>DTSTEM</sub> = 7,200 LB/LEVEL

SPANDREL LOADS (LOAD PER SPANDREL PER LEVEL):

DEAD LOAD: DL<sub>SPAN</sub> = 66,000 LB/LEVEL

LIVE LOAD: LL<sub>SPAN</sub> = 22,320 LB/LEVEL

# TEMPORARY SHORING NOTES

- 1. THE SHORING CONTRACTOR MUST PROVIDE TEMPORARY SHORING SUPPORT OR SHORING AS REQUIRED TO PERFORM STRUCTURAL REPAIRS NOTED ON THESE DRAWINGS. ALL MEANS AND METHODS TO ACCOMPLISH THE INSTALLATION OF THE SHORING IS THE SOLE RESPONSIBILITY OF THE SHORING CONTRACTOR.
- 2. THE CONTRACTOR MUST SUBMIT SHOP DRAWINGS TO THE ENGINEER PRIOR TO THE PERFORMANCE OF ANY WORK SHOWING THE LOCATION, SIZE, DIMENSIONS, CAPACITY, DETAIL, WEIGHT, EQUIPMENT, ETC. OF ALL SUPPORTING MEMBERS AS WELL AS A TIME SCHEDULE AND SEQUENCE OF WORK INDICATING WHEN ALL PERTINENT ITEMS OF WORK WILL BE PERFORMED.
- 3. THE CONTRACTOR MUST SUBMIT DESIGN CALCULATIONS, SIGNED-AND-SEALED BY A REGISTERED PROFESSIONAL ENGINEER IN THE COMMONWEALTH OF MASSACHUSETTS, TO THE ENGINEER FOR REVIEW PRIOR TO OR INCLUSIVE WITH SHOP DRAWINGS
- 4. NO CONSTRUCTION WORK WILL COMMENCE UNTIL THE ENGINEER HAS REVIEWED THE SHORING SHOP DRAWINGS AND DESIGN CALCULATIONS.
- 5. CONTRACTOR MUST PROVIDE ADEQUATE LATERAL BRACING. ALL SHORING MUST BE CONTINUOUS THROUGH THE FLOOR LEVELS AND/OR SOLIDLY BLOCKED BETWEEN FLOORS. ALL SHORES MUST BE CARRIED DOWN TO FIRM BEARING MATERIAL AND THE LOAD MUST BE ADEQUATELY SPREAD OUT IF SUPPORTED ON THE EXISTING SLAB-ON-GRADE.
- 6. ANY DEFICIENCIES OR DAMAGE AS A RESULT OF SHORING SHALL BE THE CONTRACTOR'S RESPONSIBILITY AND SHALL BE RESTORED TO THE ORIGINAL CONDITION AT NO ADDITIONAL COST TO THE OWNER.
- 7. DESIGN, CONSTRUCTION, AND MAINTENANCE OF TEMPORARY SHORING MUST ALLOW FOR ONE-LANE OF TRAVEL AT GARAGE FLOORS TO BE MAINTAINED AT ALL TIMES. THE GARAGE WILL REMAIN OPEN THROUGHOUT THE DURATION OF THE CONSTRUCTION.
- 8. EXISTING DECORATIVE METAL FRAMES MAY NEED TO BE REMOVED TO INSTALL SHORING. SHORING DESIGNER TO EVALUATE. GC TO INCORPORATE REMOVAL AND REINSTALLATION OF FRAMES AS REQUIRED BY THE SHORING

PRECAST DOUBLE TEE BEAM, TYP. **CUMULATIVE SHORING LOADS** ROOF LEVEL SPANDREL SHORES (FIFTH TO ROOF): POST SHORES (FIFTH TO ROOF):  $DL_{DTSTEM} = 15,100 LBS$  $DL_{SPAN} = 66,000 LBS$  $LL_{DTSTEM} = 7,200 LBS$  $LL_{SPAN} = 22,320 LBS$ \_\_\_\_ -POST SHORING, TYP. REFER TO CUMULATIVE PRECAST SPANDREL -SHORING LOADS FOR BEAM, TYP. REQUIRED CAPACITY FIFTH LEVEL POST SHORES (FOURTH TO FIFTH): SPANDREL SHORES (FOURTH TO FIFTH):  $DL_{DTSTEM} = 30,200 LBS$  $DL_{SPAN}$  = 132,000 LBS LL<sub>DTSTEM</sub> = 14,400 LBS SPANDREL SHORING, TYP.—  $LL_{SPAN} = 44,640 LBS$ REFER TO CUMULATIVE SHORING LOADS FOR REQUIRED CAPACITY FOURTH LEVEL POST SHORES (THIRD TO FOURTH): SPANDREL SHORES (THIRD TO FOURTH):  $DL_{DTSTEM} = 45,300 LBS$ DL<sub>SPAN</sub> = 198,000 LBS LL<sub>DTSTEM</sub> = 21,600 LBS LL<sub>SPAN</sub> = 66,960 LBS POST SHORES (SECOND TO THIRD): SPANDREL SHORES (SECOND TO THIRD):  $DL_{DTSTEM} = 60,400 LBS$  $DL_{SPAN} = 264,000 LBS$ LL<sub>DTSTEM</sub> = 28,800 LBS  $LL_{SPAN}$  = 89,280 LBS BRICK FACADE — SECOND LEVEL SPANDREL SHORES (FIRST TO SECOND): POST SHORES (FIRST TO SECOND):  $DL_{DTSTEM} = 75,500 LBS$ DL<sub>SPAN</sub> = 330,000 LBS LL<sub>SPAN</sub> = 111,600 LBS LL<sub>DTSTEM</sub> = 36,000 LBS REFER TO TEMPORARY -SHORING NOTE 8 POST SHORES (LOWER TO FIRST): SPANDREL SHORES (LOWER TO FIRST):  $DL_{DTSTEM} = 90,600 LBS$ DL<sub>SPAN</sub> = 396,000 LBS LL<sub>SPAN</sub> = 133,920 LBS  $LL_{DTSTEM} = 43,200 LBS$ POST SHORES (LOWER LEVEL): SPANDREL SHORES (LOWER LEVEL):  $DL_{DTSTEM} = 105,700 LBS$  $DL_{SPAN} = 462,000 LBS$  $LL_{DTSTEM} = 50,400 LBS$  $LL_{SPAN}$  = 156,240 LBS LOWER LEVEL 



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PROJECT	RENOVATION AND REPAIR OF GEORGE A. AYOTTE AND JOSEPH M. DOWNES PARKING FACILITIES IN LOWELL, MA			OWNER	CITY OF LOWELL CITY HALL 375 MFRRIMACK ST. 3RD FLOOR	LOWELL, MA 01852
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NO. DATE			DESCRIPTION			BY
PROJECT NO.			837920			

CADD FILE

DESIGNED BY

DRAWN BY

CHECKED BY

AEO/ACP

DATE

2/22/2022

DRAWING SCALE

GRAPHIC SCALE

SHEET TITLE

JOPSEPH M. DOWNES
GARAGE
TEMPORARY SHORING
DETAIL

S504

DRAWING NO.



- TRANSFORMER PRIMARY TRANSFORMER -FLEX CONDUIT TRANSFORMER SECONDARY **ENCLOSURE** OVERCURRENT DEVICE OVERCURRENT DEVICE NOTES: 1. BOND AND GROUND TRANSFORMER PER NEC ARTICLE 250.30. 2. CONNECT TRANSFORMER GROUNDING ELECTRODE II в CONDUCTOR TO NEAREST GROUNDING ELECTRODE (BUILDING STEEL, GROUND ROD, OR METAL WATER PIPE). 3. ALL CONDUCTOR SIZES ARE FOR COPPER —NEUTRAL BUS CONDUCTORS. NEC TABLE 310.16. 4. SECONDARY OVERCURRENT PROTECTION SHALL BE LOCATED WITHIN TEN (10) FETT OF THE TRANSFORMER SECONDARY TERMINALS EITHER IN A PANELBOARD (MAIN BREAKER) OR A G INDIVIDUALLY MOUNTED CIRCUIT BREAKER. 5. TRANSFORMER BONDING JUMPER AND GROUNDING MOUNTED CIRCUIT BREAKER 6. TRANSFORMER BONDING JUMPER AND BONDING GROUNDING ELECTRODE CONDUCTOR JUMPER -480 VOLT PRIMARY MAIN BONDING JUMPER -208/120 VOLT — 600KCMIL CONDUCTORS AND LARGER SHALL BE SECONDARY FEEDER PROVIDED WITH MAC ADAPTERS AS REQUIRED TO GROUNDING ELECTRODE — LEQUIPMENT GROUND FEEDER EQUIPMENT -COORDINATE WITH BREAKER LUG SIZES. CONDUCTOR **GROUND BUS** GROUNDING -ELECTRODE SYSTEM PANEL · **ENCLOSURE** TYPICAL DRY TYPE TRANSFORMER WIRING DETAIL


### ELECTRICAL LEGEND

120/208V,3Ø,4W SURFACE MOUNTED PANEL, "N22A" INDICATES PANEL



DISCONNECT SWITCH (FUSED), "AS" INDICATES AMPERE SWITCH RATING, "AF" INDICATES AMPERE FUSÉ RATING.



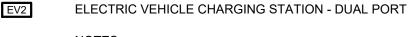

"WP" - INDICATES WEATHERPROOF - NEMA 3R

#### PROJECT GENERAL NOTES

- THE CONTRACTOR SHALL FURNISH LABOR, MATERIALS, TOOLS AND OTHER EQUIPMENT REQUIRED TO INSTALL THE WORK SHOWN AND SPECIFIED. THE CONTRACTOR SHALL FURNISH AND INSTALL ITEMS NECESSARY FOR A COMPLETE ELECTRICAL SYSTEM. MATERIALS SHALL BE NEW AND SHALL BEAR THE REGISTERED UL MARK. WORK SHALL CONFORM WITH THE NATIONAL FIRE PROTECTION ASSOCIATION STANDARD 70 (NEC), THE NATIONAL ELECTRICAL CODE (NEC), AND APPLICABLE FEDERAL, STATE AND LOCAL CODES. CONTRACTOR SHALL SECURE PERMITS AND PAY THE FEES REQUIRED TO CARRY OUT HIS WORK. THE CONTRACTOR SHALL FURNISH COPIES OF CERTIFICATES AND PERMITS TO THE ARCHITECT.
- . THE DRAWINGS AND SPECIFICATIONS INDICATE THE INTENT OF THE DESIGN AND SHALL BE CONSIDERED AS DIAGRAMMATIC ONLY. EXACT LOCATIONS FOR OUTLETS AND EQUIPMENT SHALL BE DETERMINED AT THE SITE, AS WORK PROGRESSES DIMENSIONS AND CONDITIONS SHALL BE CHECKED AND VERIFIED BY THE CONTRACTOR AT THE SITE. FINAL WORK SHALL BE DOCUMENTED ON AS BUILT RECORD DRAWINGS.
- PIPING, CONDUITS AND EQUIPMENT OF ALL TRADES SHALL BE PROPERLY COORDINATED AND SET TO MAINTAIN THE CLEARANCES REQUIRED BY APPLICABLE FEDERAL, STATE AND LOCAL CODES.
- . CONDUIT RUNS CROSSING EXPANSION JOINTS SHALL HAVE EXPANSION OR EXPANSION DEFLECTION TYPE FITTINGS, AS REQUIRED VERIFY EXISTING JOINTS BY FIELD MEASUREMENTS. ALL EXTERIOR ROOF CONDUITS SHALL HAVE EXPANSION
- CONDUCTOR. COMMON OR SHARING OF NEUTRALS WILL NOT BE ALLOWED. NO MORE THAN (3) CIRCUITS (SIX CURRENT CARRYING CONDUCTORS) SHALL BE RUN IN A SINGLE CONDUIT.
- 6. THIS IS A STANDARD SYMBOL LIST. ALL DEVICE SYMBOLS AND ABBREVIATIONS MAY NOT NECESSARILY APPEAR ON THE FLOOR PLANS OR DETAIL SHEET. ONLY THOSE SYMBOLS INDICATED ON THE FLOORS PLANS ARE USED AND OTHERS SHOULD BE DISREGARDED.
- 7. CURRENT CARRYING MATERIAL USED SHALL BE COPPER.
- 8. FURNISH GROUNDING/ BONDING BUSHINGS ONTO ALL CONDUIT ENTERING/ LEAVING BOXES.
- 9. ALL GROUND CONDUCTORS SHALL BE GREEN, ISOLATED GROUND CONDUCTORS SHALL BE GREEN/ YELLOW STRIPED, AND NEUTRAL CONDUCTORS SHALL BE WHITE.



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ATION AND REPAIR OF GEORGE AND JOSEPH M. DOWNES PARKI FACILITIES IN LOWELL, MA NOV. REI AYO

DESCRIPTION

PROJECT NO. 837920 CADD FILE **DESIGNED BY** DRAWN BY CHECKED BY 02/14/2022

DRAWING SCALE GRAPHIC SCALE

SHEET TITLE

ELECTRICAL LEGEND & GENERAL NOTES


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RWS JOB # 210175.00

DRAWING NO. E000



**3 POLE CIRCUIT BREAKERS** 

50A 60A 70A

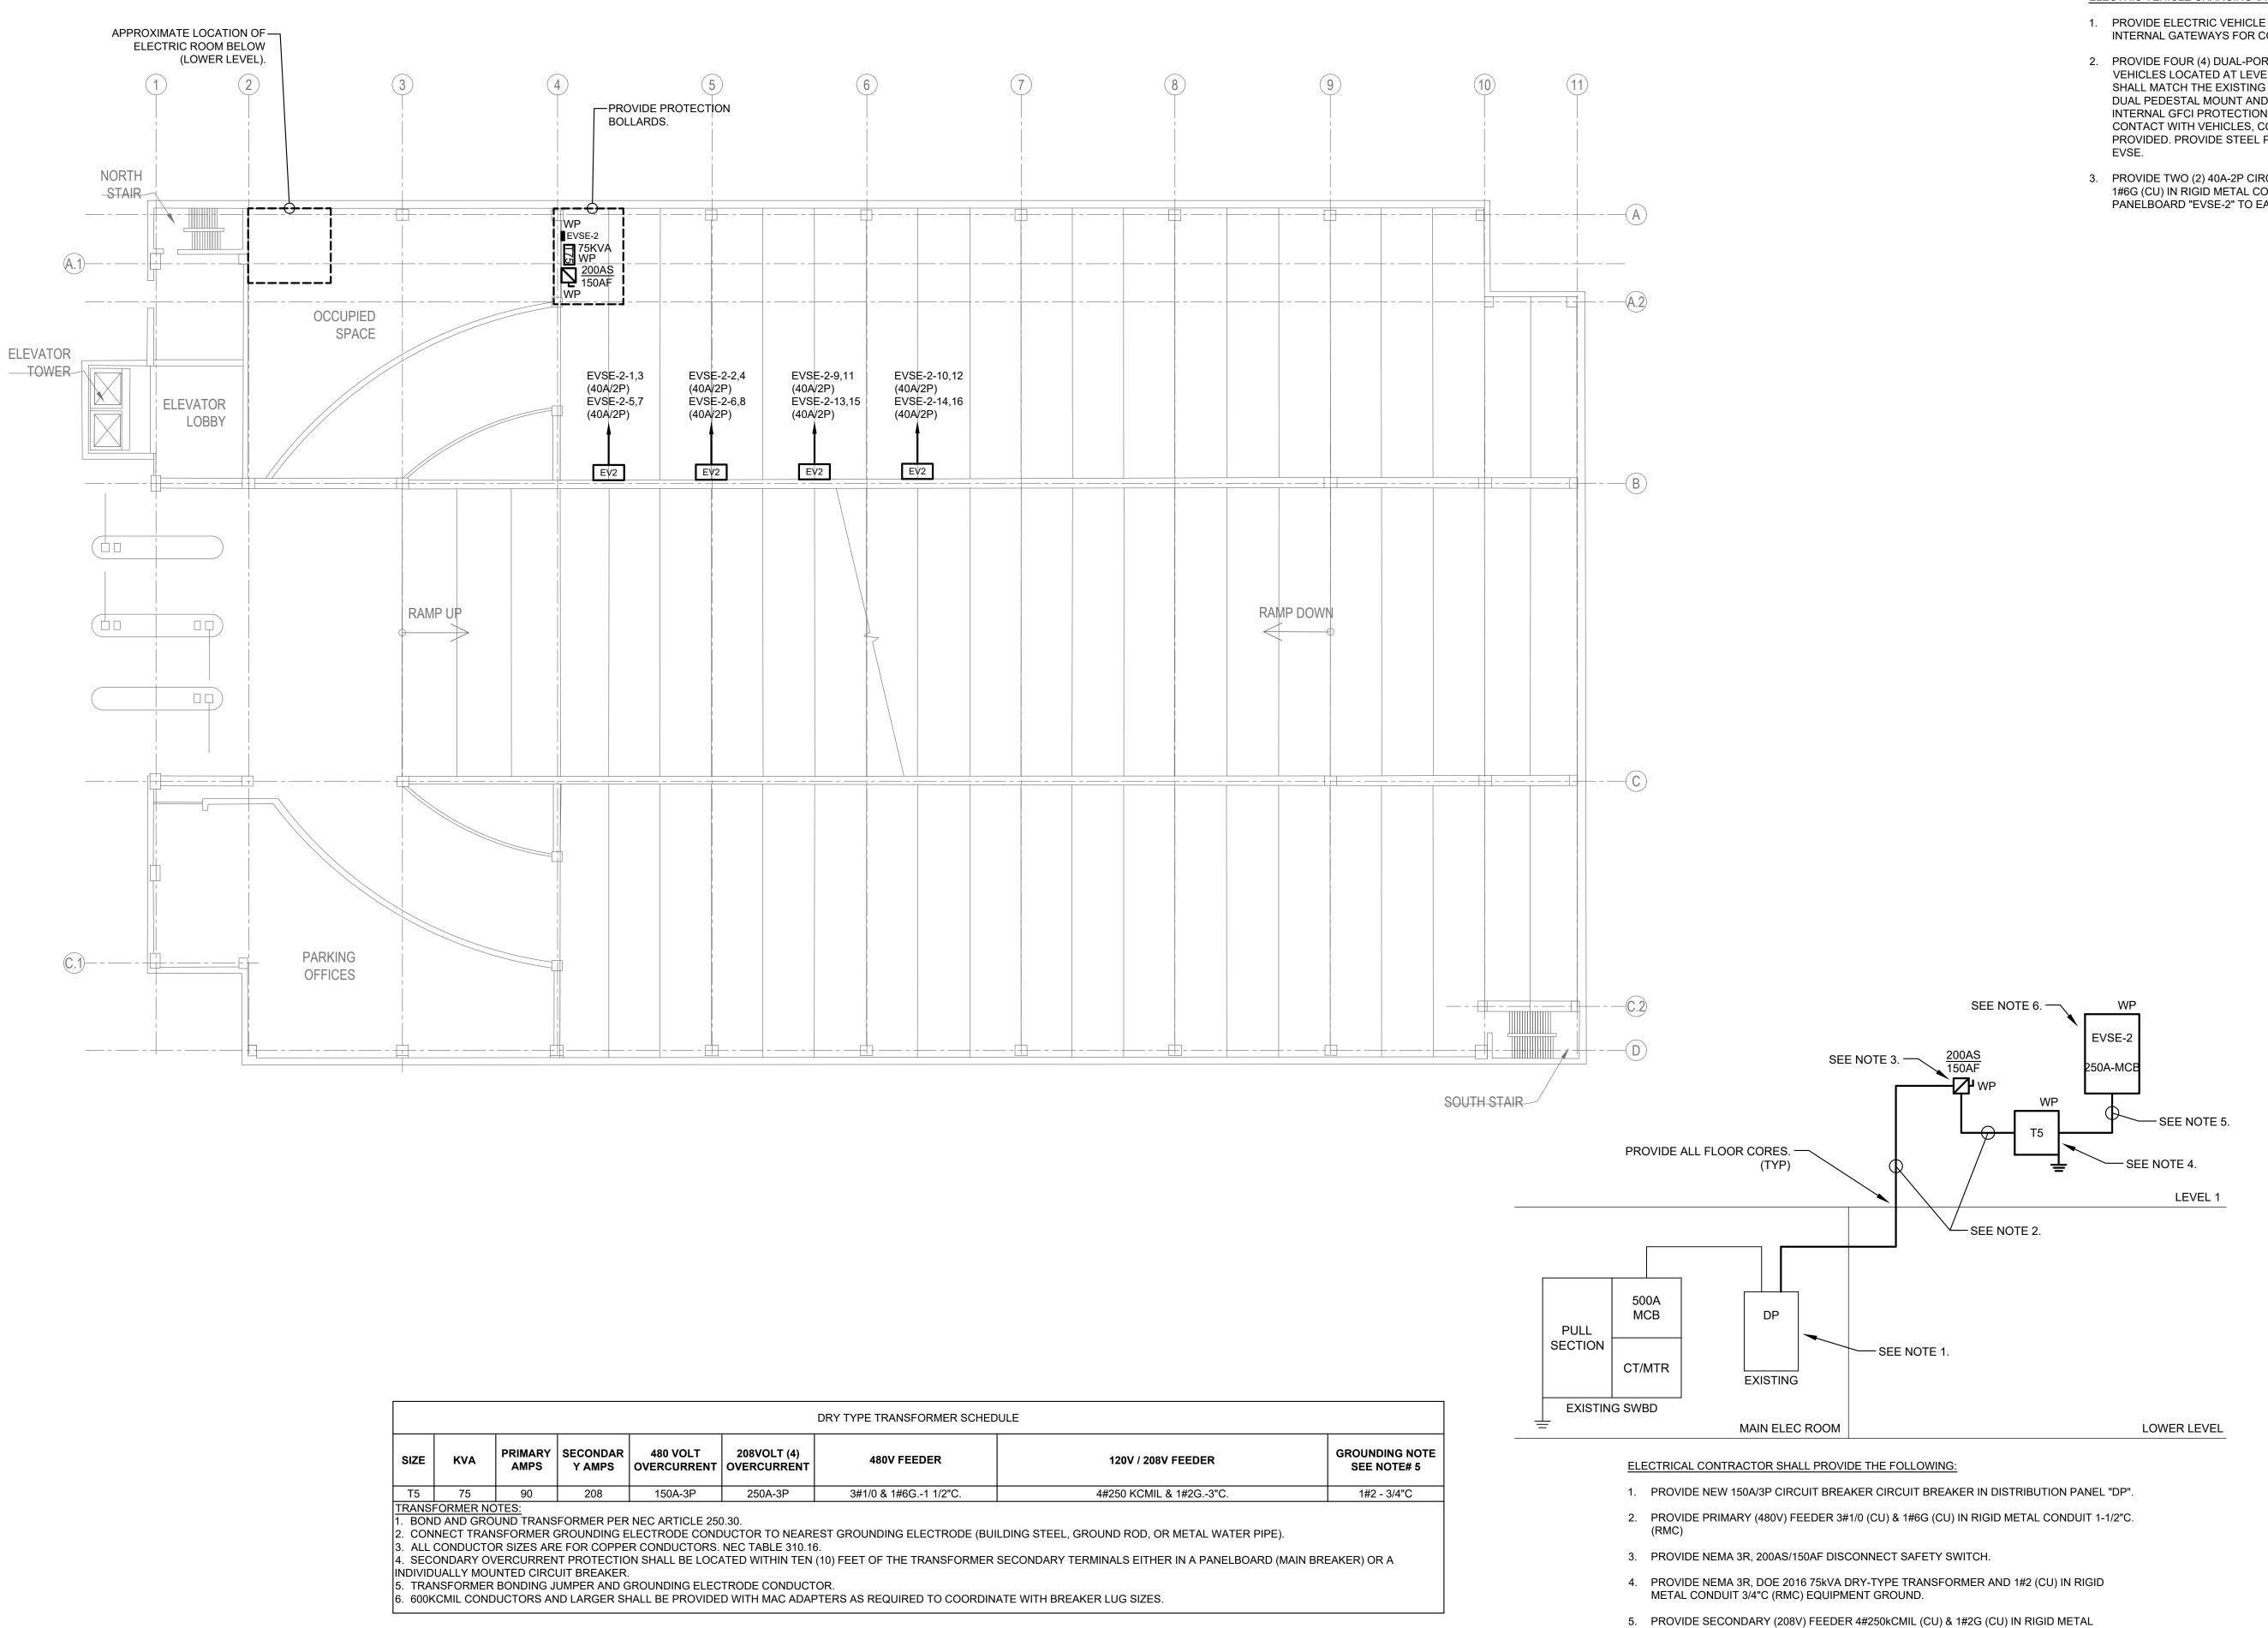SCHEDULE OF PANELBOARDS (208 / 120 VOLT, 3 PHASE, 4 WIRE)

40A 50A

60A

15A 20A 30A

40A

2 POLE CIRCUIT BREAKERS

20A

15A


MTG. RATING POLES

MCB MLO

1 POLE CIRCUIT BREAKERS

ELECTRIC VEHICLE CHARGING STATIONS:

1. PROVIDE ELECTRIC VEHICLE SUPPLY EQUIPMENT (EVSE) AND INTERNAL GATEWAYS FOR CONNECTIVITY.

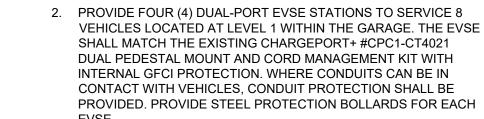

3. PROVIDE TWO (2) 40A-2P CIRCUIT BREAKERS AND 4#6 (CU) & 1#6G (CU) IN RIGID METAL CONDUIT 1" C (RMC) FROM 208V PANELBOARD "EVSE-2" TO EACH DUAL-PORT EVSE STATION.



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PROJECT	RENOVATION AND REPAIR OF GEORGE A. AYOTTE AND JOSEPH M. DOWNES PARKING		OWNER	CITY OF LOWELL CITY HALL 375 MFRRIMACK ST 3RD FLOOR	LOWELL, MA 01852
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NO. DATE DESCRIPTION PROJECT NO. 837920

CADD FILE DESIGNED BY GCH DRAWN BY ZWP CHECKED BY 02/14/2022

DRAWING SCALE 1/16"=1'0" GRAPHIC SCALE

SHEET TITLE

DOWNES GARAGE -LEVEL 1 -ELECTRICAL PLAN

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CONDUIT 3"C. (RMC)

NOTES

NEMA 3R

SPACES


40A/2P CIRCUIT BREAKERS.

6. PROVIDE NEMA 3R, 250A MCB, 208Y/120V, 3-PHASE, 4-WIRE, 30-CKT PANELBOARD WITH (8)

1 ELECTRICAL ONE-LINE RISER DIAGRAM

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DRAWING NO. E101

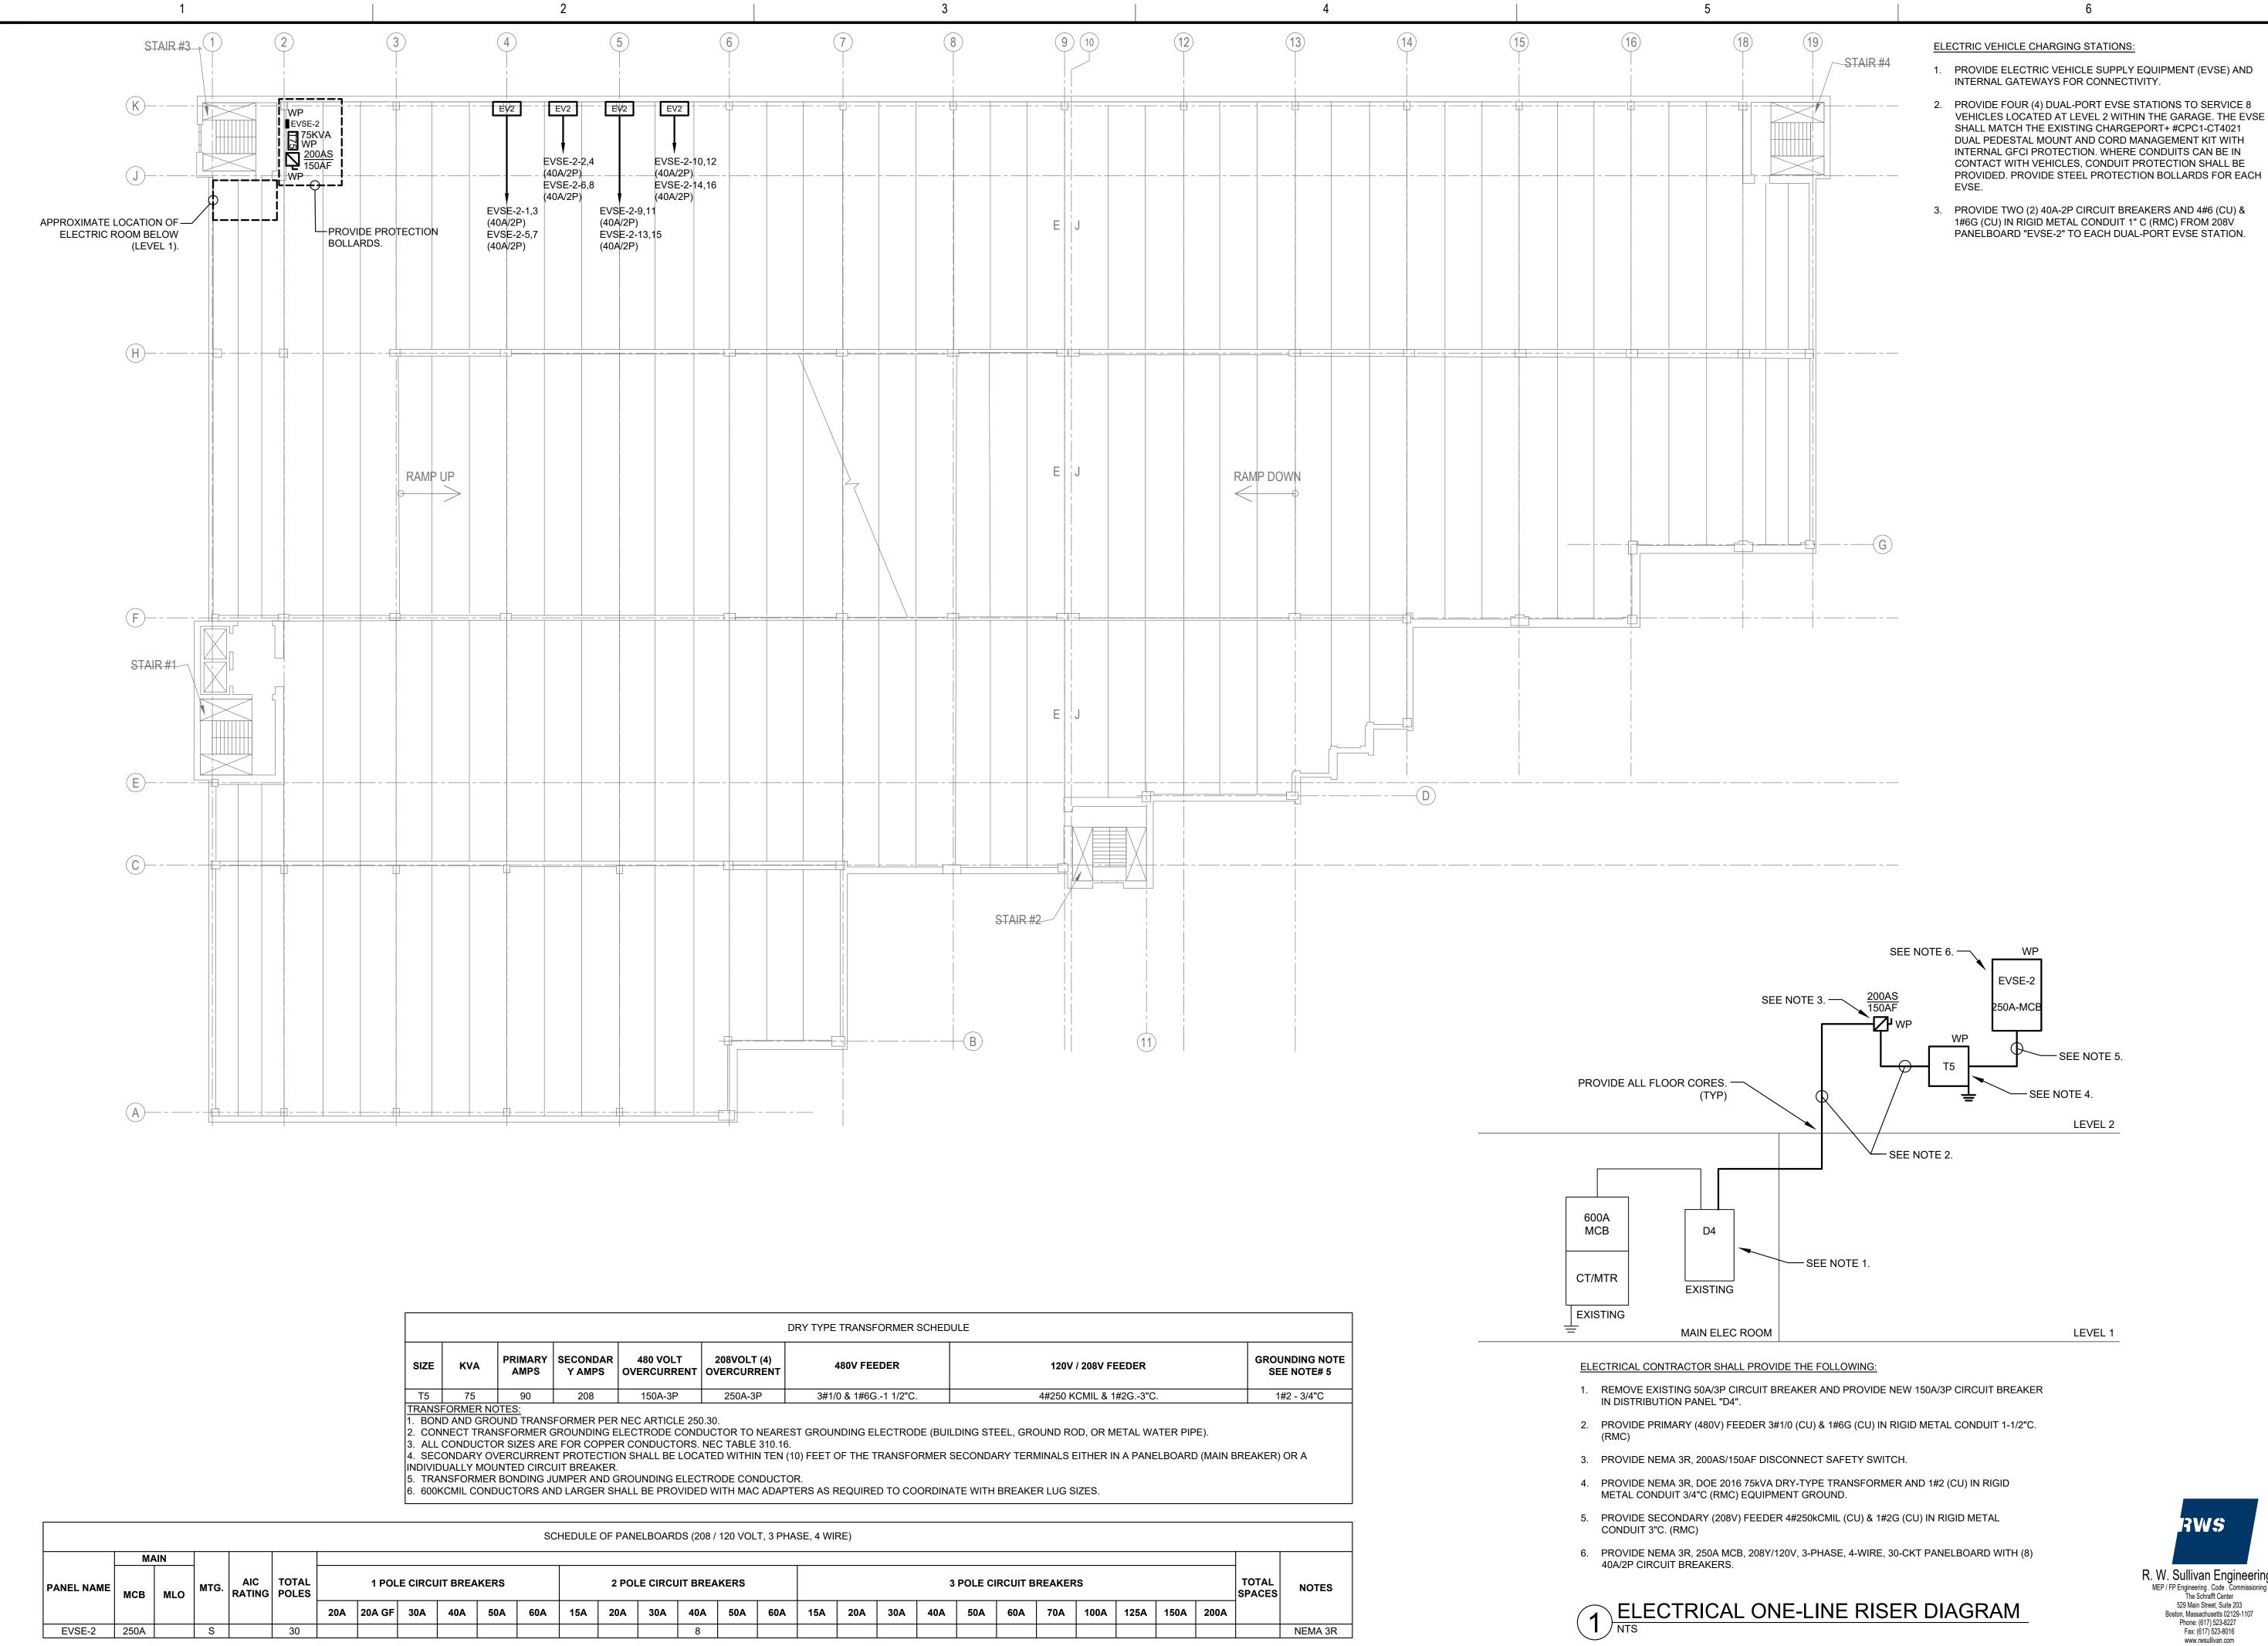

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DATE DESCRIPTION PROJECT NO. 837920

CADD FILE DESIGNED BY DRAWN BY CHECKED BY 02/14/2022

DRAWING SCALE 1/16"=1'0" GRAPHIC SCALE

SHEET TITLE

**AYOTTE GARAGE -**LEVEL 2 -ELECTRICAL PLAN

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